

ARCHITECTURAL GUIDANCE DRAWINGS

MARCH 2024

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ARCHITECTURAL GUIDANCE DRAWINGS

APPLICABILITY OF CURRENT VERSION

SUPERSEDES AUGUST 2019 VERSION

FOR PROJECTS THAT ARE BASELINED AFTER MARCH 29, 2024

GUI-AZT001

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1		2/2024				2024 REVISED GUIDANCE DRAWINGS	
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SOUND TRANSIT GUIDANCE DRAWINGS ARCHITECTURAL INDEX OF DRAWINGS

GUI-AZI001 FACILITY ID:

SHEET No.:

DRAWING No.:

ABBREVIATIONS

A		BOH	BACK OF HOUSE	CORR	CONTROL VALVE	ENGR	ENGINEER	G G	CROUNDLINE
A/C ASPHALTIC CONCI A/G AT-GRADE		BOS BOW	BOTTOM OF STRUCTURE BACK OF WALK	CORR COV	CORRIDOR COVER	ENTR ENVIRON	ENTRANCE ENVIRONMENTAL	G/L GA	GROUND LINE GAUGE
A/S ACRYLIC-LATEX SI	ALANT	BPP	BRANCH POWER PANEL	CP	CONCRETE PIPE	EPF	ELEVATOR SHAFT PRESSURIZATION FAN	GALV	GALVANIZED
A/V AUDIO VISUAL		BR	BRIDGE	CPLG.	COUPLING	EQPT	EQUIPMENT	GALVS	GALVANIZED STEEL
AAV AUTOMATIC AIR VI AB ANCHOR BOLT		BRG BRG PLT	BEARING BEARING PLATE	CPT CRS	CONTROL POWER TRANSFORMER COLD ROLLED STEEL	EQ ESMT	EQUAL EASEMENT	GB GDR/ GDR-#	GRAB BAR GUARDRAIL/ GUARDRAIL SYSTEM - TYPE
ABUT ABUTMENT		BRKT	BRACKET	CS	CURVE TO SPIRAL	ESC	ESCALATOR	GEN GEN	GENERATOR
ABV ABOVE	_	BS	BOTH SIDES	CS-#	CONCRETE SEALER - TYPE	ETEL	EMERGENCY TELEPHONE SYSTEM	GFI	GROUND FAULT INTERRUPTER
AC ALTERNATING CUI ACCP AIR CONDITIONING	_	BSMT BVL	BASEMENT BEVELED	CSM CSMT	COMBINED SEWER MANHOLE CASEMENT	ETS EVS	EMERGENCY TRIP STATION EMERGENCY VENTILATION SYSTEM	GH	GROUND HYDRANT
CCP AIR CONDITIONING CI AMERICAN CONCE	_	BW	BOTH WAYS	CSP	CONCRETE SEWER PIPE	EW	EACH WAY	GL GL-#	GLAZING GLAZING - TYPE
ACOUS ACOUSTICAL		BZ	BRONZE	CST	CAST STONE	EWC-#	RESIN WALL PANEL - TYPE	GM	GAS METER
ACOUS PNL ACOUSTICAL PANE				CSK	CASEWORK	EWH EWS	ELECTRIC WATER HEATER EYE WASH STATION	GND	GROUND
ACPL AUXILIARY CONTR ACR ACCESS CARD RE		С		CT CTB	CERAMIC TILE CEMENT TREATED BASE	EXF	EXHAUST FAN	GP-#	GRAFITTI COATING - TYPE
CS ACCESS		C&C	CUT-AND-COVER	CTRL	CONTROL	EXH	EXHAUST	GR GRAN	GRADE GRANITE
CS DR ACCESS DOOR		C&G	CURB AND GUTTER	CTY	CABLE TRAY	EXP	EXPANSION	GRD	GROUNDING DEVICE
		C&S	COMMUNICATION AND SIGNALS	CU CULV	CUBIC CULVERT	EXPO EXT	EXPOSED EXTERIOR	GRL-#	GRILLE - TYPE (OVERHEAD COILING GRILLE)
CT ACOUSTICAL TILE CU AIR CONDITIONING		C/C C/B	CENTER TO CENTER COVE BASE	COLV	CONTROL VALVE	EXT	EXTENSION	GRS	GALVANIZED RIGID STEEL
D AREA DRAIN		C/G	CORNER GUARD	CW-#	CURTAIN WALL - TYPE			GRSC GRTG-#	GALVANIZED RIGID STEEL CONDUIT GRATING TYPE
DD ADDENDUM, ADDE		C/L	CURB LINE	CWP-#	CEMENT WALL PANEL - TYPE	F		GRX	GRADE CROSSING
DJ ADJACENT		C/S	COUNTERSUNK			F/R F/T	FIRE RATED FIXED TERMINATION	GS-#	GYPSUM SHEATHING - TYPE
ESS ARCHITECTURALL FF ABOVE FINISHED F		CAB CANT	CABINET CANTILEVER	l D		FA	FIRE ALARM	GSC GSP	GALVANIZED STEEL CONDUIT GALVANIZED STEEL PIPE
G ABOVE FINISHED (GRADE C	CAT	CATENARY	D	DEPTH	FABX	FIRE ALARM BOX	GVP	GAS VENT PIPE
GG AGGREGATE		CATV	CABLE TELEVISION	DA	DIRECTIONAL ANTENNA	FAC	FACILITY	GWB	GYPSUM WALL BOARD
GG B AGGREGATE BASE		CBL CBB-#	CABLE CEMENTITIOUS BACKED BOARD TYPE	DBA	DEFORMED BAR ANCHOR	FACP FAF	FIRE ALARM CONTROL PANEL FRESH AIR FAN	GYP	GYPSUM
GG SB AGGREGATE SUB- HCP AIR HANDLING CO		CBB-#	CEMENTITIOUS BACKER BOARD - TYPE CENTRAL CONTROL	DBL DC	DOUBLE DIRECT CURRENT	FAF-#	FLUID APPLIED FLOORING - TYPE		
IU AIR HANDLING UN	Т	CCTV	CLOSED CIRCUIT TELEVISION	DEF	DEFLECTION	FAI	FRESH AIR INTAKE	lн	
		CCW	COUNTER CLOCKWISE	DEF JT	DEFLECTION JOINT	FB	FLAT BAR	H/R	HEAD ROOM
LM ALARM LUM ALUMINUM		CD	COLD DRAWN CONSTRUCTION EASEMENT	DEG	DEGREE	FC-# FCC	FLUOROPOLYMER COATING - TYPE FIRE COMMAND CENTER	H/W	HOT WATER
NC ANCHOR		CED	CONCRETE ENCASED DUCTBANK	DEL	DELETE DRINKING FOUNTAIN	FCU	FAN COIL UNIT	HB	HOSE BIBB
NOD ANODIZE(D)		CEM	CEMENT	DH	DUCT HEATER	FCWP-#	FIBER CEMENT WALL PANEL - TYPE	HC HDPE	HOLLOW CORE HIGH DENSITY POLYETHELINE
			CEMENT BOARD	DI	DROP INLET	FD FDC	FLOOR DRAIN FIRE DEPARTMENT CONNECTION	HDR	HEADER
IT ANTENNA P-# ACOUSTICAL PLAS		CEM PLAS CER	CEMENT PLASTER CERAMIC	DID DIFF	DOOR INTRUSION DEVICE DIFFUSER	FDR	FEEDER	HDW	HARDWARE
PT AUXILIARY POWER		CF	CUBIC FEET	DISC	DISCONNECT	FE-#	FIRE EXTINGUISHER - TYPE	HEX	HEXAGONAL
RC ABRASION RESIST		CF-#	CEMENTITIOUS FIREPROOFING - TYPE	DISC SW	DISCONNECT SWITCH	FEC-#	FIRE EXTINGUISHER CABINET - TYPE	HH HK	HANDHOLE HOOK
RV AIR RELIEF VALVE		CFF	CAP FOR FUTURE	DISTR	DISTRIBUTION	FEWB	FIRE EXTINGUISHER WALL BRACKET	HM	HOLLOW METAL
ASA AMERICAN STAND ASSEMBLY		CFLG	COUNTERFLASHING CONCRETE GUTTER	DL DN	DEAD LOAD DOWN	FF FHMS	FLEXIBLE FLASHING FLAT HEAD MACHINE SCREW	HMD	HOLLOW METAL DOOR
		CG CG-#	CORNER GUARDS - TYPE	DOR	DESIGNER OF RECORD	FHV	FIRE HOSE VALVE	HMF HNDRL-#	HOLLOW METAL FRAME HANDRAIL - TYPE
TB ASPHALT TREATEI		CHAM	CHAMFER	DP	DAMPPROOFING	FIN	FINISH	HO	HAND OPERATED
TCH ATTACH TR ABOVE TOP RAIL		CHD	CHORD	DPR	DAMPER	FIX	FIXED	HP	HIGH PRESSURE
TR ABOVE TOP RAIL UX AUXILIARY		CHK CHWS	CHECK CHILLED WATER SUPPLY	DR DRN	DOOR DRAIN	FIXT FLEX	FIXTURE FLEXIBLE	HPC-#	HIGH PERFORMANCE COATING - TYPE
WG AMERICAN WIRE G	AUGE	CIP	CAST-IN-PLACE	DS	DOWNSPOUT	FLH	FLAT HEAD	HPT HRL	HIGH POINT HIGH RAIL LEVEL
		CIP-#	CAST-IN-PLACE CONCRETE - TYPE	DSP	DRY STANDPIPE	FLR	FLOOR	HS	HIGH STRENGTH
WS AMERICAN WELDII	IG SOCIETY	CIRC	CIRCULAR / CIRCULATION	DWR	DRAWER	FLRH FLSH	FLOOR HYDRANT FLASHING	HSS	HOLLOW STEEL SECTION
		CK	CONTROL JOINT CREEK	DX	DIRECT EXPANSION	FLUOR	FLUORESCENT	HTR	HEATER
		CL	CLASS	_		FME-#	FORMED METAL ENCLOSURE - TYPE	HV HVAC	HIGH VOLTAGE HEATING, VENTILATING & AIR CONDITIONING
BOTTOM OF		CLEF	CHAIN LINK FENCE	E/P	EDGE OF PAVEMENT	FMP	FIRE MANAGEMENT PANEL	HW	HEADWALL
SPAN BODY SPAN		CLG-# CLGH	CEILING - TYPE CEILING HANGAR	E/S	EDGE OF PAVEMENT EDGE OF SHOULDER	FN FND	FENCE FOUNDATION	HWT	HOT WATER TANK
B BACK-TO-BACK F BUTTERFLY VALVE		CLGR	CEILING HANGAR CEILING SUPPORT	EA	EACH	FOB	FACE OF BRICK	HYD HZ	HYDRANT HERTZ
W BALANCE WEIGHT		CLO	CLOSET	EBC	EMBEDDED CONDUIT	FOC	FACE OF CURB	ΠΔ	HENIZ
AL BALANCE		CLP	CONCRETE LIGHT POLE CLEAR	ECS EDD	ENVIRONMENTAL CONTROL SYSTEM EXHAUST DUCT DAMPER	FOF	FACE OF FINISH		
D-# BIRD CONTROL DE P BRANCH CIRCUIT I	-	CLR CMH	CLEAR COMMUNICATIONS MANHOLE	EDL	ELECTRIC DOOR LOCK	FOP FOS	FACE OF POLE FACE OF STRUCTURE	1	
R BICYCLE CARD RE	ADER	CMP	CORRUGATED METAL PIPE	EF	EXHAUST FAN	FOW	FACE OF WALL	I/O	INPUT/OUTPUT
BOARD		CMU-#	CONCRETE MASONRY UNIT - TYPE	EFC	EXPOSED FINISH CONCRETE	FPRA	FALL PROTECTION ROOF ANCHOR	IA ID	INTRUSION ALARM INSIDE DIAMETER
BACKFILL BRICK INSTITUTE (CND CNR BD	CONDUIT CORNER BEAD	EFD EHC	EXHAUST FAN DAMPER ELECTRIC HEATING COIL	FPRF FDMA	FIREPROOF	IF	INSIDE DIAMETER INSIDE FACE
BRICK INSTITUTE (BITUMINOUS	. ,=	CNR BD	CENTER BEAD CENTER	EHC	EXTRA HIGH STRENGTH	FPWA FRT	FALL PROTECTION WALL ANCHOR FIRE RETARDANT TREAT WOOD	IJ	INSULATING JOINT
BITUMINOUS JOIN	FILLER	CO	CLEANOUT	El	ELECTRICAL INTERLOCK	FS	FAR SIDE	ILLUM	ILLUMINATED
BUILDING LINE		COL	COLUMN	EJ	EXPANSION JOINT	FTG	FOOTING	INC	INCH, INCHES INCLUDE
K BLOCK KG BLOCKING		COMB COMM	COMBINATION COMMUNICATIONS	EJC-# ELAST	EXPANSION JOINT COVER - TYPE	FTP FUR	FARE TRANSACTION PROCESSOR FURRING	INCD	INCANDESCENT
KG BLOCKING KR-# BICYCLE LOCKER :		COMPO	COMPOSITION	ELAST	ELASTOMERIC ELECTRICAL	FURN	FURNISH	IND	INDICATE
ST BALLAST	=	COMPT	COMPARTMENT	ELECPB	ELECTRIC PANELBOARD	FV	FIELD VERIFY	INFO INSUL-#	INFORMATION INSULATION - TYPE
1 BENCHMARK		CONC S#	CONSOLE CONCRETE SEALANT TYPE	ELEV	ELEVATOR	FVE	FARE VENDING EQUIPMENT	INT	INTERIOR
BURLINGTON NOR BOTTOM OF	• • • • •	CONC-S#	CONCRETE SEALANT - TYPE CONTINUOUS	EMB EMER	EMBEDMENT EMERGENCY	FVC FVEC	FIRE HOSE VALVE CABINET FIRE VALVE & EXTINGUISHER CABINET	INTERM	INTERMEDIATE
O BOTTOM OF OB BOTTOM OF BRICK		CONTR	CONTRACTOR	EMI	ELECTROMAGNETIC INTERFERENCE	FW	FIELD WELD	IR	INSIDE RADIUS
DC BACK OF CURB				EMT	ELECTRICAL METALLIC TUBING	FWD	FORWARD		
				ENCL	ENCLOSURE				
 			DESIGNED BY:				SCALE:		DRAWING No.:
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SUBMITTED BY:

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SoundTransit Contract No.: RTA/LR -REVIEWED BY:

GUI-AZN001

2/2024

GUIDANCE DRAWINGS ARCHITECTURAL

FACILITY ID:


ABBREVIATIONS

	uncontrolle
	ed
	document
	tfr
	rom
	soundtrans
	sit.org
ı	

				<i>F</i>	ABBREVIATIONS (CONTINUED)				
1		MP-#	METAL WALL PANEL - TYPE	РОН	POWER OVERHEAD	SDD	SUPPLY DUCT DAMPER	TPSS TRACTION POWER SUBS	TATION .
AN	JANITOR	MPA	MID-POINT ANCHOR	POS	POINT OF STATIONING	SDMH	STORM DRAIN MANHOLE	TRAC TRACTION	7,411014
	JUNCTION BOX	MR	MOISTURE RESISTANT	PP	POWER POLE	SDT	SMOKE DETECTOR	TRD TREAD	
	JOIST	MRT MS	MORTAR MOTOR STARTER	PREFAB	PREFABRICATED	SEC	SECOND	TRIP TRIP PLANNER TS STRUCTURAL TUBING	
	JOINT BACKER JOINT	MSL	MOTOR STARTER MEAN SEA LEVEL	PREFIN PRES	PREFINISHED	SEG SERV	SEGMENT SERVICE	TS STRUCTURAL TUBING TTC TELEPHONE TERMINAL C	ARINET
ı	JOINT	MSFS	METAL STRUT FRAMING SYSTEM	PRES PS-#	PRESSURIZATION PRECAST CONCRETE STAIR TREAD / LANDING,	SFD	SUPPLY FAN DAMPER	TVF TUNNEL VENTILATION FA	
		MSP	MOTOR STARTER PANEL	F 0-#	PRECAST CONCRETE STAIR TREAD / LANDING, PRECAST PLANKS - TYPE	SFRM	SPRAY-APPLIED FIRE RESISTIVE MATERIAL	TVM TICKET VENDING MACHIN	IE
		MTD	MOUNTED	PSF	POUNDS PER SQUARE FOOT	SHC	SHOTCRETE	TVOH TELEVISION OVERHEAD	ı
	KIP	MTG MTL	MOUNTING METAL	PSI	POUNDS PER SQUARE INCH	SHTHG SIG	SHEATHING SIGNAL	TVM TICKET VENDING MACHIN TVS TUNNEL VENTILATION SH	
	KING COUNTY METRO	MV	MILLIVOLT	PT-# PVC	PLATFORM FLOOR TILE POLYVINYL CHLORIDE	SIM	SIMILAR	TWA TIE WIRE ANCHOR	AFI
	KIP-FOOT KNOX BOX - TYPE	MVA	MEGAVOLT AMPERE	PWR	POWER	SJT	SCORE JOINT	TWC TRAIN TO WAYSIDE COM	MUNICATION
	KNOCK-OUT	MW	MEGAWATT			SL	SLOPE	TWM TACTILE WARNING MATE	RIAL
SF	KIPS PER SQUARE FOOT	MVSS	MEDIUM VOLTAGE SUB STATION			SL-# SLNT	FRAMED CANOPY - TYPE SEALANT		
	KIPS PER SQUARE INCH			Q	OLIA DDV TILE	SM	SHEET METAL	11	
	KILOWATT KILOWATT-HOUR	N		QT QTY	QUARRY TILE QUANTITY	SSMH	SANITARY SEWER MANHOLE	U/S UNDERSIDE	
VIIIX	RILOWATT-1100R	N/A	NOT APPLICABLE	l Qii	QUANTITI	SOG	SLAB ON GRADE	UD UNDERDRAIN	
		NEC	NATIONAL ELECTRICAL CODE			SOP	SET OUT POINT	UG UNDERGROUND	
		NEG NESC	NEGATIVE NATIONAL ELECTRICAL SAFETY CODE	R		SP SPA	STEEL PIPE SPACING	UH UNIT HEATER	TODIEO
_	LEFT	NESC NF	NEAR FACE	R	RISER	SPF	STAIRWELL PRESSURIZATION FAN	UL UNDERWRITERS LABORA UNEX UNEXCAVATED	TORIES
	LADDER LAMINATE	NIC	NOT IN CONTRACT	R/T RAD	RIGHT TRACK RADIUS	SPKR	SPEAKER	UNO UNLESS NOTED OTHERW	ISE
	PLASTIC LAMINATE - TYPE	NL	NIGHT LIGHT	RA	RETURN AIR	SPR	SPRINKLER	UV UTILITY VAULT	
	LAVATORY	NMC	NON-METALLIC CONDUIT	RA-#	ROOFING ASSEMBLY - TYPE	SQ SQ IN	SQUARE SQUARE INCH		
	POUND, POUNDS	NOM NPS	NOMINAL NOMINAL PIPE SIZE	RAF	RETURN AIR FAN	SQ IN SQ FT	SQUARE INCH SQUARE FEET		
	POUNDS PER FOOT	NP5 NPT	NATIONAL PIPE SIZE NATIONAL PIPE THREAD	RAL-#	ROOF ACCESS LADDER - TYPE	SQHD	SQUARE HEAD	V VAC VACANT	
	POUNDS FORCE LIGHT EMITTING DIODE	NR	NOT REGISTERED	RB RB-#	READER BOARD RESILIENT BASE - TYPE	SREG	SUPPLY REGISTER	VAC VACANT VAR VARIABLE	
	LIGHT EMITTING DIODE LEFT HAND	NRCP	NON-REINFORCED CONCRETE PIPE	RB-# RCP	RESILIENT BASE - TYPE REFLECTED CEILING PLAN	SS	SANITARY SEWER	VB-# VAPOR BARRIER - TYPE	
	LEFT HAND REVERSE	NS	NEAR SIDE	RCPT	RECEPTACLE	SST	STAINLESS STEEL	VCT VINYL COMPOSITION TILE	Ī
	LINEAR			RD	ROOF DRAIN	STD STL	STANDARD STEEL	VD VOLUME DAMPER VERT VERTICAL	
	LEADED JOINT	0		RD-#	ROLL UP DOOR - TYPE	STOR	STORAGE	VERTOUR VERTICAL VIF VERTFY IN FIELD	
	LONGITUDINAL JOINT LIVE LOAD	Ö	OPEN	RE	MANHOLE RIM ELEVATION	STN-#	STONE PANEL - TYPE	VMS VARIABLE MESSAGING S'	YSTEMS
	LIMIT OF CONSTRUCTION	O/L	OVERLAP	RECT REF	RECTANGULAR REFERENCE	STR	STAIR	VP VAPORPROOF	
	LONGITUDINAL	OA	OMNI-DIRECTIONAL ANTENNA	REG	REGISTER	STRUCT	STRUCTURAL	VR-# VAPOR RETARDER	
)P	LIMIT OF PAVEMENT	OC	ON CENTER	REINF	REINFORCEMENT	SU SUB	STUB-UP SUBSTATION		
	LIGHTING PANEL	OCS	OVERHEAD CATENARY SYSTEM	REQ'D	REQUIRED	SUB SURF	SUBSTATION SURFACE	\\\	
	LOW POINT	OD OF	OUTSIDE DIAMETER OUTSIDE FACE	REQ'S	REQUIREMENTS	SUSP	SUSPENDED	WAB-# WATER AND AIR BARRIEF	R - TYPE
	LIGHT RAIL TRANSIT LIGHT RAIL VEHICLE	OFCI	OWNER FURNISHED CONTRACTOR INSTALLED	RES RET	RESERVOIR RETAINING	SWA	SINGLE WIRE ANCHOR	WD WOOD	_
3	LUMP SUM	ОН	OVERHEAD	REX	RETAINING REQUEST TO EXIT	SWBD	SWITCHBOARD	WF-# WALL FINISH - TYPE	
	LEFT TRACK	OHB	OVERHEAD BRIDGE	RFG	ROOFING	SWCH SWGR	SWITCH SWITCHGEAR	WC WATER CLOSET	
	LIGHTING	OPNG OPR	OPENING OPPOSITE	RFLD	REFLECTED	SWGR	SWITCHGEAR SEWER	WCL WALL CONTROL LINE WCO WALL CLEANOUT	
	LOW VOLTAGE LEVEL	OPP OR	OPPOSITE OUTSIDE RADIUS	RGSC	RIGID GALVANIZED STEEL CONDUIT	SYM	SYMMETRICAL	WGR-# WATER AND GRAFFITI RE	PELLENT - TYPE
	LOUVER - TYPE	OTS	OPEN TO STRUCTURE	RH RH-#	RIGHT HAND ROOF ACCESS HATCH - TYPE			WH WATER HEATER	
	· -	1		RHR	RIGHT HAND REVERSE	_		WHDM WATT-HOUR DEMAND ME	TER
				RJ	RESTRAINED JOINT	l T	THEDMOSTAT TOTAD	WHM WATT-HOUR METER WI WROUGHT IRON	
		P B	POLE	RM	ROOM	¹ T/	THERMOSTAT, TREAD TOP	WID WROUGHT IRON WID WIDTH	
	METER	P/C	POLE PRECAST	RO POT	ROUGH OPENING	T/L	TAX LOT	WIN WINDOW	
	MAIN LINE MESSENGER WIRE	PA	PUBLIC ADDRESS	ROT RP	ROTATE(D) VIEW RADIUS POINT	T/R	TOP OF RAIL	WIP WROUGHT IRON PIPE	
	MAST ARM	PAN	PANTOGRAPH	RR	RAILROAD	TA-#	TOILET AND UTILITY ROOM ACCESSORIES - TYPE	WL WORK LINE	
ACH	MACHINE	PB-#	PAVER - WAYFINDING BRAID - TYPE	RRU	REMOTE RADIO UNIT	TBF	TUNNEL BOOSTER FAN	WM WATER METER WMP-# DECORATIVE METAL PAN	FI - TVDE
	MAINTENANCE	PC-# PC CONC	PRECAST CONCRETE PAVER - TYPE PRECAST CONCRETE	RREG	RETURN REGISTER	TBR	TO BE REMOVED	WOM WOMEN	<u> 111°</u>
	MASONRY	PCCONC	PRECAST CONCRETE PORTLAND CEMENT CONCRETE	RSC RT-1	RIGID STEEL CONDUIT ROOF SYSTEM - TYPE	TC TDD	TOP OF CURB TELECOMMUNICATION DISPLAY DEVICE	WP WORK POINT	
	MATERIAL MAKE UP AIR UNIT	PCF	POUNDS PER CUBIC FOOT	RT-1 RTU	ROOF SYSTEM - TYPE REMOTE TERMINAL UNIT	TEL	TELEPHONE	WP-# WATERPROOFING SYSTE	M - TYPE
	MAXIMUM	PE	PRELIMINARY ENGINEERING	RVS	REVERSE	TF	TEMPERATURE	WR WATER RESISTANT	TINO TYPE
3R	MEMBER	PED	PEDESTRIAN PLATFORM FYLIALIST FAN	RW	RETAINING WALL	TERM	TERMINAL	WRC-# WATER REPELLANT COATURE WS WATER STOP	IING - IYPE
	METAL CEILING - TYPE	PEF PERF	PLATFORM EXHAUST FAN PERFORATED			TF TFD	TRACKFEET TUNNEL FAN DAMPER	WSH WASH	
	MOTOR CONTROL CENTER MOTORIZED DAMPER	PERP	PERPENDICULAR	Q		TG	TOP OF GRATE	WSP WELDED STEEL PIPE	
	MEDIUM DENSITY FIBERBOARD	PET	PASSENGER EMERGENCY TELEPHONE	S-T	SELF-TAPPING	TH	THRESHOLD	WT WIDE TEE STRUCTURAL I	MEMBER
	MOLDING	PGL	PROFILE GRADE LINE	S/C	SIGNAL/COMMUNICATION	THRD	THREADED	WT-# WALL TILE - TYPE WWF WELDED WIRE FABRIC	
ECH	MECHANICAL	PH	PHASE PROPERTY LINE	S/S	SERVICE SINK	TL TMH	TENSION LENGTH TELEPHONE MANHOLE	W/ WITH	
	MEDIUM	PL PLT	PROPERTY LINE PLATE	S/W	SIDEWALK	TNCH	TRENCH DRAIN		
	MEMBRANE MECHANICAL ELECTRICAL BLUMBING	PLI	PLASTER	SA SAF	SUPPLY AIR SUPPLY AIR FAN	TO	TOP OF		
	MECHANICAL ELECTRICAL PLUMBING MEZZANINE	PLAT	PLATFORM	SAFTP	STAND ALONE FARE TRANSACTION PROCESSOR	ТОВ	TOP OF BEAM	X	
	MANUFACTURER	PLF	POUNDS PER LINEAR FOOT	SAN	SANITARY SEWER	TOC	TOP OF CONCRETE	X-SPAN CROSS SPAN	
L	US THOUSANDTH OF AN INCH	PLP PLUMB	PLASTIC PIPE PLUMBING	SAP	SUBSTATION ALARM PANEL	TOD TOF	TRANSIT ORIENTED DEVELOPMENT TOP OF FOOTING		
	MINIMUM	PLYWD	PLUMBING PLYWOOD	SAT SBR	SPRAY-APPLIED ACOUSTIC TREATMENT SEALANT AND BACKER ROD	TOG	TOP OF FOOTING TOP OF GRADE	Υ	
	MECHANICAL JOINT MASONRY OPENING	PMJF	PREMOLDED JOINT FILLER	SCR	SCREW	TOR	TOP OF RAIL	YD YARD	
	MASONRY OPENING MODULAR	PNL	PANEL	SCRN	SCREEN	TORW	TOP OF RETAINING WALL		
	MOTOR OPERATED	PNT-#	PAINT COLOR	SD	STORM DRAIN	TOS	TOP OF STRUCTURE/ TOP OF STEEL		
OV	MOVABLE	PO POC	POWER OPERATED POINT ON CURVE	SD-#	METAL DECK STATION	TOW TP	TOP OF WALL TOTAL PRESSURE	# NUMBER	
		<u> </u>	DESIGNED BY:				SCALE:	SOUND TRANSIT	DRAWING No.
			DRAWN BY:			1" A A A	FILENAME:	GUIDANCE DRAWINGS	GUI-A
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2/2024		WINGS				-1 50	UNDTRANSIT CONTRACT No.: RTA/LR -	ABBREVIATIONS	SHEET No.:
8/2019	NEW - ARCH DIRECTIVE AND S		APPROVED BY: SUBMIT	ITED BY:	DATE: REVIEWED BY:	DATE:	DATE:		
18/7HTU			_,	, .		=	# L// \		-

	GENERAL NOTES		SYMBOLS						
	GUIDANCE AND STANDARD DRAWINGS SHALL BE USED IN CONJUNCTION WITH THE DESIGN CRITERIA MANUAL.		SECTION / DI	ETAIL		PLAN		LIMITS OF WORK LINE	
	 DO NOT SCALE THE DRAWINGS. REPETITIVE FEATURES ARE OFTEN DRAWN OR REFERENCED ONLY ONCE AND SHALL BE COMPLETELY PROVIDED AS IF DRAWN IN FULL. 		GRAVEL EARTH			IN-BETWEEN CAR BARRIEF	_	ROOM NAME ROOM NUMBER	ROOM NAME XXXX###
	4. REFER TO ST SYSTEMS GUIDANCE DRAWINGS AND ST CUSTOMER SIGNAGE DESIGN MANUAL FOR ADDITIONAL SIGNAGE REQUIREMENTS.		CONCRETE			BENCH		FLOOR DRAIN	⊕ FD
			CONCRETE MASO	NRY UNITS		SAFTP		ROOF DRAIN	RD
			TILE			TICKET VENDING MACHINE		CHANGE IN PLANE	
			STEEL					CHANGE IN PLANE	
			GROUT			ELEVATION GLAZING		SLOPE	2.0%
.DWG			CELLULAR CONCE	RETE FILL	+ + + + + + + + + + + + + + + + + + + +	PERFORATED METAL		LOCATION OF REMOTE POINT O	OR WORK POINT
UI-AZN003			CEMENTITIOUS FI	IREPROOFING	× × × × × × × × × × × × × × × × × × ×	GRATING		DIMENSION POINT	→ DIM POINT
\ARCH\G			PLYWOOD					LEVEL HEAD	EL 👉
AWINGS			GYPSUM BOARD					SPRINKLER HEAD	•
ANCE DR			ACOUSTICAL PLA	STER					
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20/24 JSERS		APPROVED BY:	SUBMITTED BY:	DATE:	REVIEWED BY:	DATE:	RTA/LR - DATE:	GENERAL NOTES & SYMBOLS	SHEET No.: REV:
03/2 C:\U	No. DATE DSN CHK APP REVISION		-	-	-	-	2/2024		1

1. THIS PLAN INDICATES A PROTOTYPICAL CONFIGURATION LAYOUT ONLY. SPECIFIC STATION REQUIREMENTS AND LAYOUTS WILL VARY. ACTUAL LAYOUT WILL BE SUBJECT TO FINDINGS OF EXIT CALCULATIONS PERFORMED IN ACCORDANCE WITH GOVERNING CODES AND THE DCM.

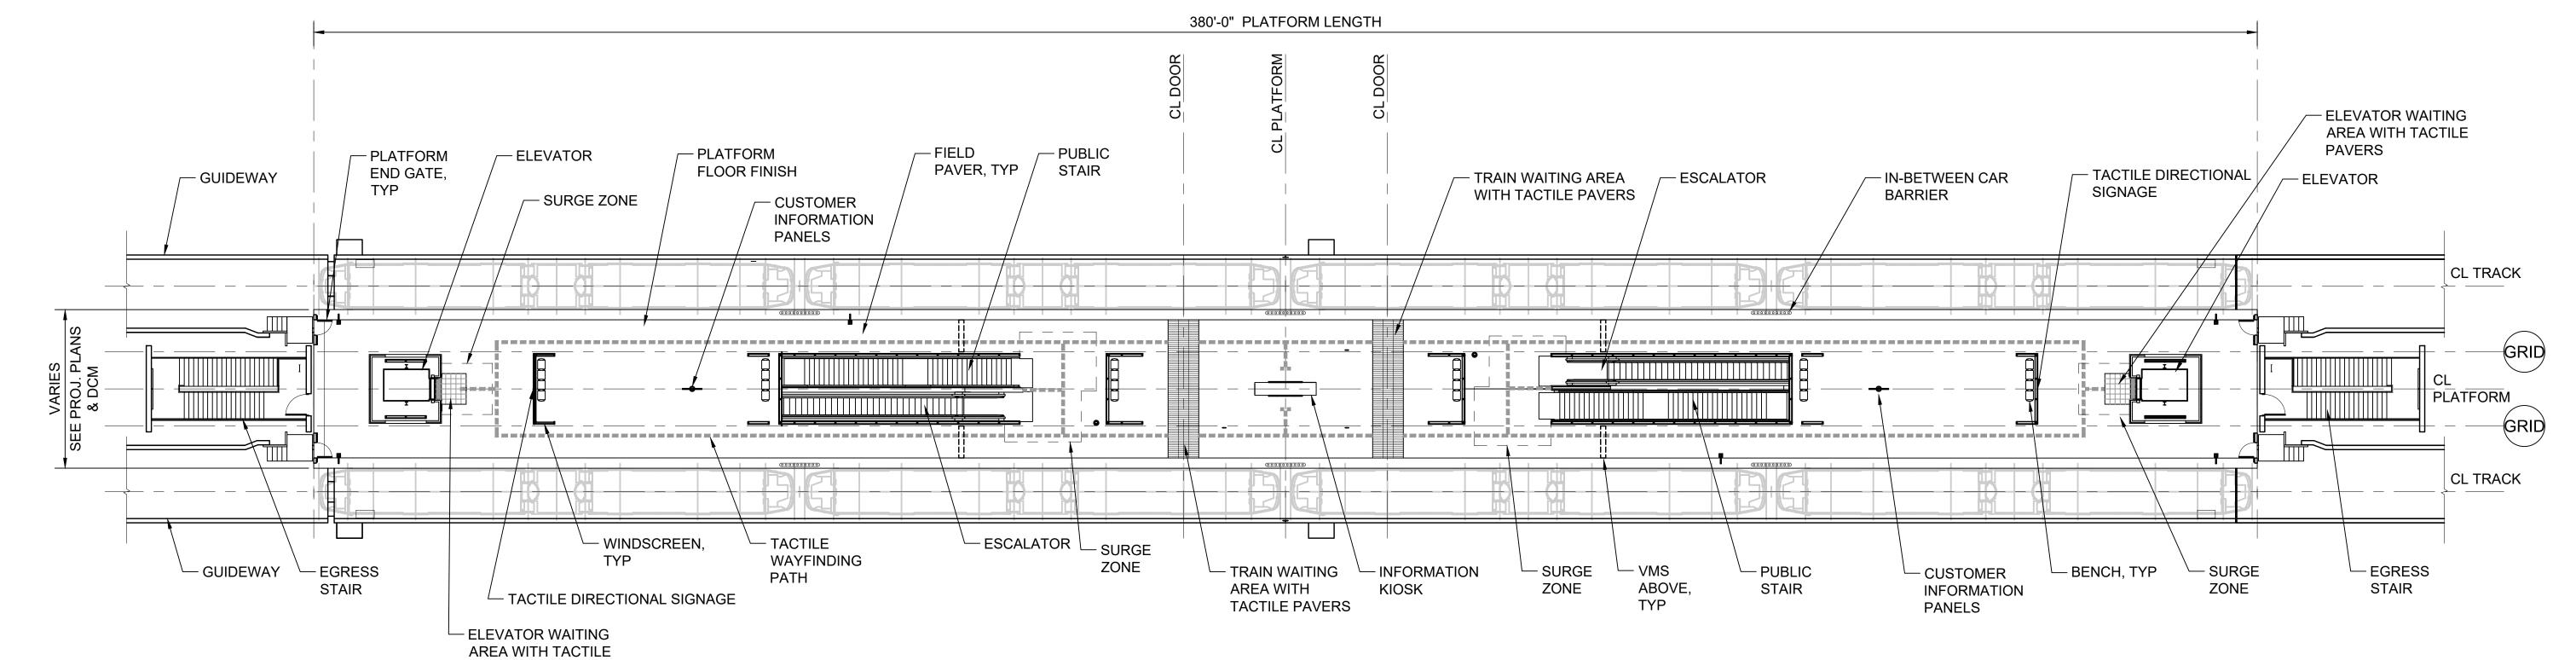

PLAN SCALE: 1/16" = 1'-0"

DESIGNED BY: DRAWN BY: 2024 REVISED GUIDANCE DRAWINGS CHECKED BY: REVISED - ARCH DIRECTIVE AND STANDARD DWGS APPROVED BY: NEW - CIVIL, ARCH, SYSTEMS GUIDANCE DWGS 6/2013 DSN CHK APP REVISION

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SUBMITTED BY: REVIEWED BY:

1/16"=1'-0" ILENAME: SoundTransit CONTRACT No.: RTA/LR -

2/2024


SOUND TRANSIT GUIDANCE DRAWINGS ARCHITECTURAL GUI-APP101

RAWING No.: **GUI-APP101** FACILITY ID:

ELEVATED CENTER PLATFORM PLAN

SHEET No.:

1. THIS PLAN INDICATES A PROTOTYPICAL CONFIGURATION LAYOUT ONLY. SPECIFIC STATION REQUIREMENTS AND LAYOUTS WILL VARY. ACTUAL LAYOUT WILL BE SUBJECT TO FINDINGS OF EXIT CALCULATIONS PERFORMED IN ACCORDANCE WITH GOVERNING CODES AND THE DCM.

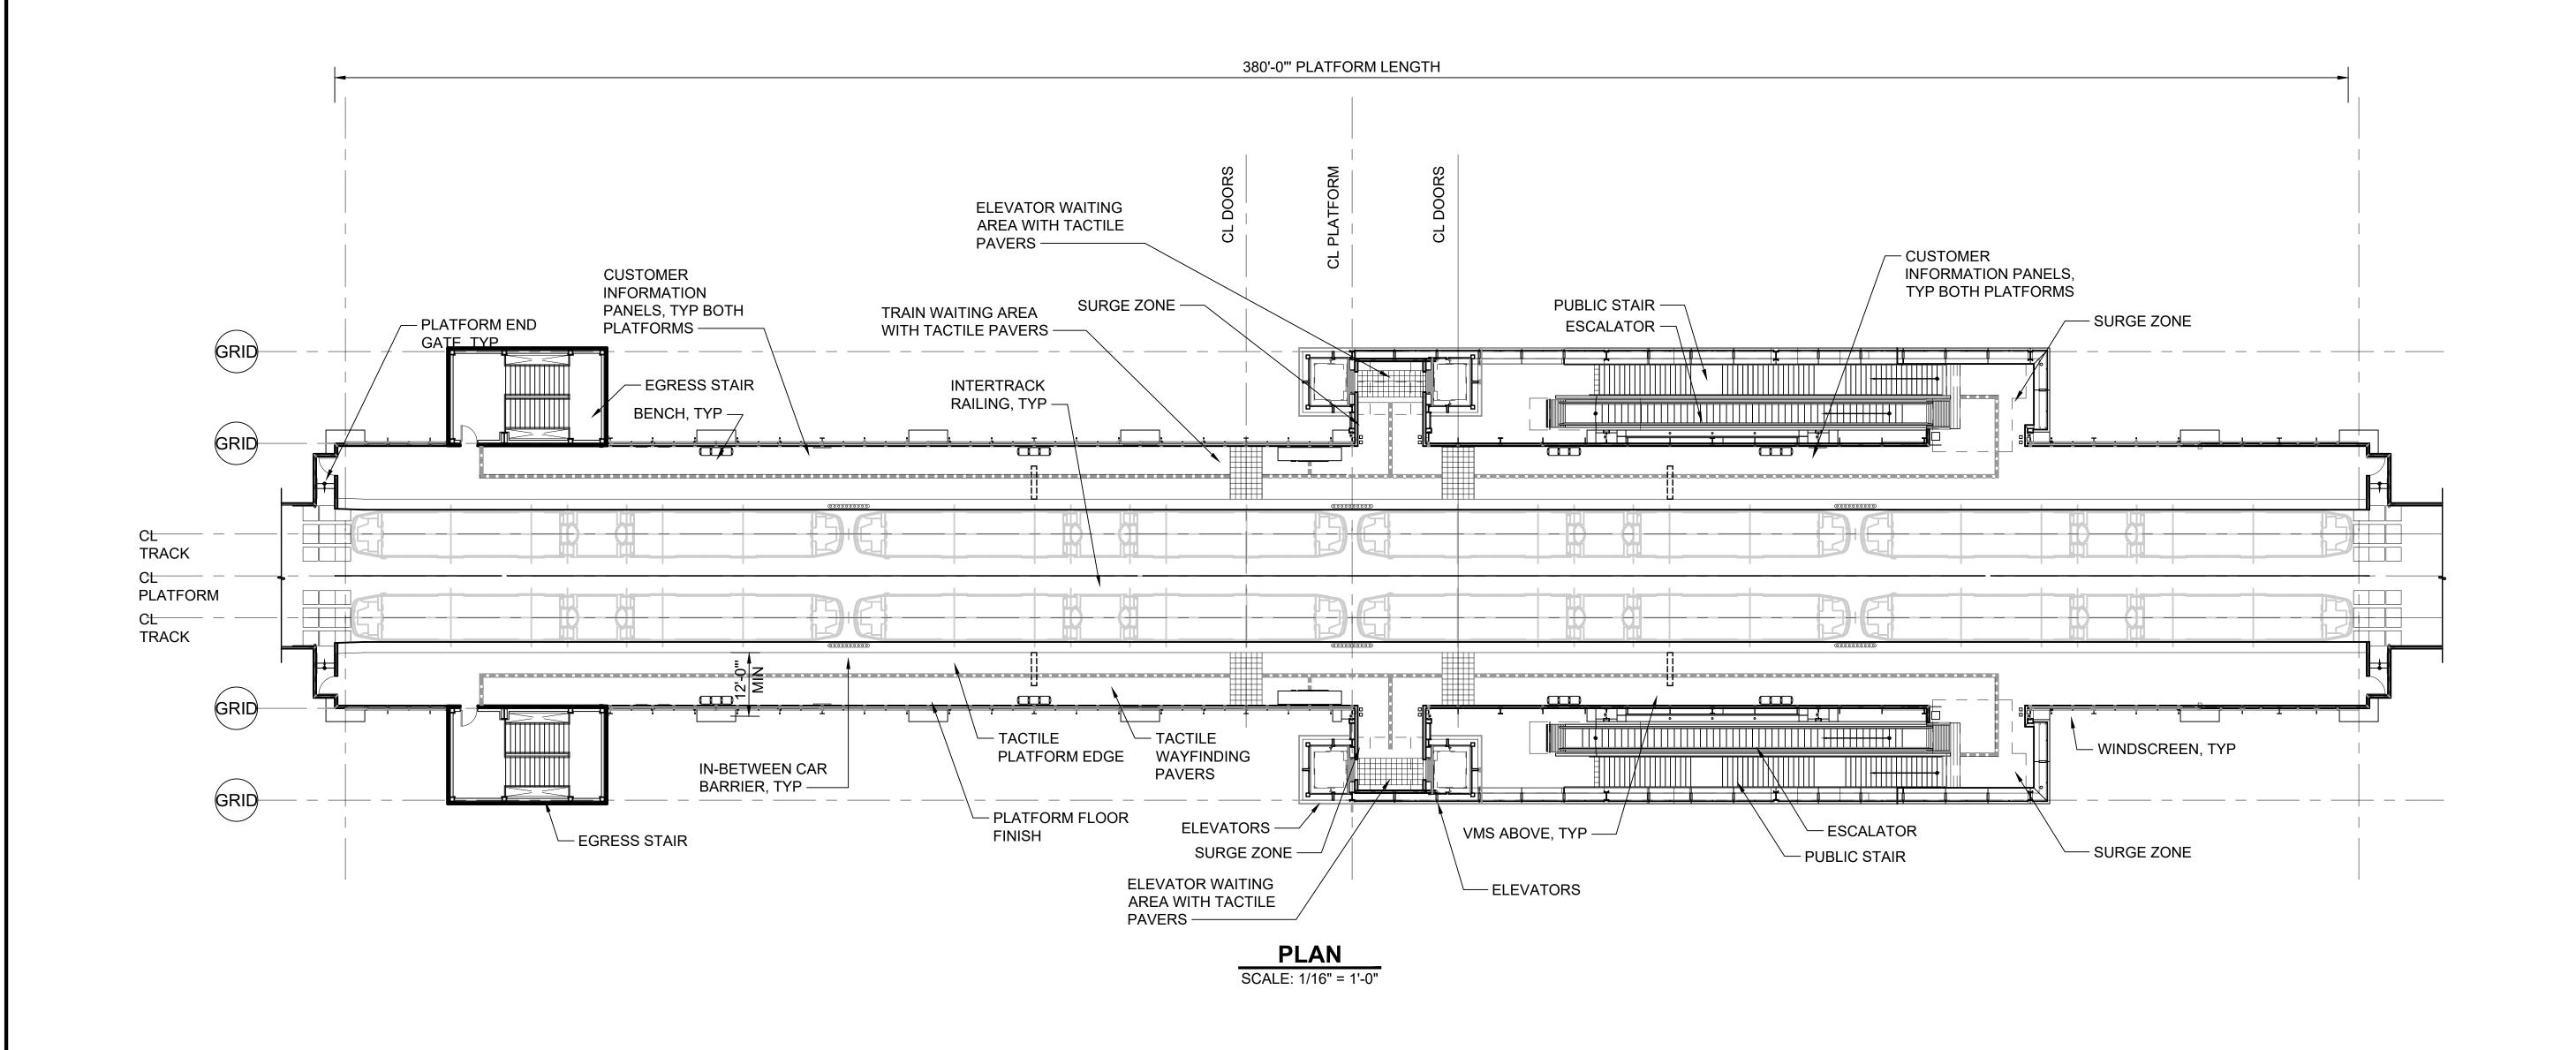

DESIGNED BY: 1/16"=1'-0" ILENAME: DRAWN BY: GUI-APP105 CHECKED BY: CONTRACT No.: SoundTransit RTA/LR -2024 REVISED GUIDANCE DRAWINGS 2/2024 NEW - ARCH DIRECTIVE AND STANDARD DWGS APPROVED BY: SUBMITTED BY: 8/2019 REVIEWED BY: 2/2024 DSN CHK APP REVISION

SOUND TRANSIT GUIDANCE DRAWINGS ARCHITECTURAL


GUI-APP105 FACILITY ID:

RAWING No.:


SHEET No.:

ELEVATED SIDE PLATFORM PLAN

GENERAL NOTE: 1. THIS PLAN INDICATES A PROTOTYPICAL CONFIGURATION LAYOUT ONLY. SPECIFIC STATION REQUIREMENTS AND LAYOUTS WILL VARY. ACTUAL LAYOUT WILL BE SUBJECT TO FINDINGS OF EXIT CALCULATIONS PERFORMED IN ACCORDANCE WITH GOVERNING CODES AND THE DCM. - ELEVATOR WAITING AREA WITH TACTILE **PAVERS** ─ ELEVATOR - INSIDE FACE OF — EGRESS STATION BOX STAIR **EGRESS** MECH **EMER ELEC** STAIR —— CHASE — RESPONDER CLOSET — EQUIP RM — RAWING No.: **SOUND TRANSIT GUI-APP121 GUIDANCE DRAWINGS** ARCHITECTURAL FACILITY ID:

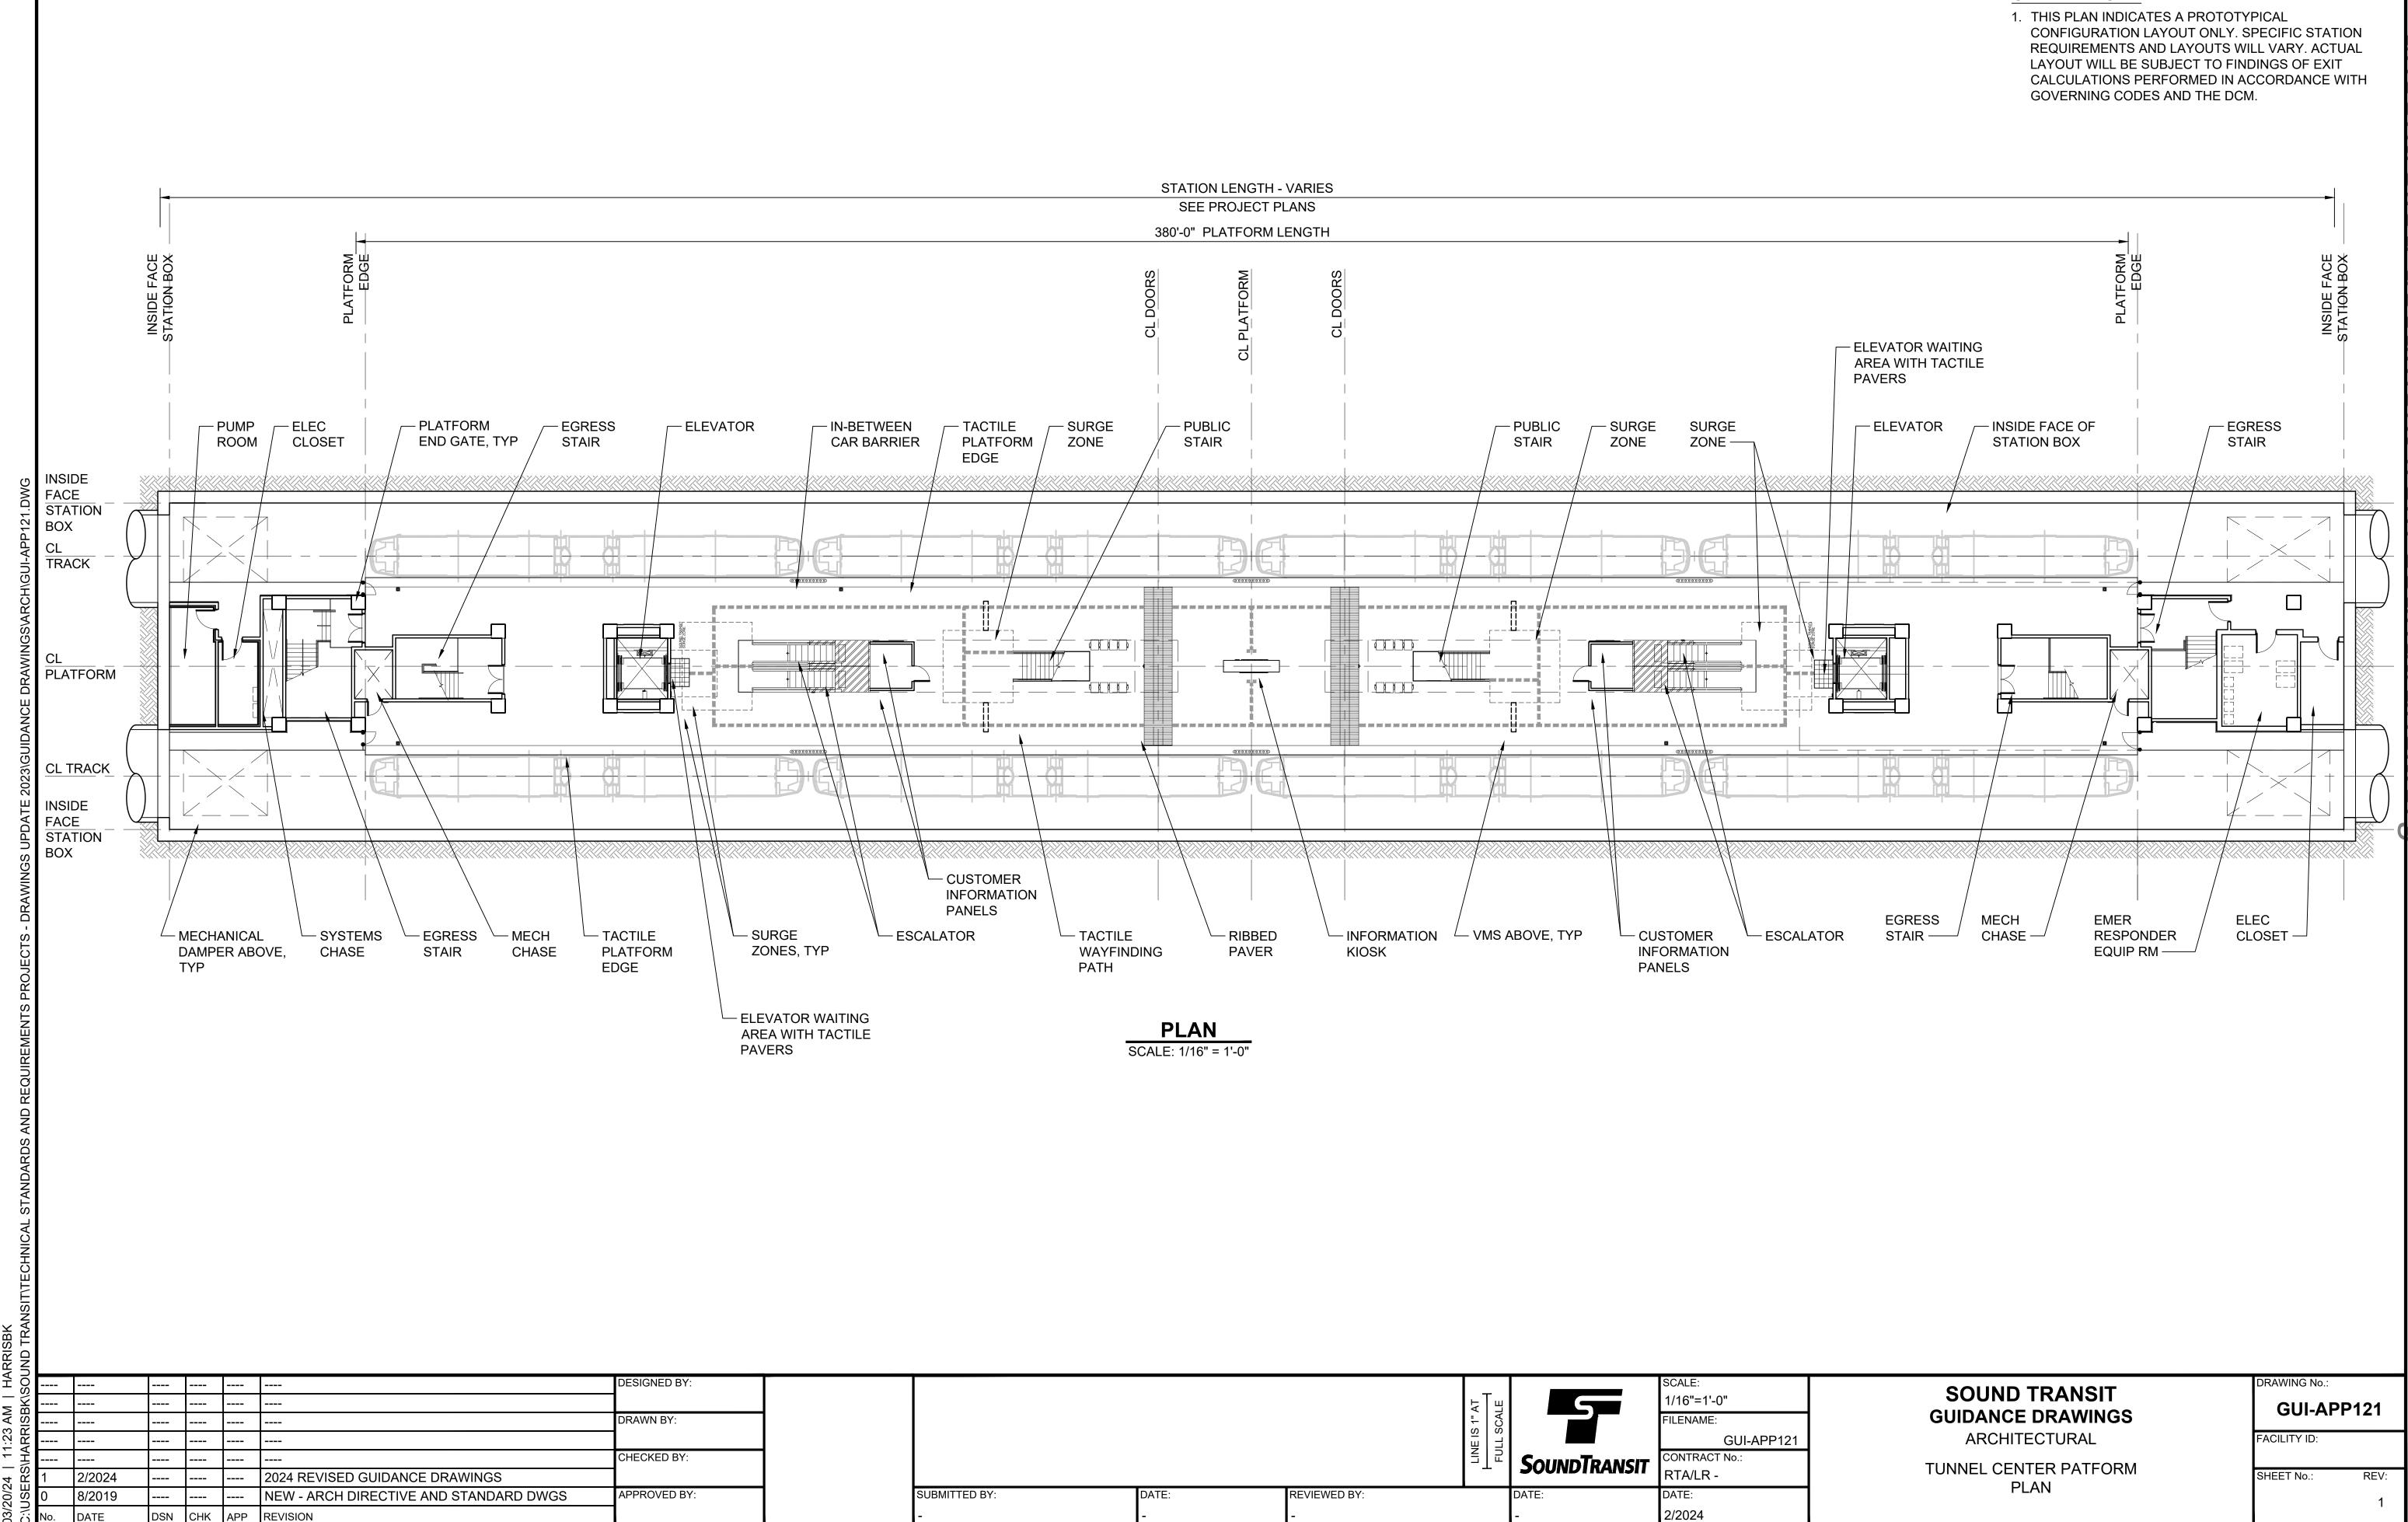

1. THIS PLAN INDICATES A PROTOTYPICAL CONFIGURATION LAYOUT ONLY. SPECIFIC STATION REQUIREMENTS AND LAYOUTS WILL VARY. ACTUAL LAYOUT WILL BE SUBJECT TO FINDINGS OF EXIT CALCULATIONS PERFORMED IN ACCORDANCE WITH GOVERNING CODES AND THE DCM.

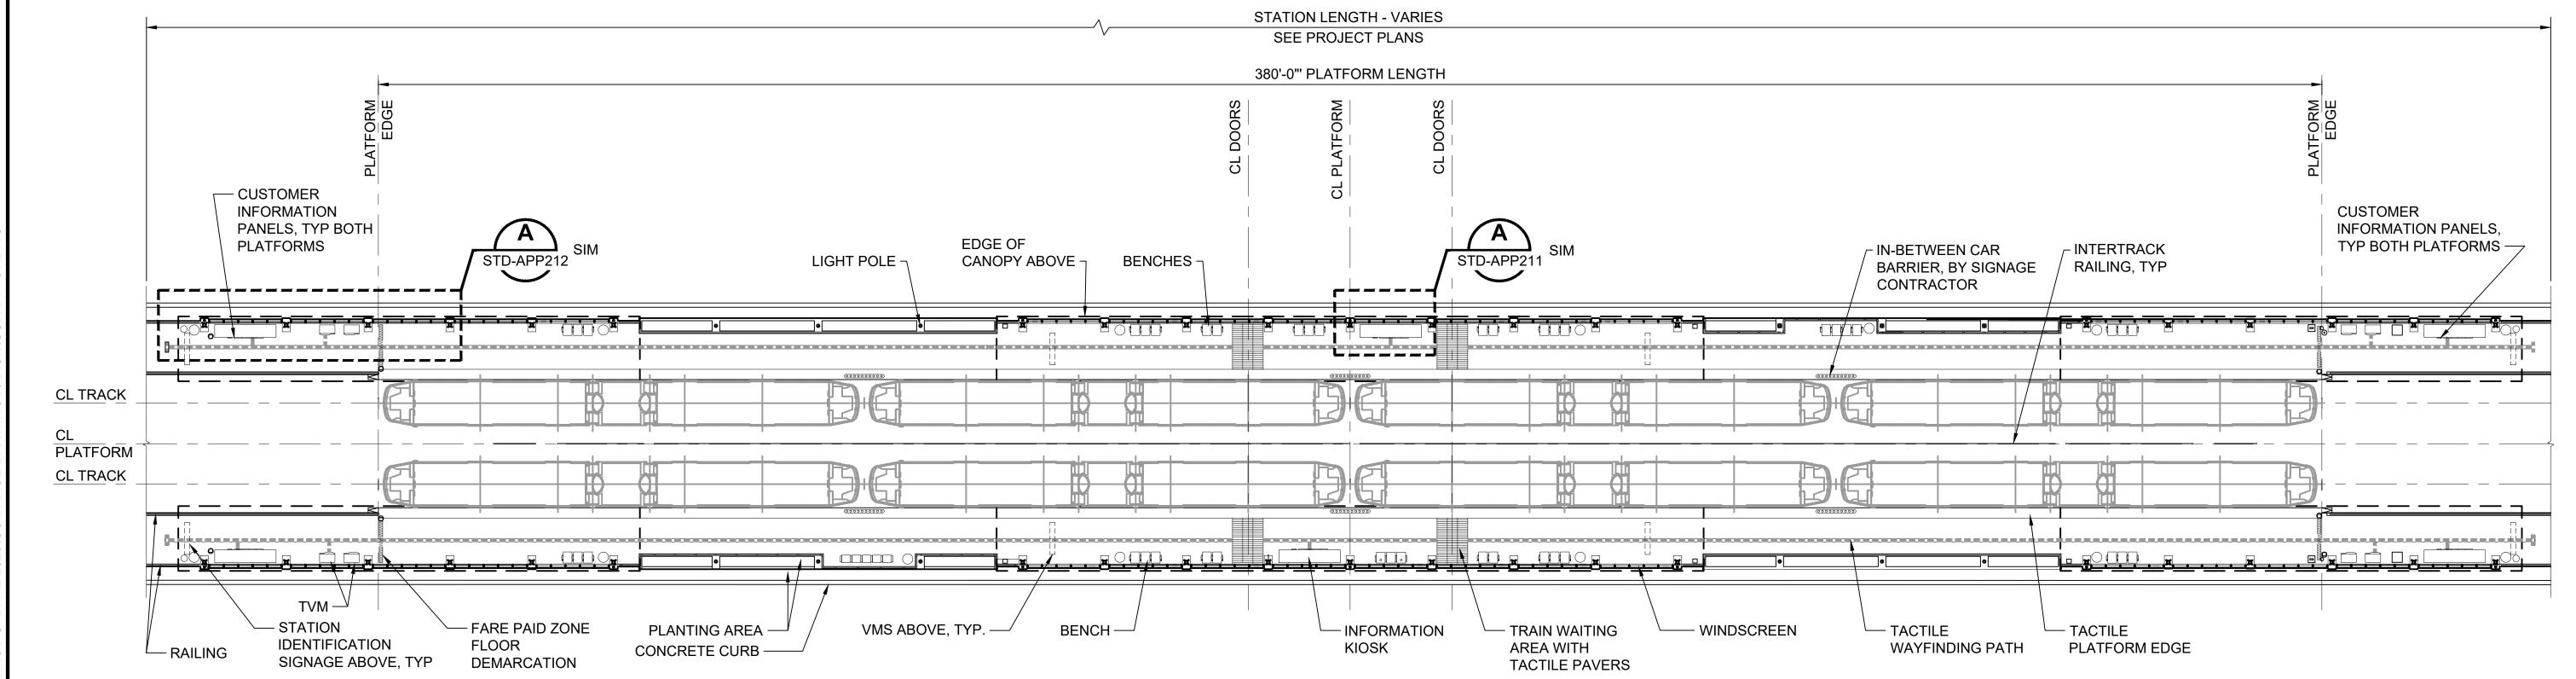

PLAN
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TE:	RTA/LR - DATE:

2/2024

SOUND TRANSIT GUIDANCE DRAWINGS ARCHITECTURAL


PLAN

GUI-APP131 FACILITY ID: AT-GRADE SIDE PLATFORM

SHEET No.:	REV:
	1

RAWING No.:

1. THIS PLAN INDICATES A PROTOTYPICAL CONFIGURATION LAYOUT ONLY. SPECIFIC STATION REQUIREMENTS AND LAYOUTS WILL VARY. ACTUAL LAYOUT WILL BE SUBJECT TO FINDINGS OF EXIT CALCULATIONS PERFORMED IN ACCORDANCE WITH GOVERNING CODES AND THE DCM.

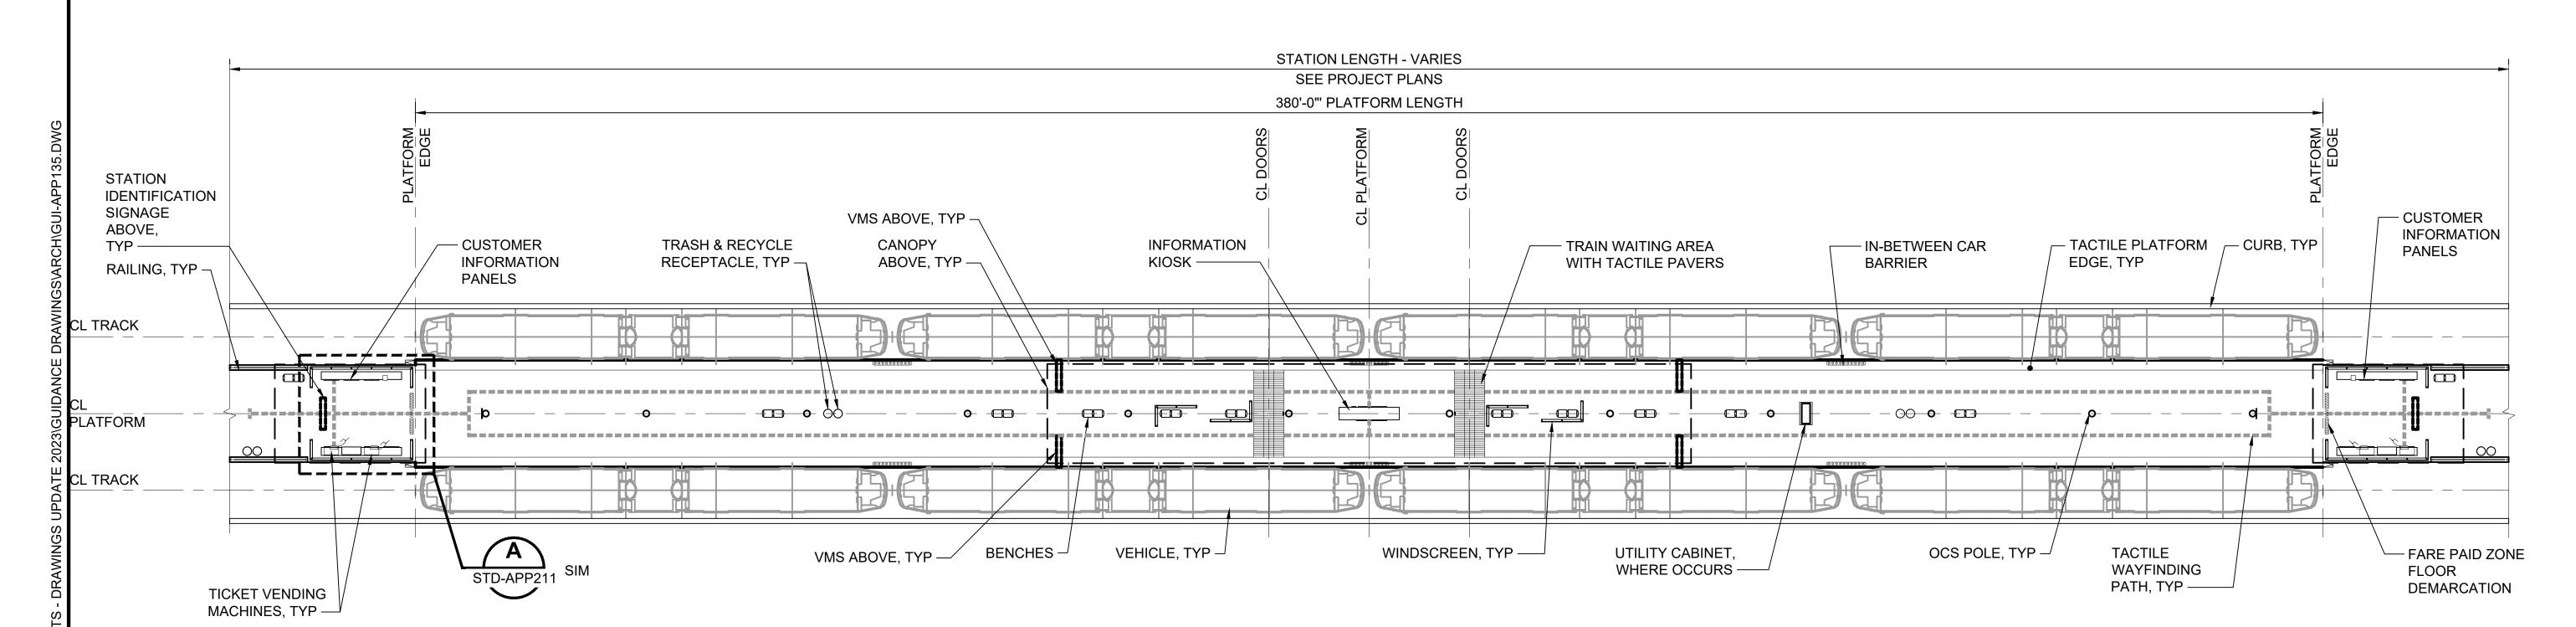

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DSN CHK APP REVISION

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	DATE:
	2/2024

SOUND TRANSIT GUIDANCE DRAWINGS ARCHITECTURAL

AT-GRADE PLATFORM


PLAN

GUI-APP135

FACILITY ID:

SHEET No.:

- 1. THIS PLAN INDICATES A PROTOTYPICAL CONFIGURATION LAYOUT ONLY. SPECIFIC STATION REQUIREMENTS AND LAYOUTS WILL VARY. NOT ALL REQUIRED ANCILLARY SPACES ARE SHOWN. ACTUAL LAYOUT WILL BE SUBJECT TO FINDINGS OF EXIT CALCULATIONS PERFORMED IN ACCORDANCE WITH GOVERNING CODES AND THE SOUND TRANSIT REQUIREMENTS MANUAL / DESIGN CRITERIA MANUAL.
- 2. DASHED LINES AT TVM EQUIPMENT PLAN INDICATE ADA APPROACH SPACE. PARALLEL ADA APPROACH IS ASSUMED.
- 3. REFER TO SOUND TRANSIT CUSTOMER SIGNAGE MANUAL TO DETERMINE MOUNTING HEIGHTS FOR CUSTOMER INFORMATION PANELS AND TRIP

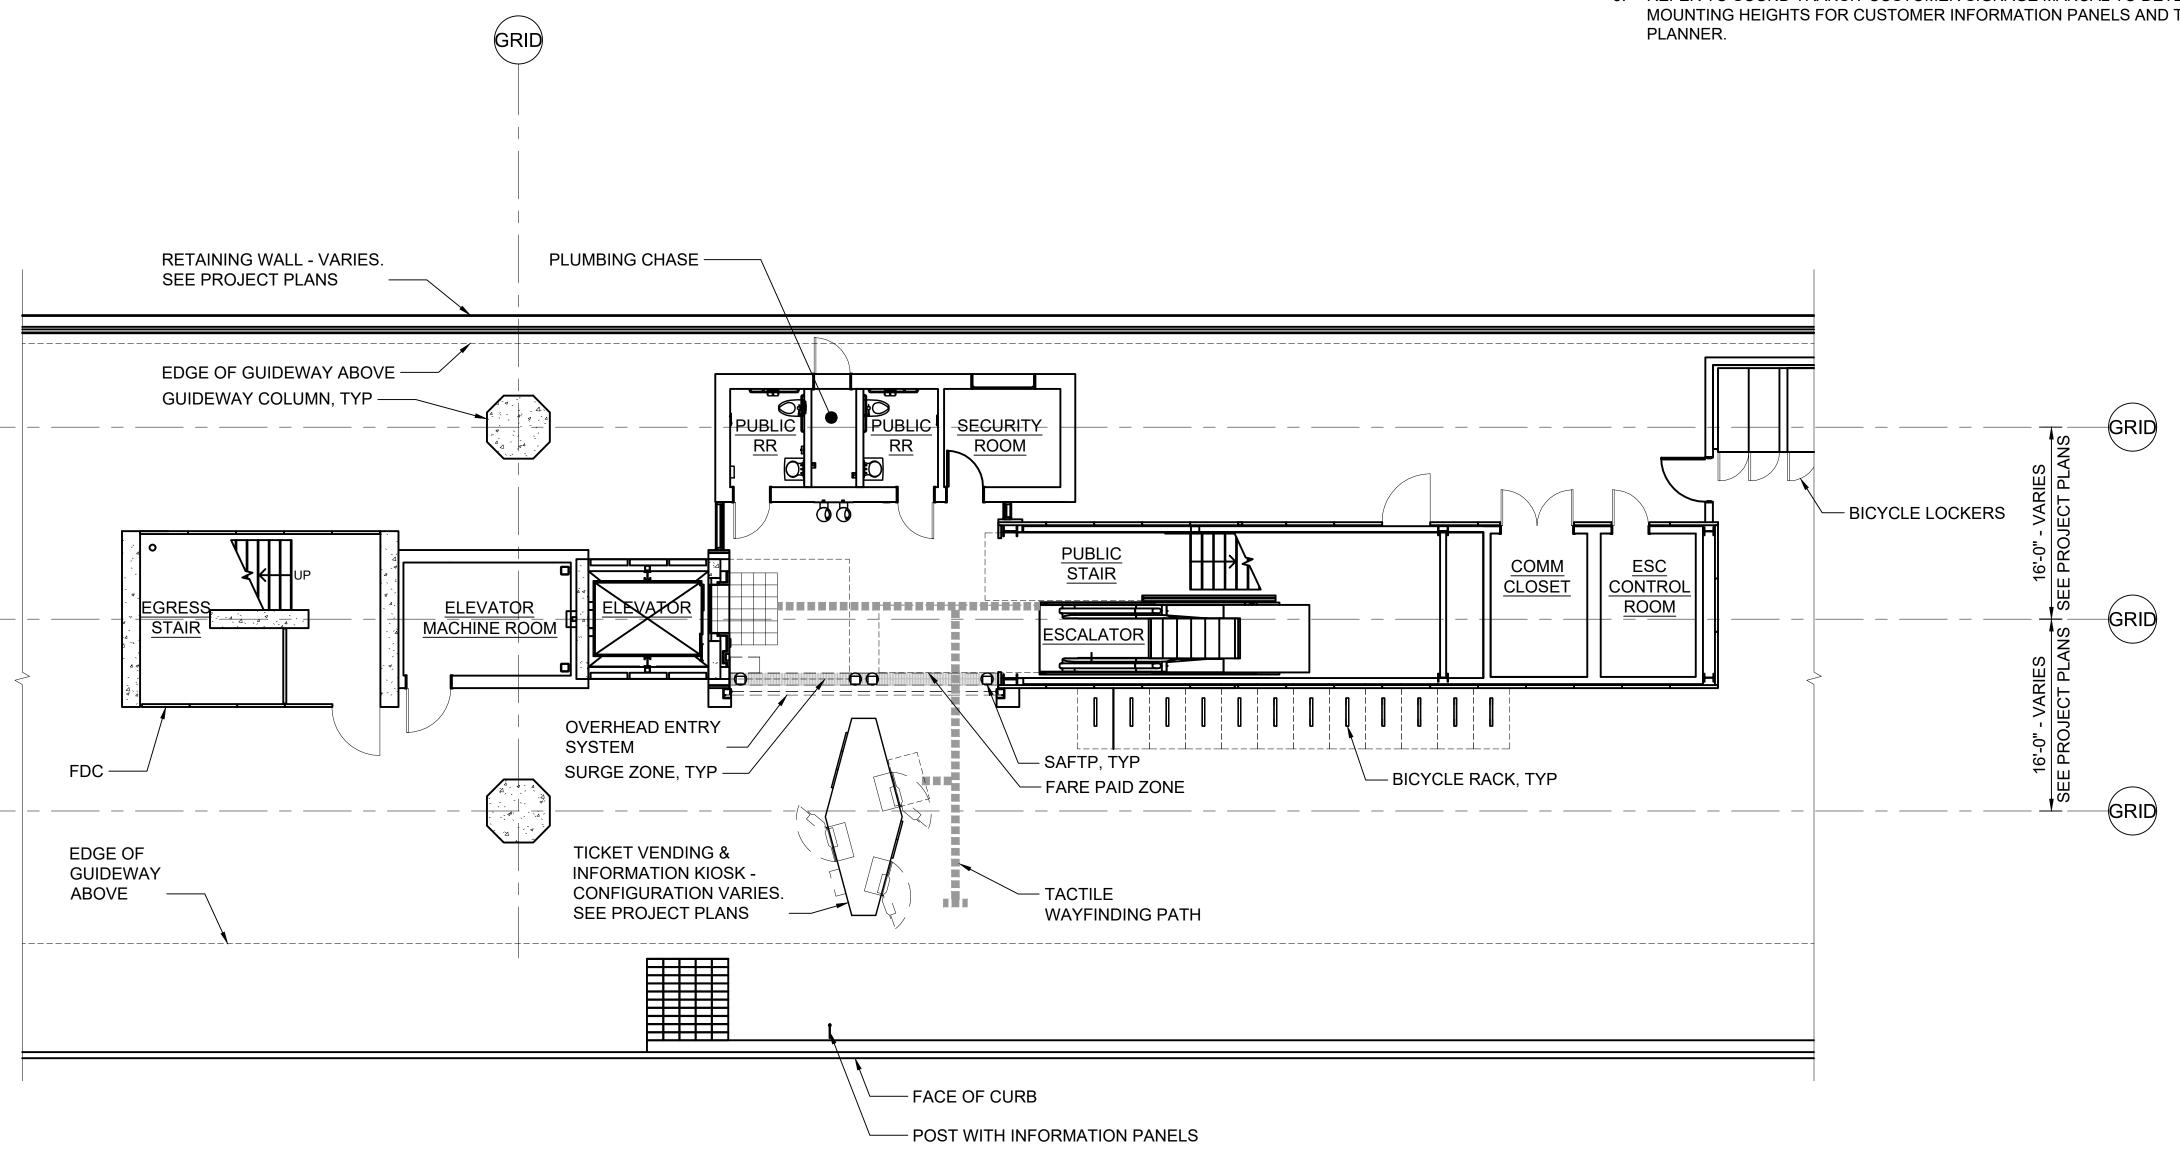

PLAN

SCALE: 1/8" = 1'-0"

DESIGNED BY: RAWING No.: **SOUND TRANSIT GUI-APP201 GUIDANCE DRAWINGS** DRAWN BY: ARCHITECTURAL GUI-APP201 FACILITY ID: 2024 REVISED GUIDANCE DRAWINGS SoundTransit CHECKED BY: ELEVATED CENTER PLATFORM REVISED - ARCH DIRECTIVE AND STANDARD DWGS SHEET No.: **ENTRY LAYOUT** NEW - CIVIL, ARCH, SYSTEMS GUIDANCE DWGS APPROVED BY: 6/2013 SUBMITTED BY: REVIEWED BY:

GUI-APP205

FACILITY ID:

SHEET No.:

GUIDANCE DRAWINGS

ARCHITECTURAL

TUNNEL CENTER PLATFORM

SURFACE & MEZZANINE PLANS

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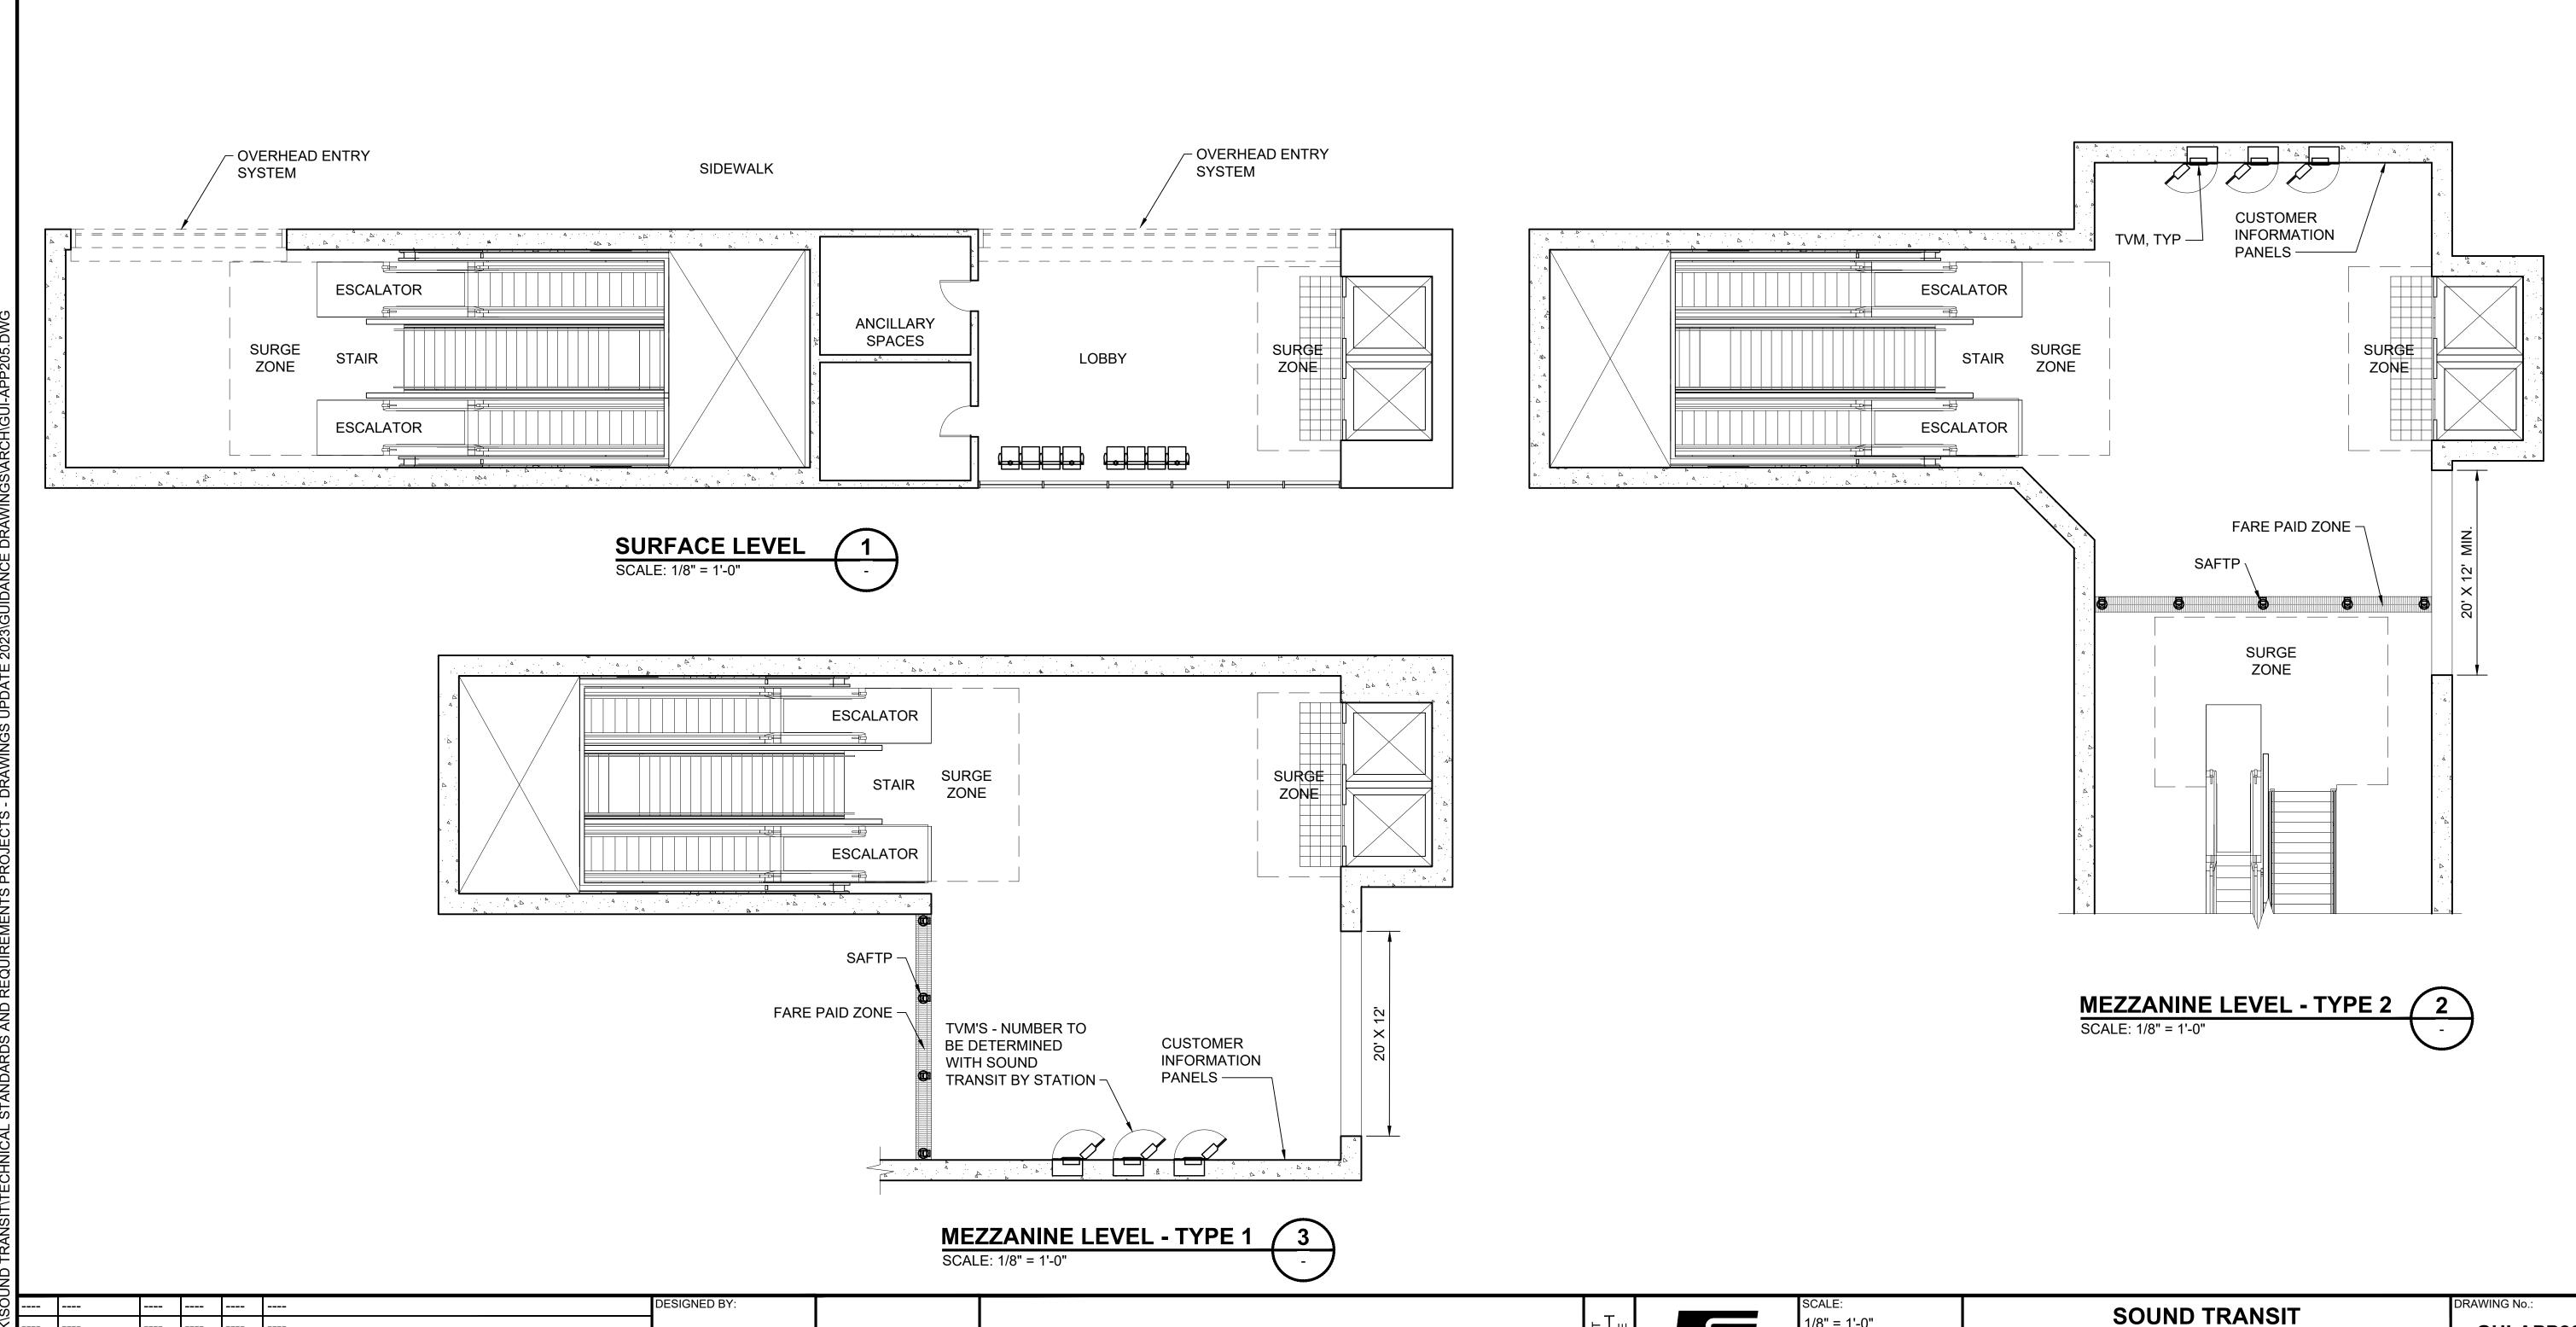
REVIEWED BY:

CONTRACT No.:

GUI-APP205

GENERAL NOTE:

1. THIS PLAN INDICATES A PROTOTYPICAL CONFIGURATION LAYOUT ONLY. SPECIFIC STATION REQUIREMENTS AND LAYOUTS WILL VARY. ACTUAL LAYOUT WILL BE SUBJECT TO FINDINGS OF EXIT CALCULATIONS PERFORMED IN ACCORDANCE WITH GOVERNING CODES AND THE DCM.



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CHECKED BY:

APPROVED BY:

SUBMITTED BY:

2024 REVISED GUIDANCE DRAWINGS

REVISED - ARCH DIRECTIVE AND STANDARD DWGS


NEW - CIVIL, ARCH, SYSTEMS GUIDANCE DWGS


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1. THIS PLAN INDICATES A PROTOTYPICAL CONFIGURATION LAYOUT ONLY. SPECIFIC STATION REQUIREMENTS AND LAYOUTS WILL VARY. ACTUAL LAYOUT WILL BE SUBJECT TO FINDINGS OF EXIT CALCULATIONS PERFORMED IN ACCORDANCE WITH GOVERNING CODES AND THE DCM.





DESIGNED BY: DRAWN BY: 2024 REVISED GUIDANCE DRAWINGS CHECKED BY: 2/2024 REVISED - ARCH DIRECTIVE AND STANDARD DWGS 8/2019 NEW - CIVIL, ARCH, SYSTEMS GUIDANCE DWGS APPROVED BY: 6/2013

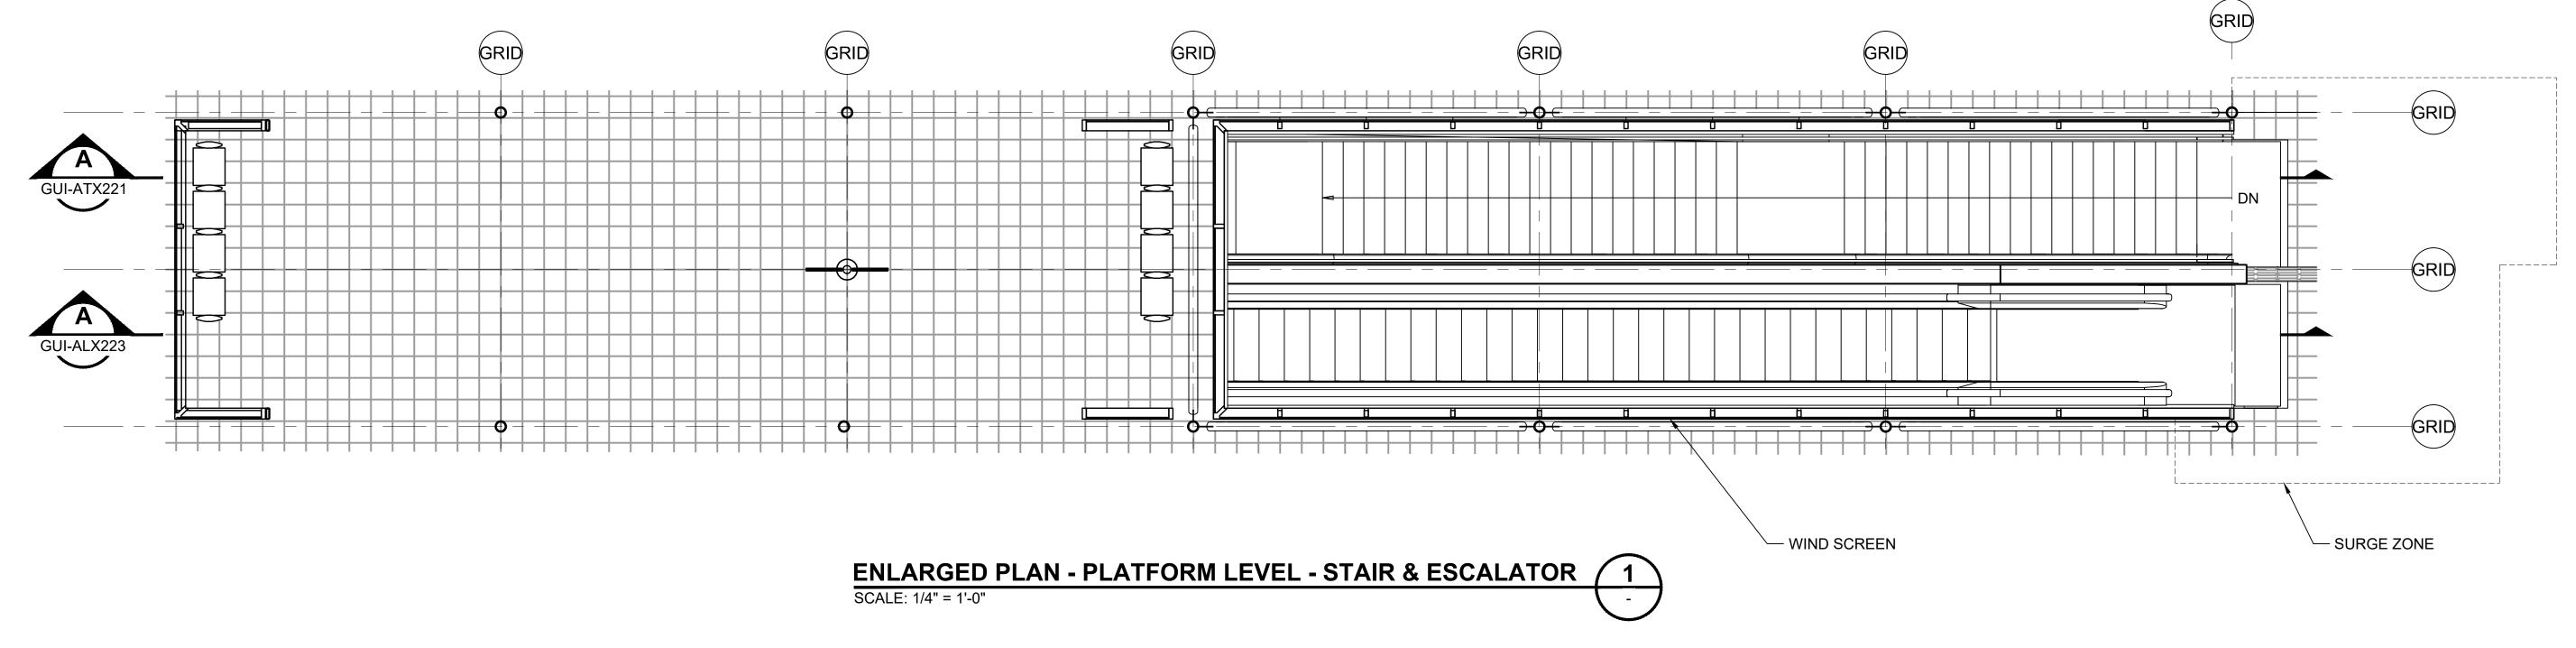
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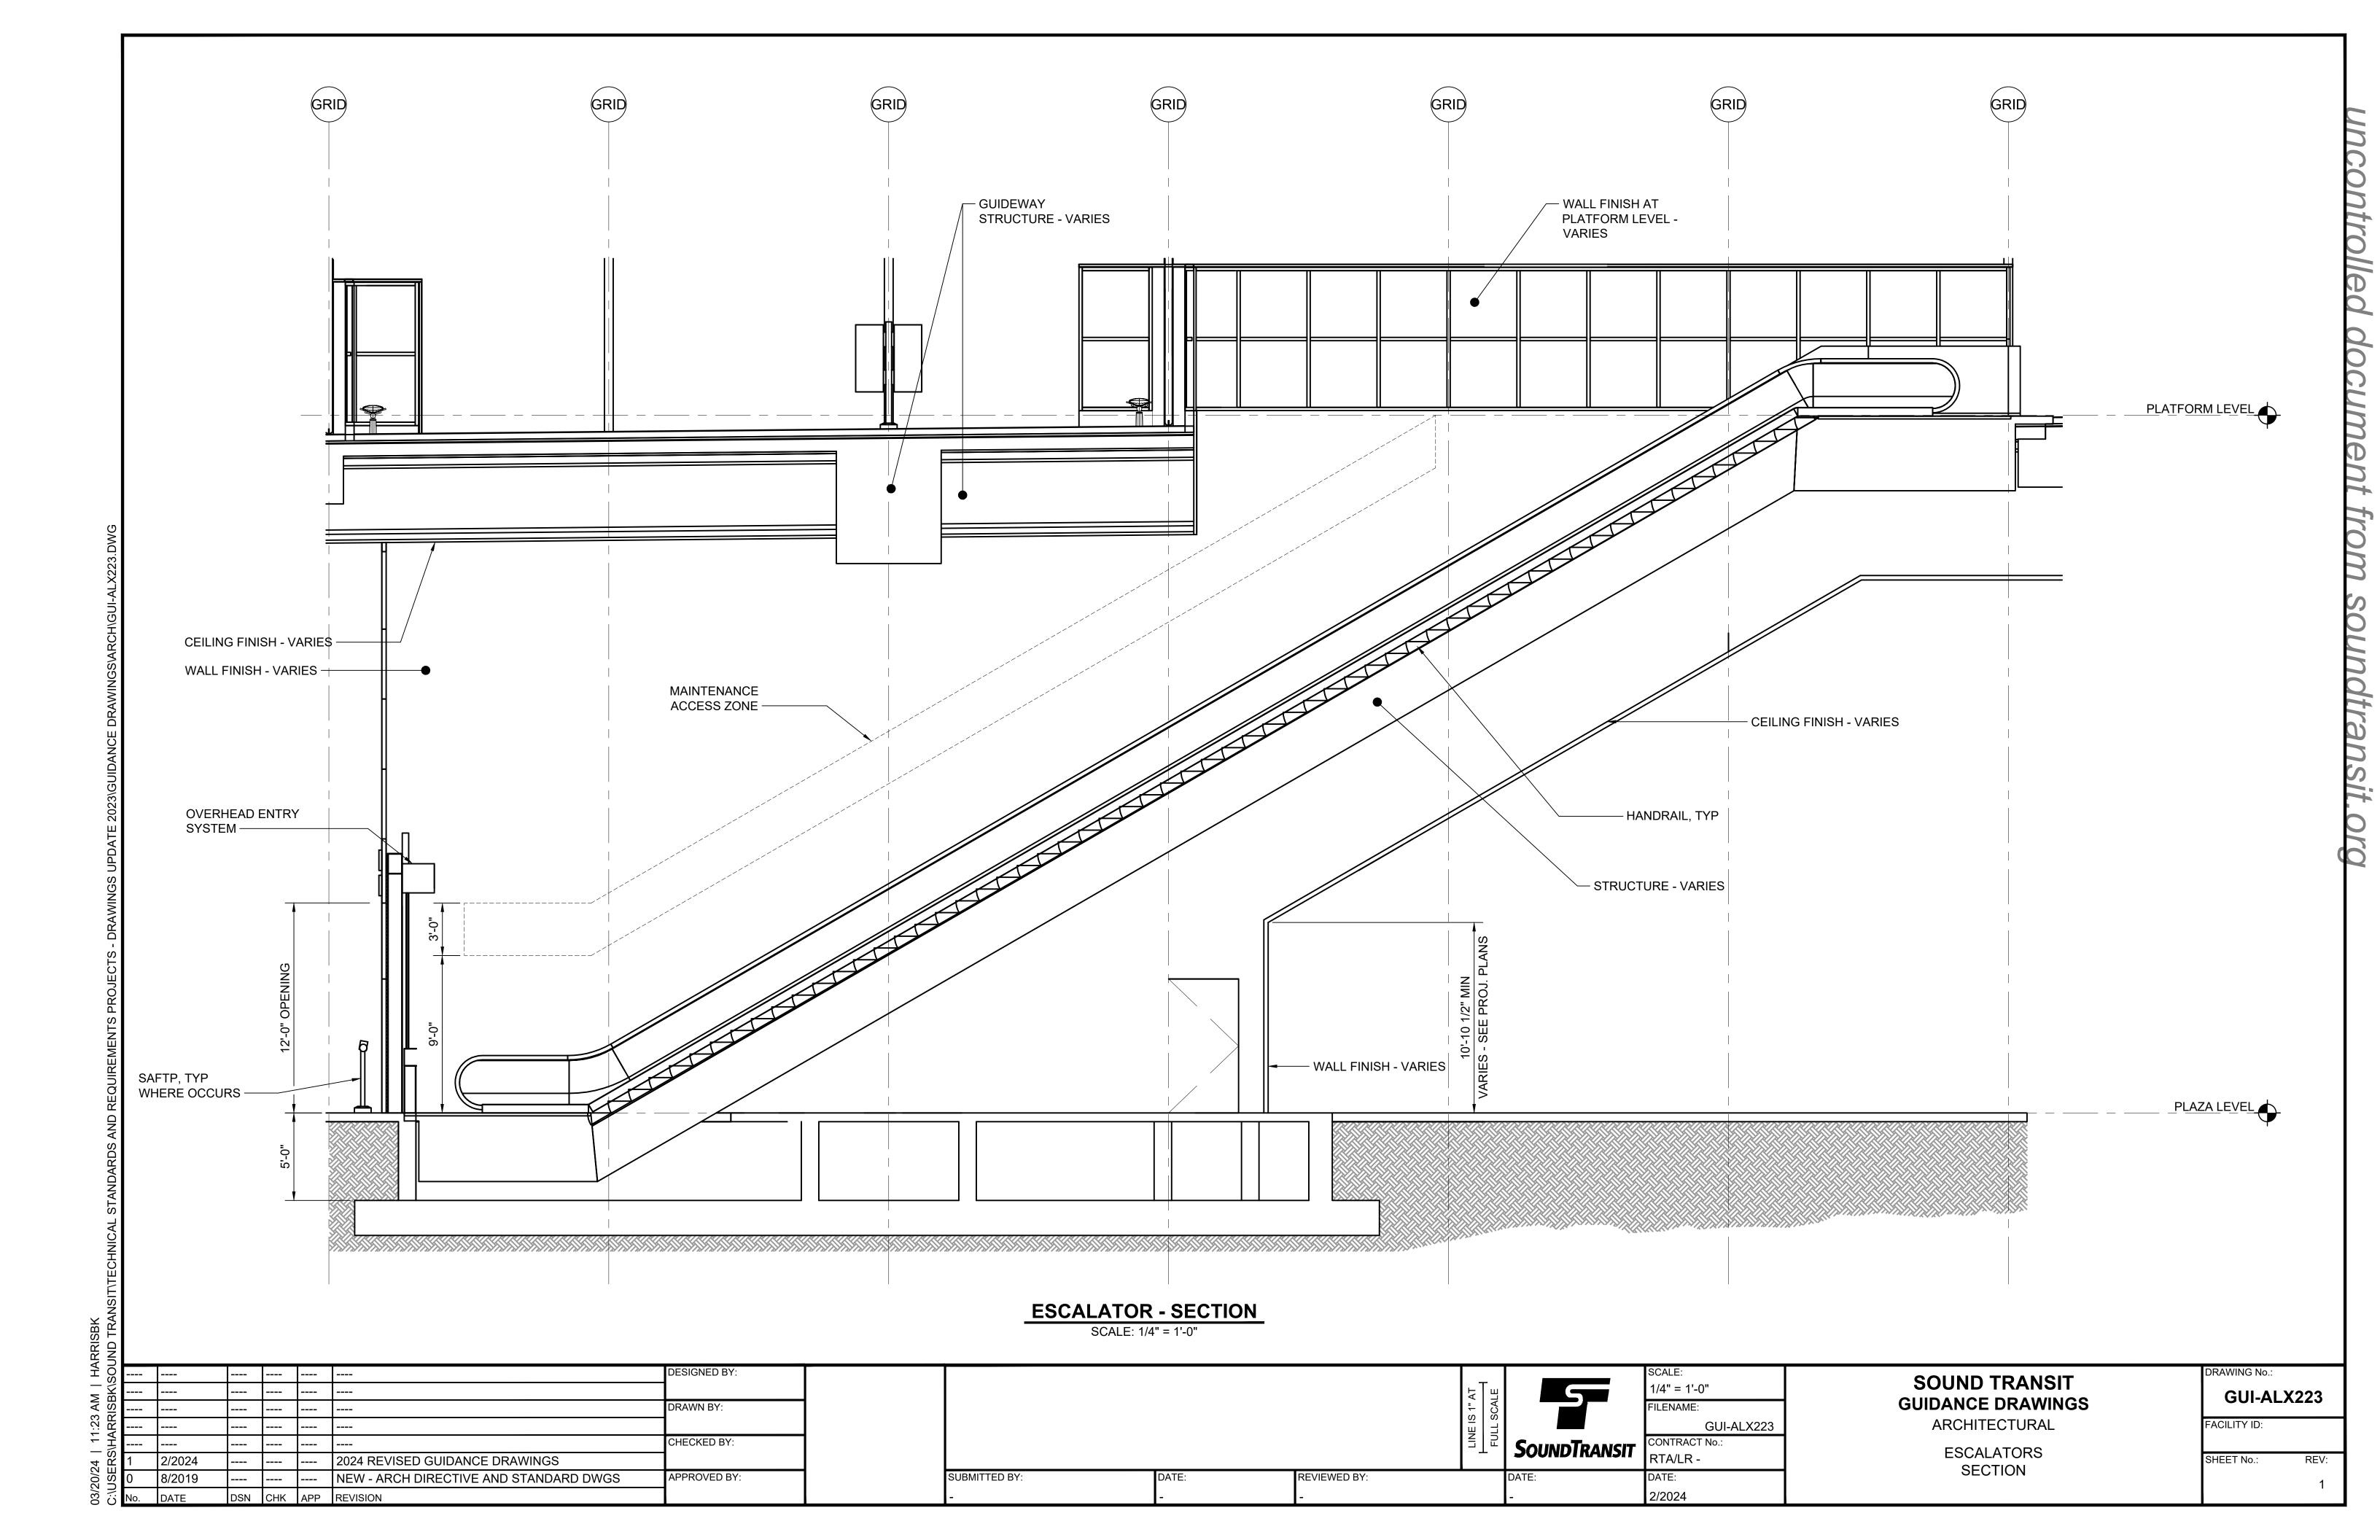
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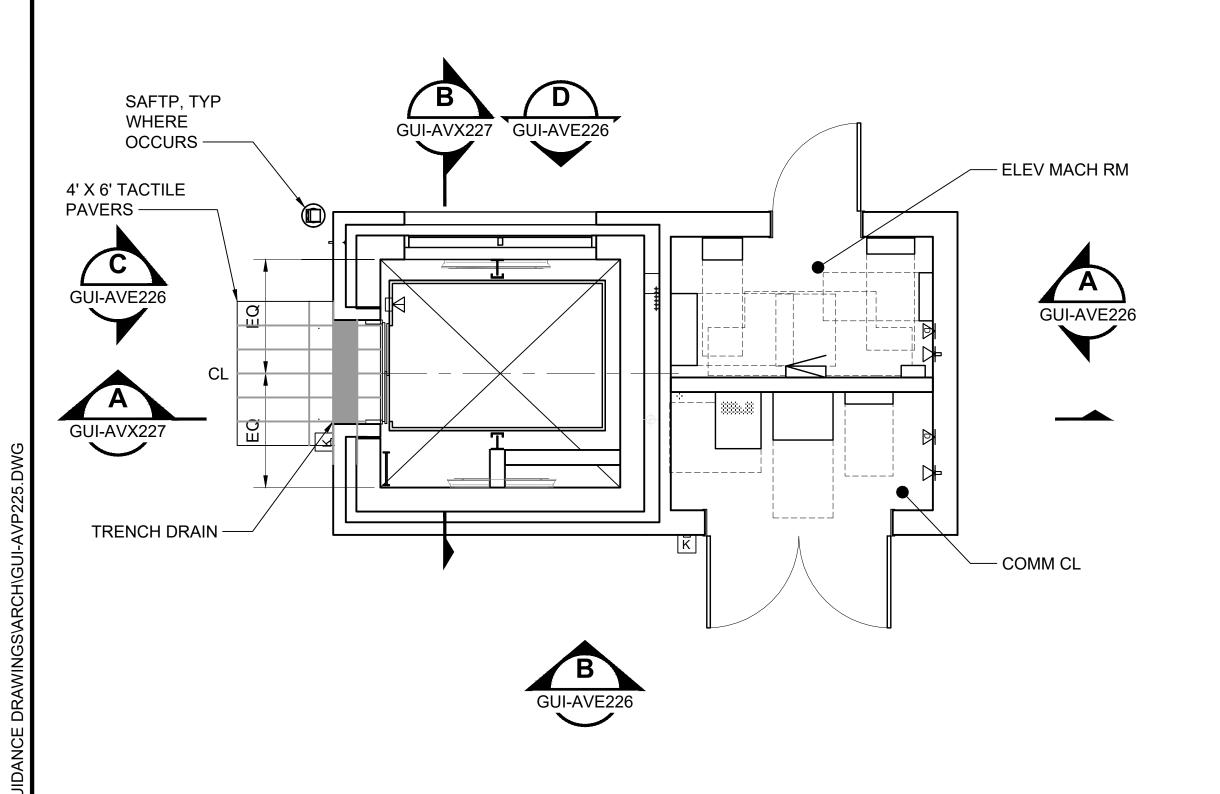
SOUND TRANSIT GUIDANCE DRAWINGS ARCHITECTURAL

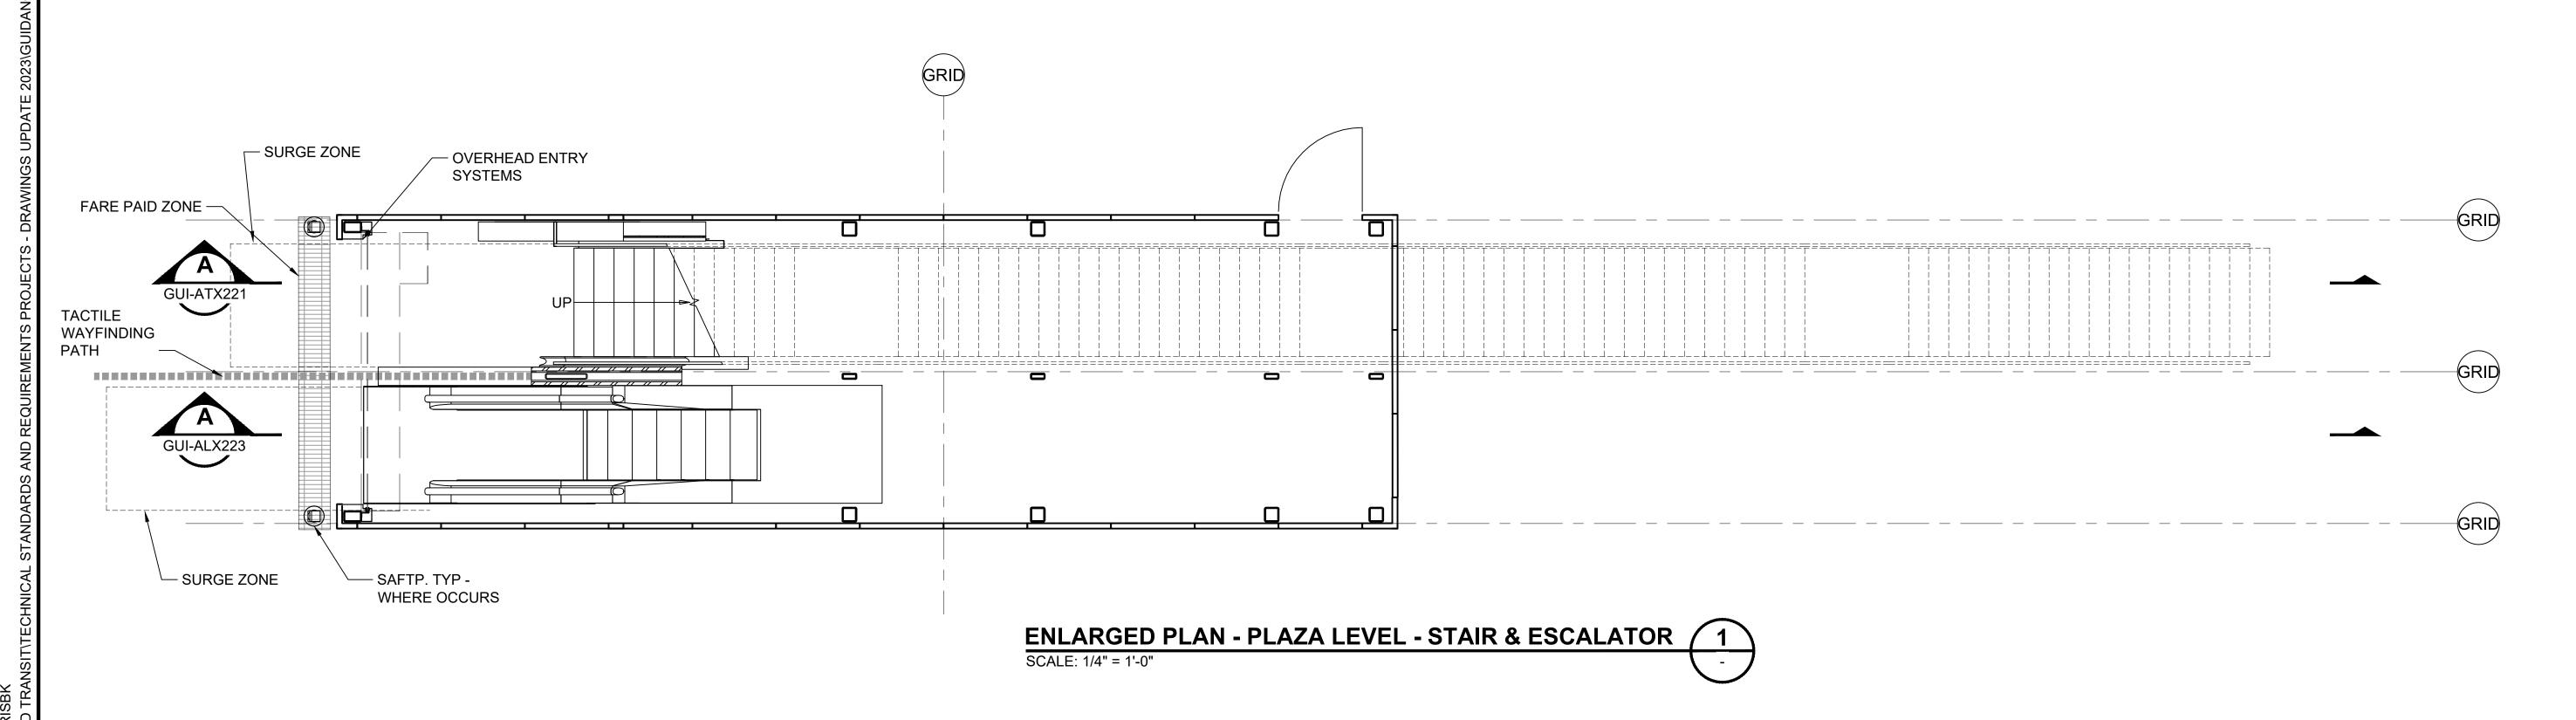PUBLIC STAIRS AND ESCOLATORS ENLARGED PLANS


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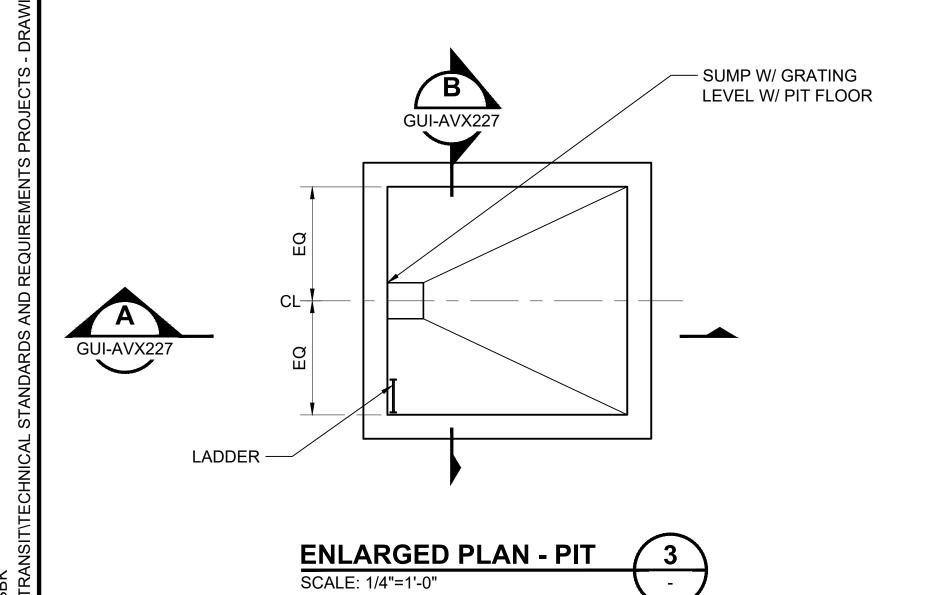
ENLARGED PLAN - PLAZA LEVEL



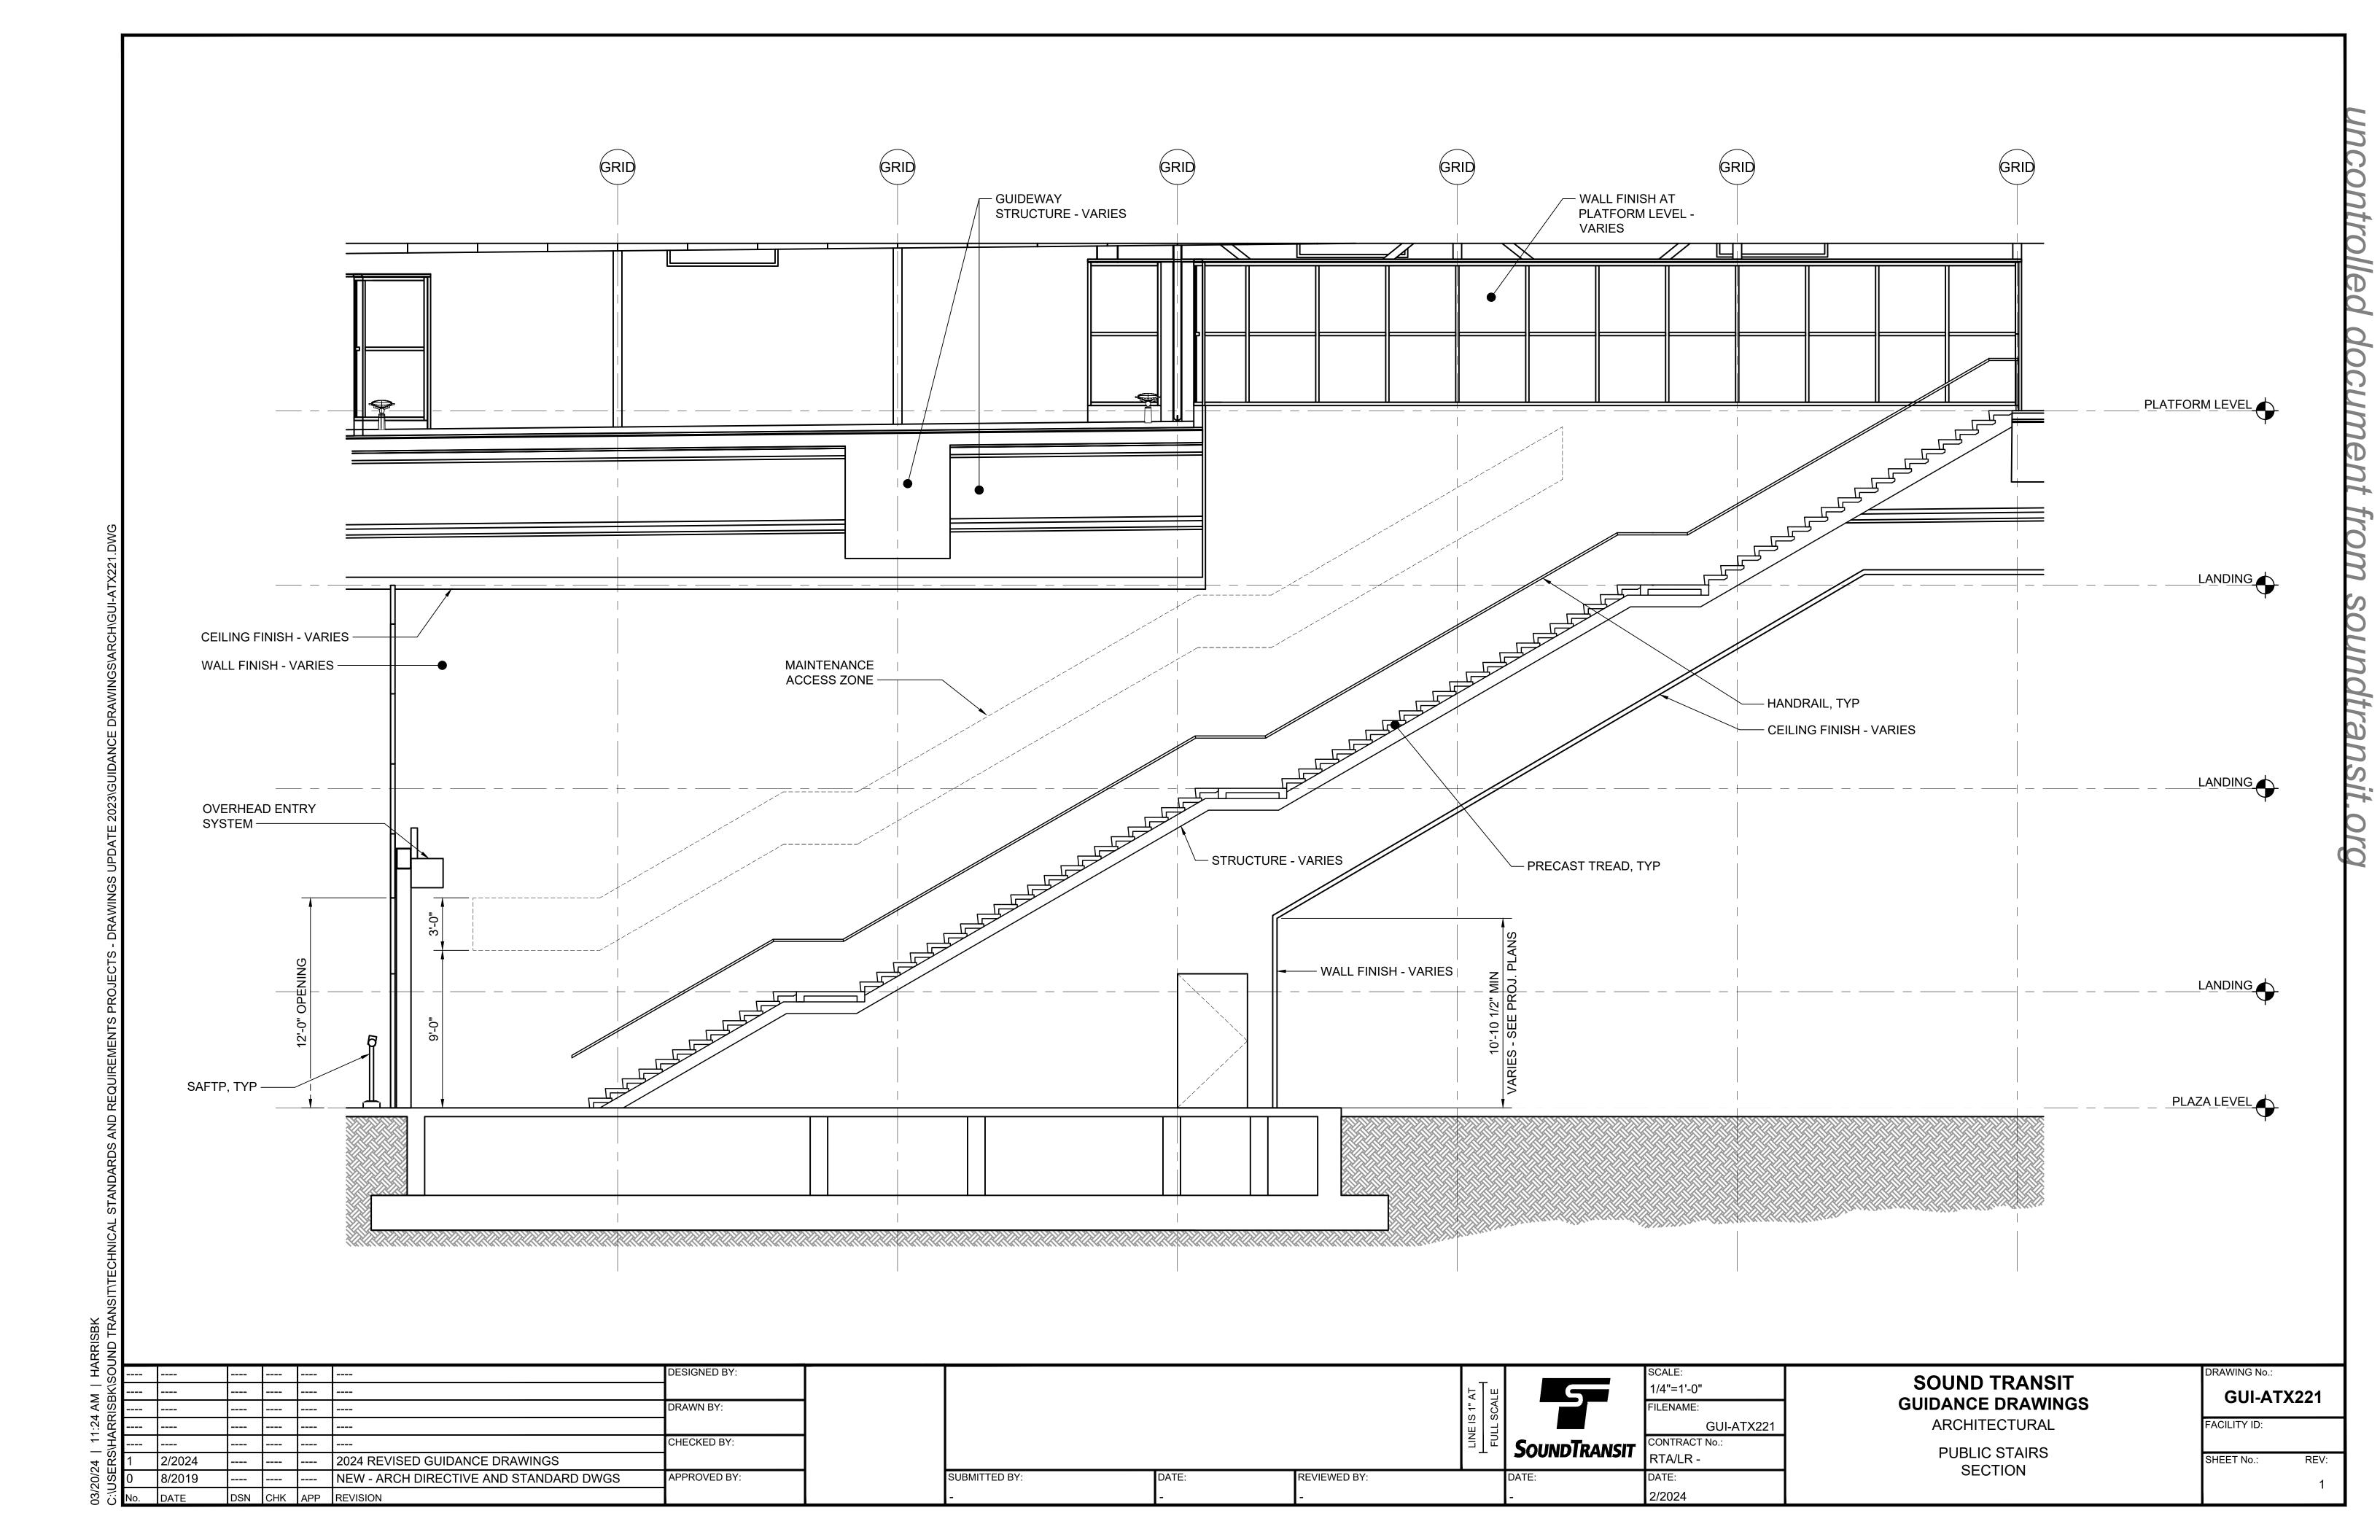

GENERAL NOTES:

- 1. COMPLY WITH SEISMIC REQUIREMENTS.
- 2. GROUT BEHIND ALL HOISTWAY PENETRATIONS FOR PIPES, FIXTURES, ETC.
- 3. INSTALL APPROVED KEY RETAINER BOX, KEYED TO THE SECURE CITY KEY.
- 4. KEYS REQUIRED FOR THE OPERATION OF ELEVATOR, FIRE EMERGENCY SERVICE, THE MACHINE ROOM AND THE MECHANICAL HOISTWAY ACCESS KEY SHALL BE TAGGED AND KEPT IN THE KEY BOX.
- 5. PROVIDE SELF-CLOSING, SELF-LOCKING MACHINE ROOM ACCESS DOOR.
- 6. PROVIDE LIGHTS, LIGHT SWITCHES AND GFCI-PROTECTED UTILITY OUTLETS. COORDINATE LOCATIONS WITH ELEVATOR CONTRACTOR.
- 7. FOR EQUIPMENT IN THE MACHINE ROOM, A CLEARANCE OF NOT LESS THAN 18" SHALL BE PROVIDED IN THE DIRECTION(S) REQUIRED FOR MAINTENANCE, AND A CLEAR PATH OF NOT LESS THAN 18" SHALL BE PROVIDED TO ALL COMPONENTS THAT REQUIRE MAINTENANCE.
- 8. PROVIDE SEPARATE CIRCUIT WITH LOCKABLE MEANS OF DISCONNECT FOR CAB LIGHTS/EXHAUST FAN.
- 9. PROVIDE ADEQUATE LIGHTING TO MAINTAIN MIN. 10 FC ILLUMINATION AT PIT FLOOR.
- 10.PROVIDE PIT ACCESS LADDER, LIGHT SWITCH, LIGHT(S), AND GFCI RECEPTACLE.

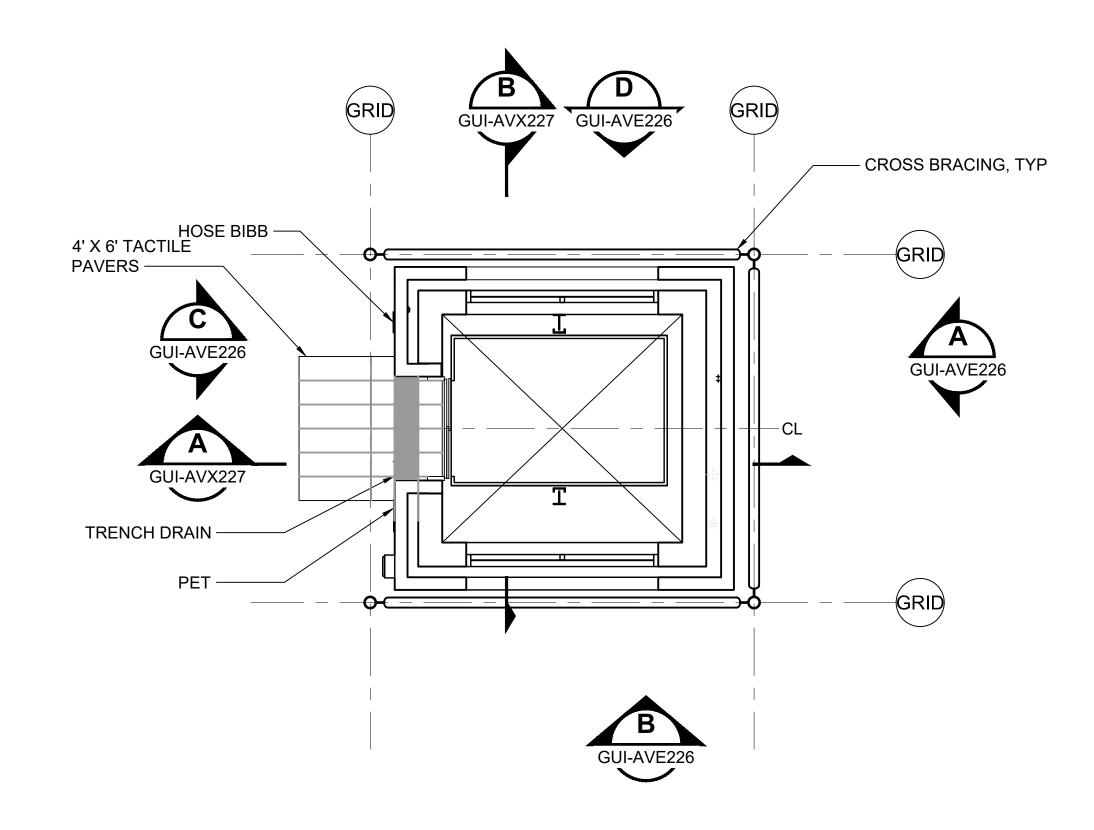

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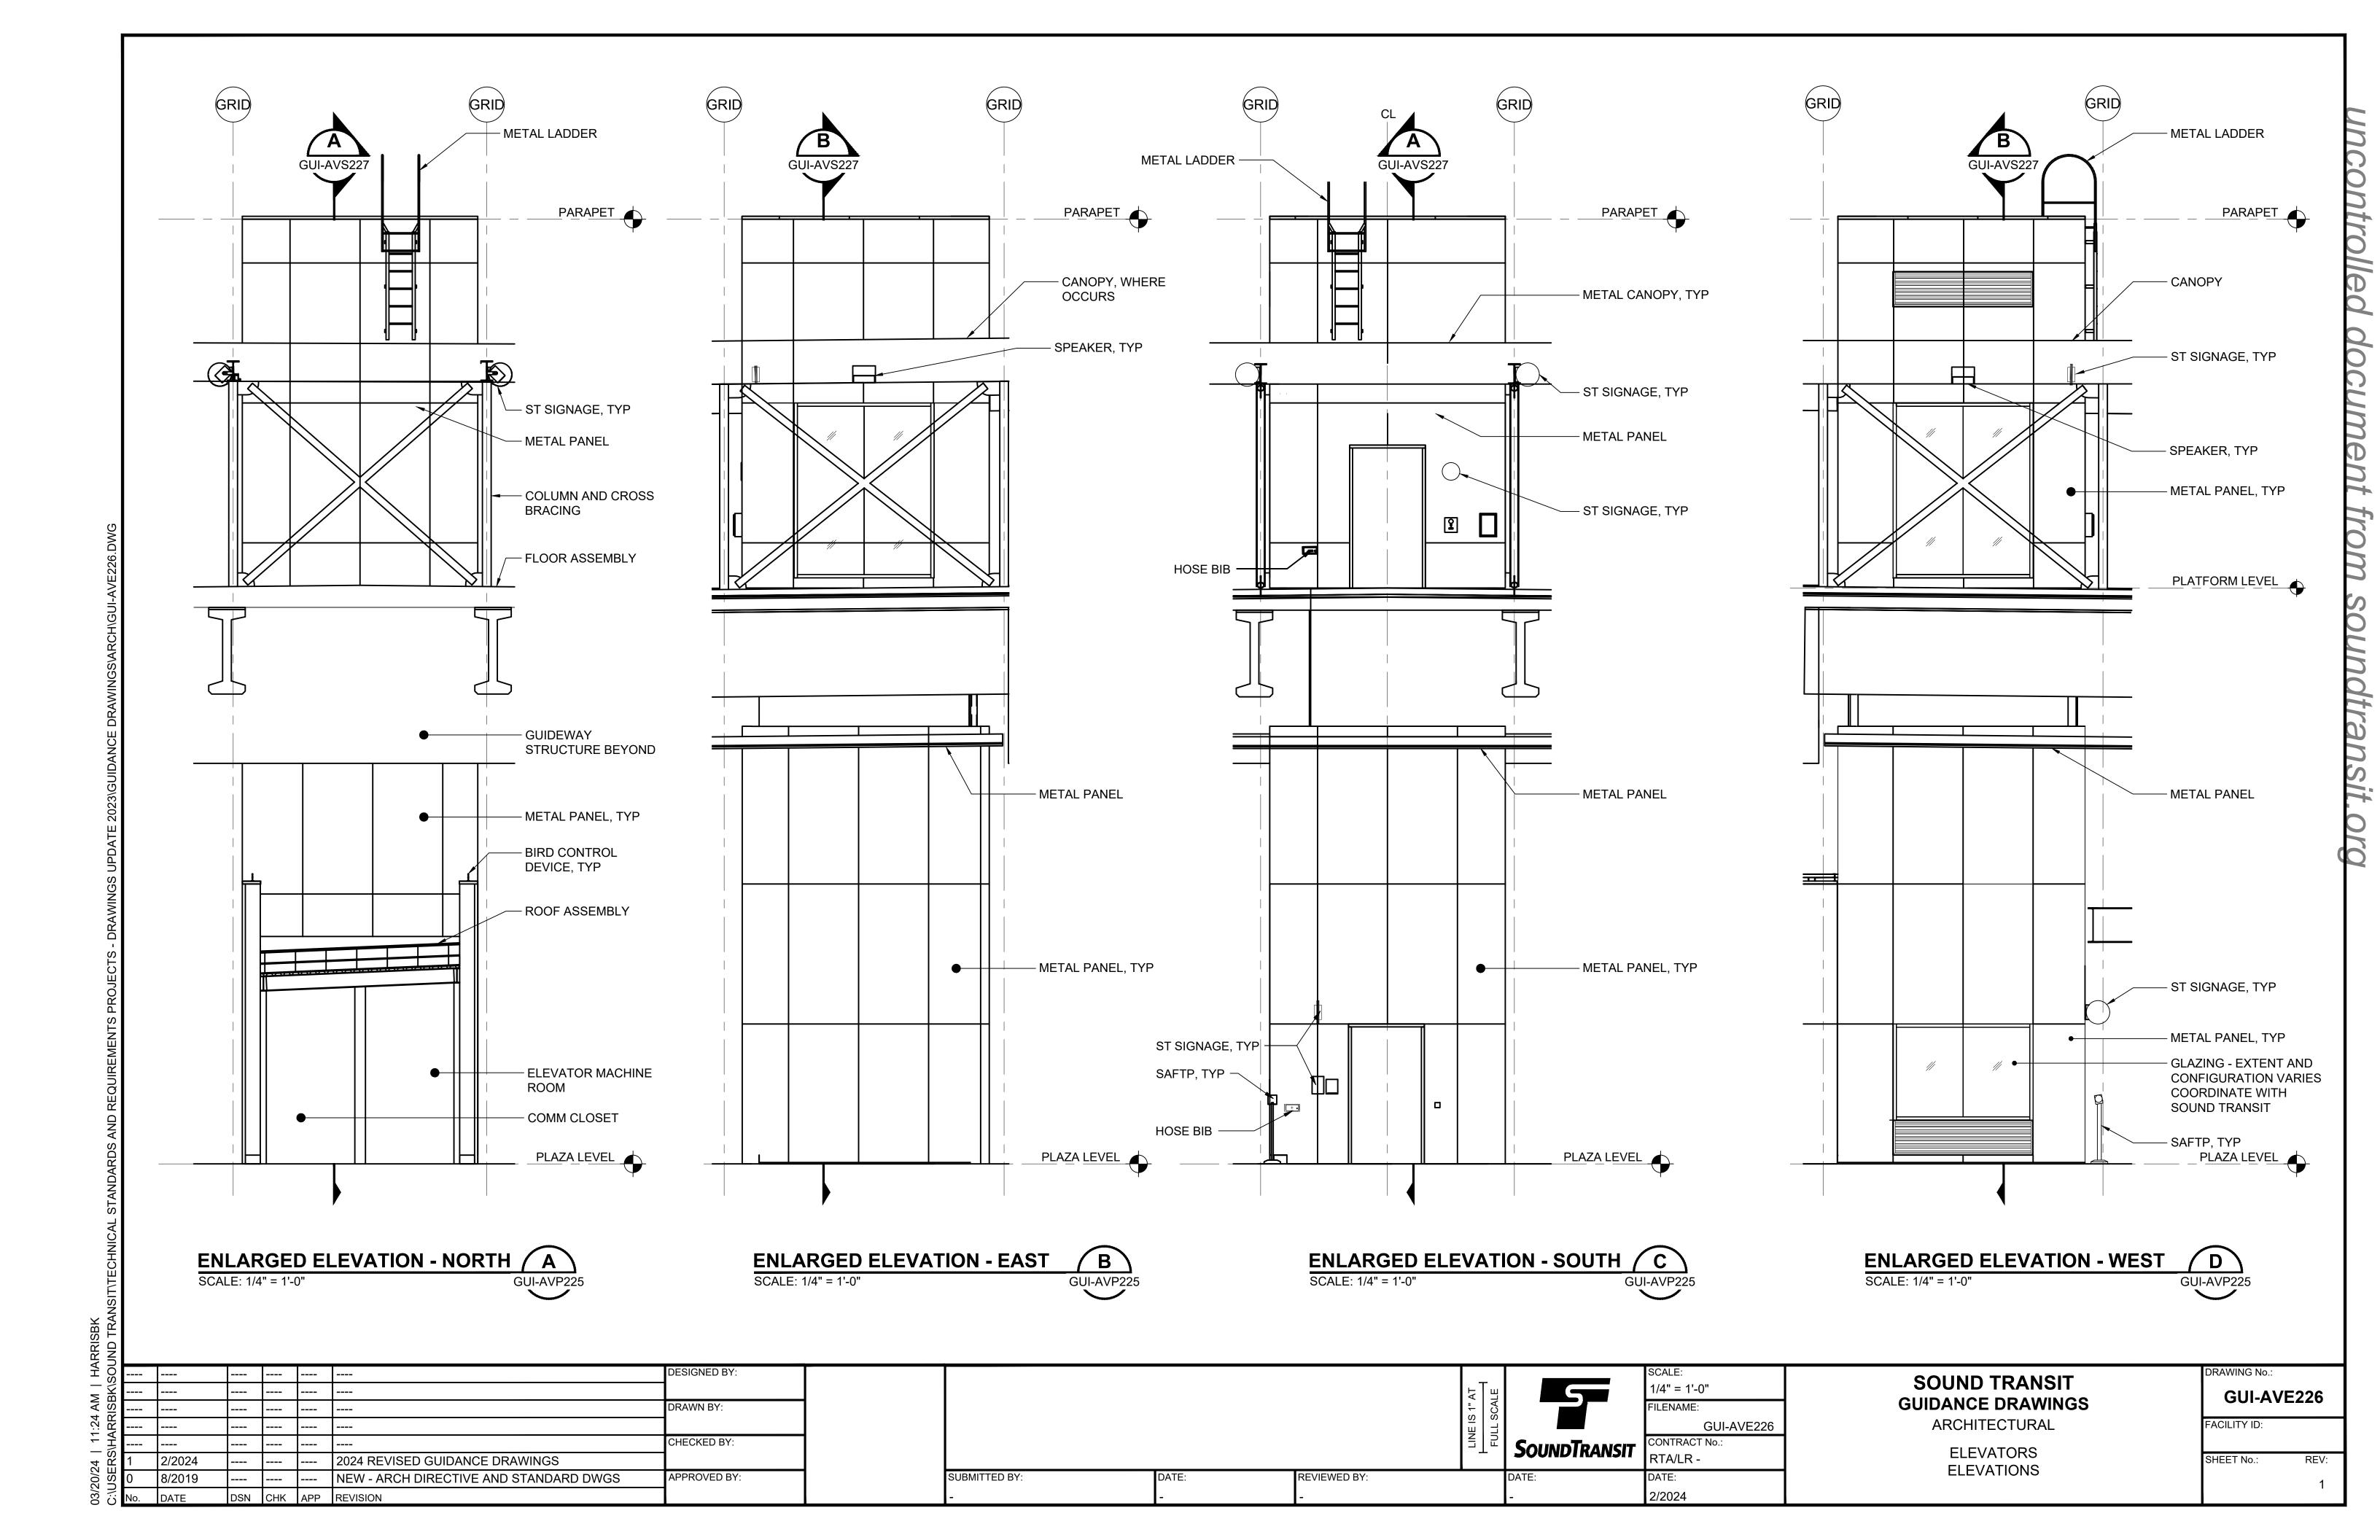
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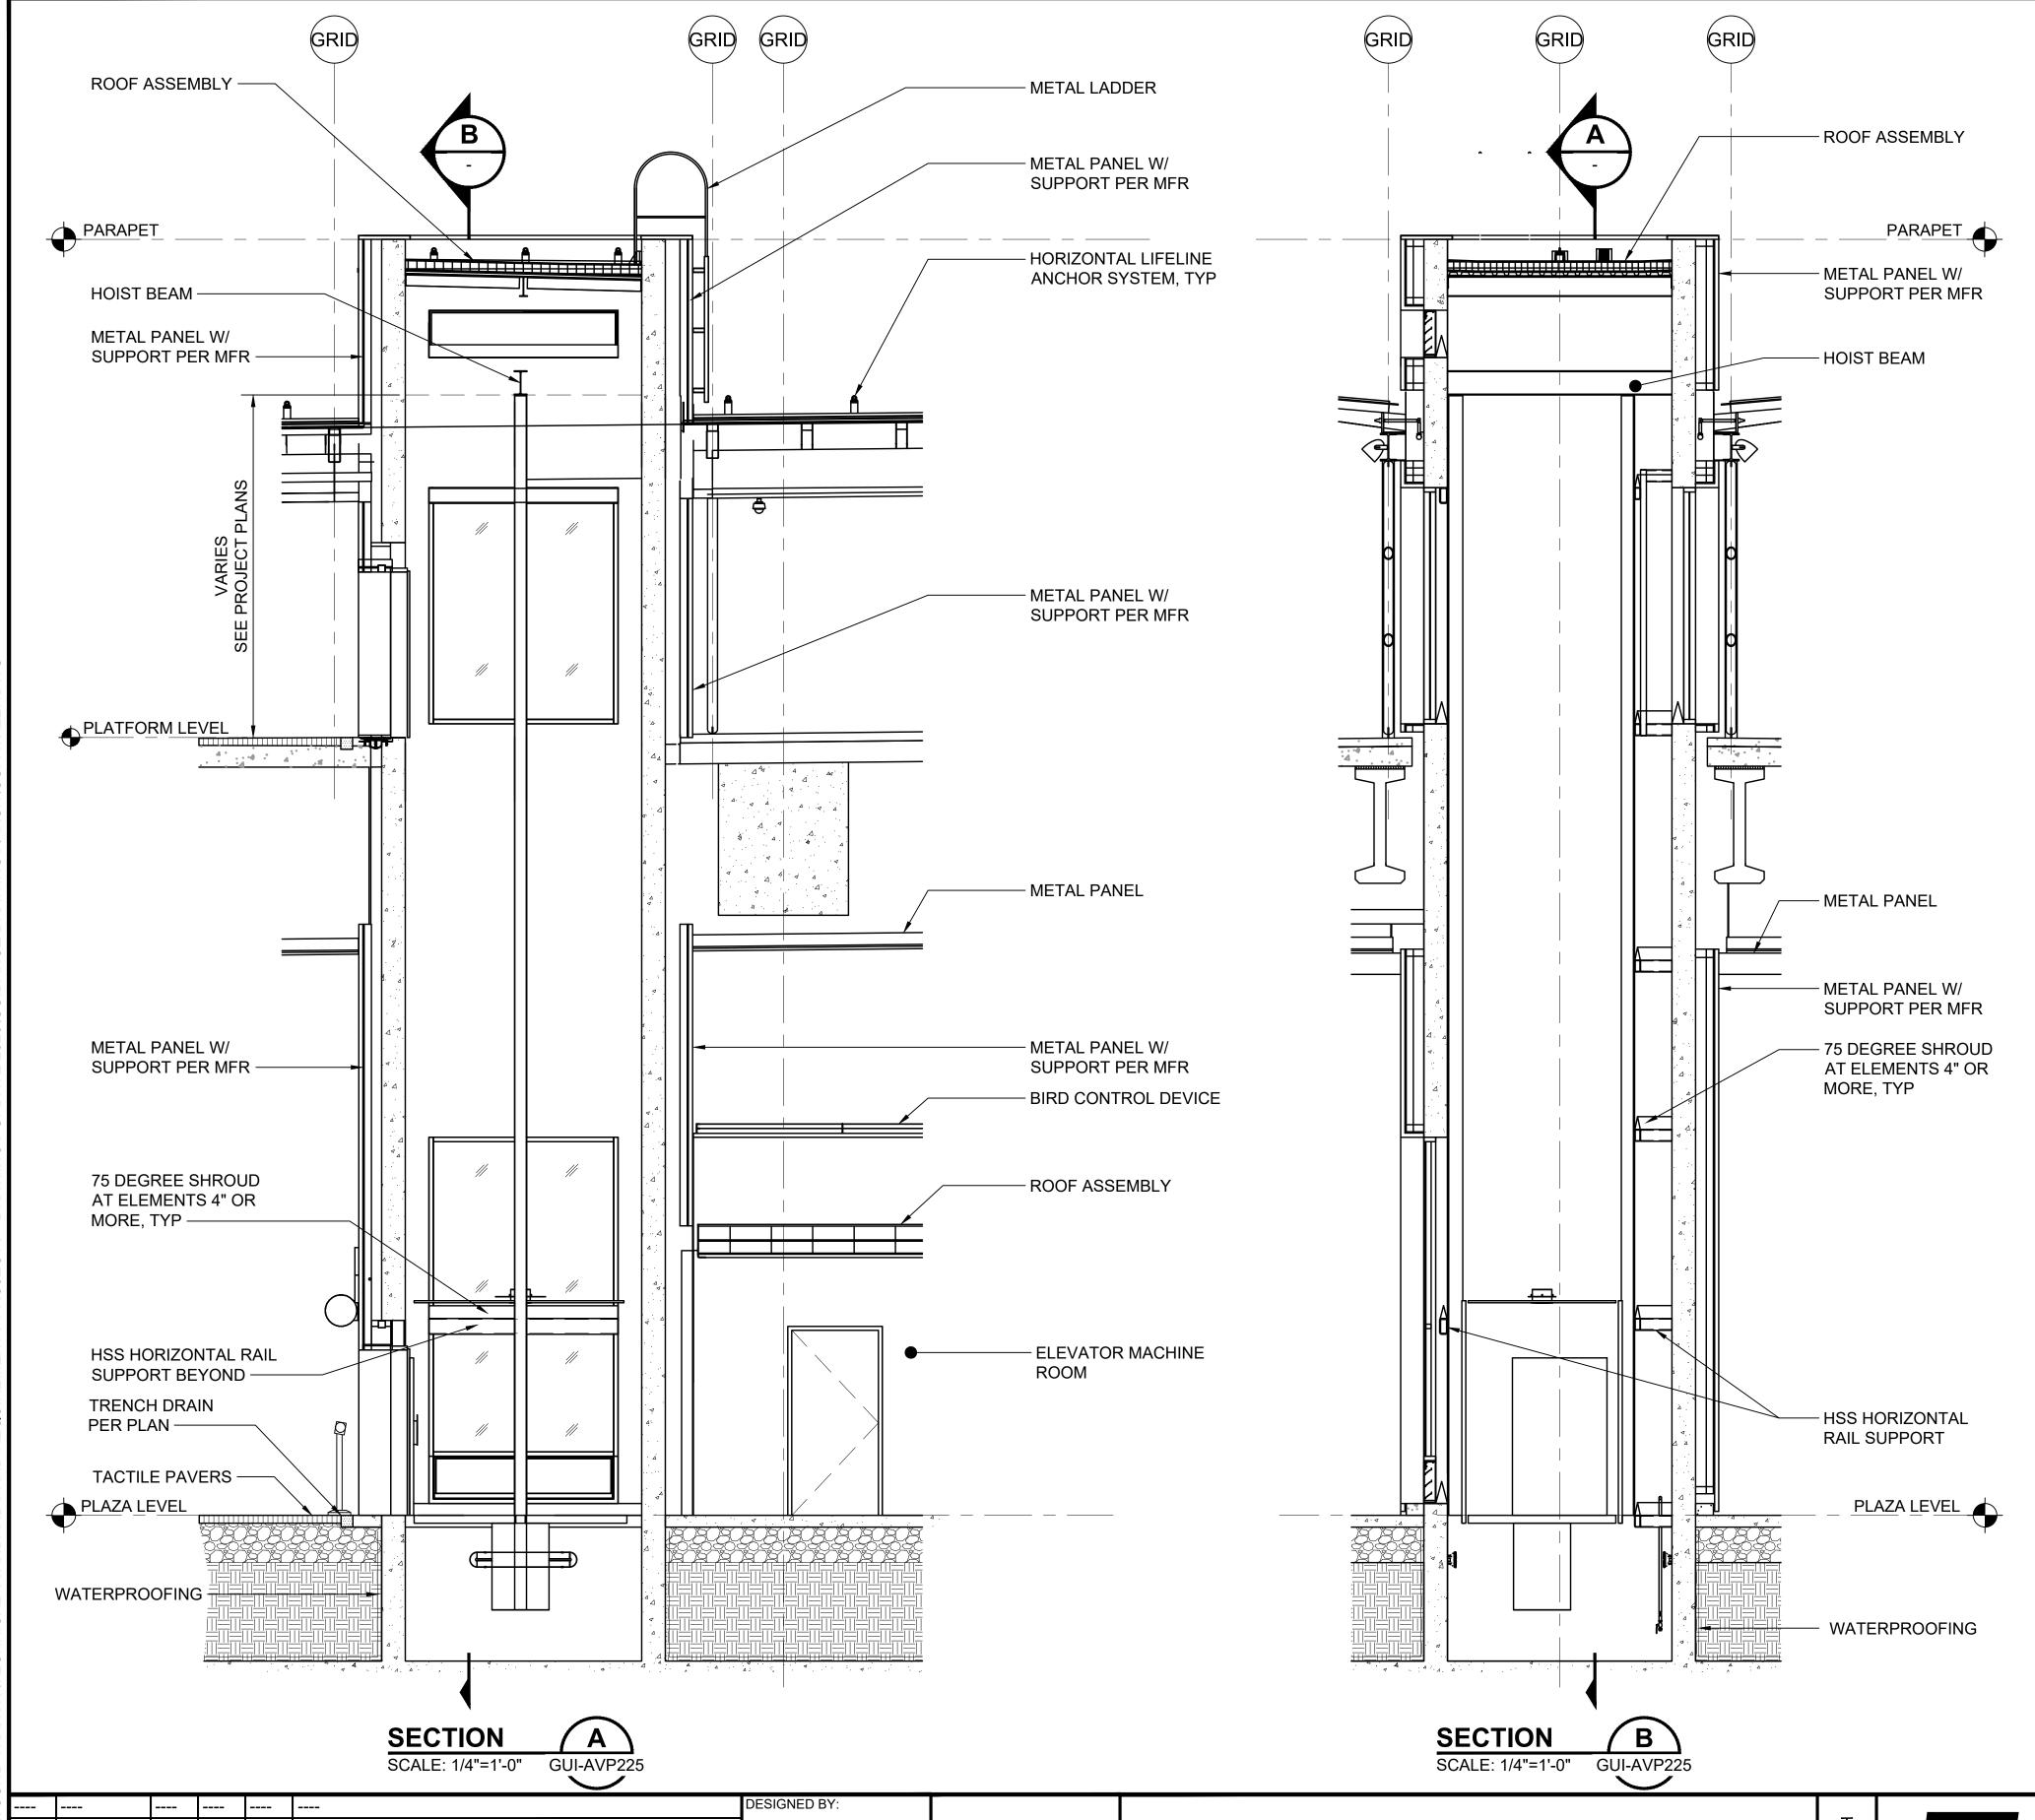
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GUI-AVP225
FACILITY ID:

ELEVATORS ENLARGED PLANS SHEET No.: REV:

RAWING No.:





- 1. BLOCK-OUTS THROUGH MACHINE ROOM FLOOR AND/OR WALLS FOR HYDRAULIC OIL LINE, AND ELECTRICAL WIRING DUCTS. VERIFY LOCATION ON ELEVATOR CONTRACTOR SHOP DRAWINGS.
- 2. SELF-CLOSING, SELF-LOCKING ACCESS DOOR OR GATE FOR MACHINE ROOM. KEYING MUST BE INDEPENDENT OF ANY OTHER BUILDING LOCKS. DOOR OR GATE SHALL BE OPENABLE FROM INSIDE WITHOUT KEY. RECOMMEND MINIMUM 3'-0" X 7'-0" SOUND-ATTENUATING DOORS COORDINATED TO ALLOW INSTALL/REMOVAL OF ANY RELATED EQUIPMENT.
- 3. MINIMUM HEADROOM CLEARANCES: 8'-0" RECOMMENDED UNDER MACHINE ROOM CEILING SPACE CEILING 7'-6" UNDER ENCROACHING BEAMS (INCLUDING FIREPROOFING).
- 4. CLASS "ABC" FIRE EXTINGUISHER IN EACH ELEVATOR MACHINE ROOM.
- 5. ONLY EQUIPMENT USED IN CONJUNCTION WITH THE FUNCTION OF THE ELEVATOR SHALL BE PERMITTED IN THE ELEVATOR MACHINE ROOM. ACCESS THROUGH ELEVATOR MACHINE ROOM TO ADJACENT ROOMS OR AREAS SHALL NOT BE PERMITTED. PERMANENT AND UNOBSTRUCTED ACCESS TO MACHINE ROOM SHALL BE PROVIDED FOR AUTHORIZED PERSONNEL.
- 6. BEVEL CANTS NOT LESS THAN 75° FROM THE HORIZONTAL ON ANY REAR OR SIDE WALL LEDGES AND BEAMS THAT PROJECT OR RECESS 4" OR MORE INTO THE HOISTWAY. CANTS NOT REQUIRED ON DIVIDER BEAMS. ENCLOSE WEB OF HOISTWAY STEEL FRAMING.
- 7. DIVIDER BEAMS BETWEEN ADJACENT ELEVATORS AT EACH FLOOR, PIT AND OVERHEAD. DIVIDER BEAMS NEED NOT BE FIREPROOFED.
- 8. SOUND-ATTENUATING ASSEMBLIES FOR WALLS OF MACHINE ROOM, CONTROLLER SPACE AND/OR HOISTWAY WHERE SOUND-SENSITIVE AREAS ARE ADJACENT.
- 9. PIT ACCESS LADDER FOR EACH ELEVATOR THAT DOES NOT HAVE A WALK-IN PIT.
- 10. STRUCTURAL PIT FLOOR FOR HYDRAULIC CYLINDERS, GUIDE RAIL, AND BUFFER LOADS. CYLINDER, GUIDE RAIL, AND BUFFER IMPACT LOADS DO NOT OCCUR SIMULTANEOUSLY.
- 11. WATERPROOF PIT. SUMP WITH FLUSH GRATE.

SOUND TRANSIT GUIDANCE DRAWINGS ARCHITECTURAL

GUI-AVX227
FACILITY ID:

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SoundTransit (F)

FILENAME:

GUI-AVX227

CONTRACT No.:

RTA/LR -

2/2024

ELEVATORS SECTIONS

