

Refer to the plan set COVER drawing for disclaimers regarding this drawing. AHJ: PACKAGE # DESIGNED BY: DRAWING No.: **SOUND TRANSIT** REFERENCE CONCEPT DRAWINGS CHAN CHEANG DRAWN BY: AS NOTED M08-ASX002 9849 REGISTERED ARCHITECT **OPERATIONS & MAINTENANCE FACILITY SOUTH** FILENAME: PRELIMINARY ENGINEERING OMFS-M08-A-V2022.RV STEPHANIE GREEN FACILITY ID: CHAN LAM CHEANG STATE OF WASHINGTON SOUNDTRANSIT CONTRACT No.: CHECKED BY: M08 ARCHITECTURAL SECTIONS DONN HOGAN AE-0030-17 SHEET No: APPROVED BY: REVIEWED BY: SUBMITTAL DATE: OMF SECTIONS


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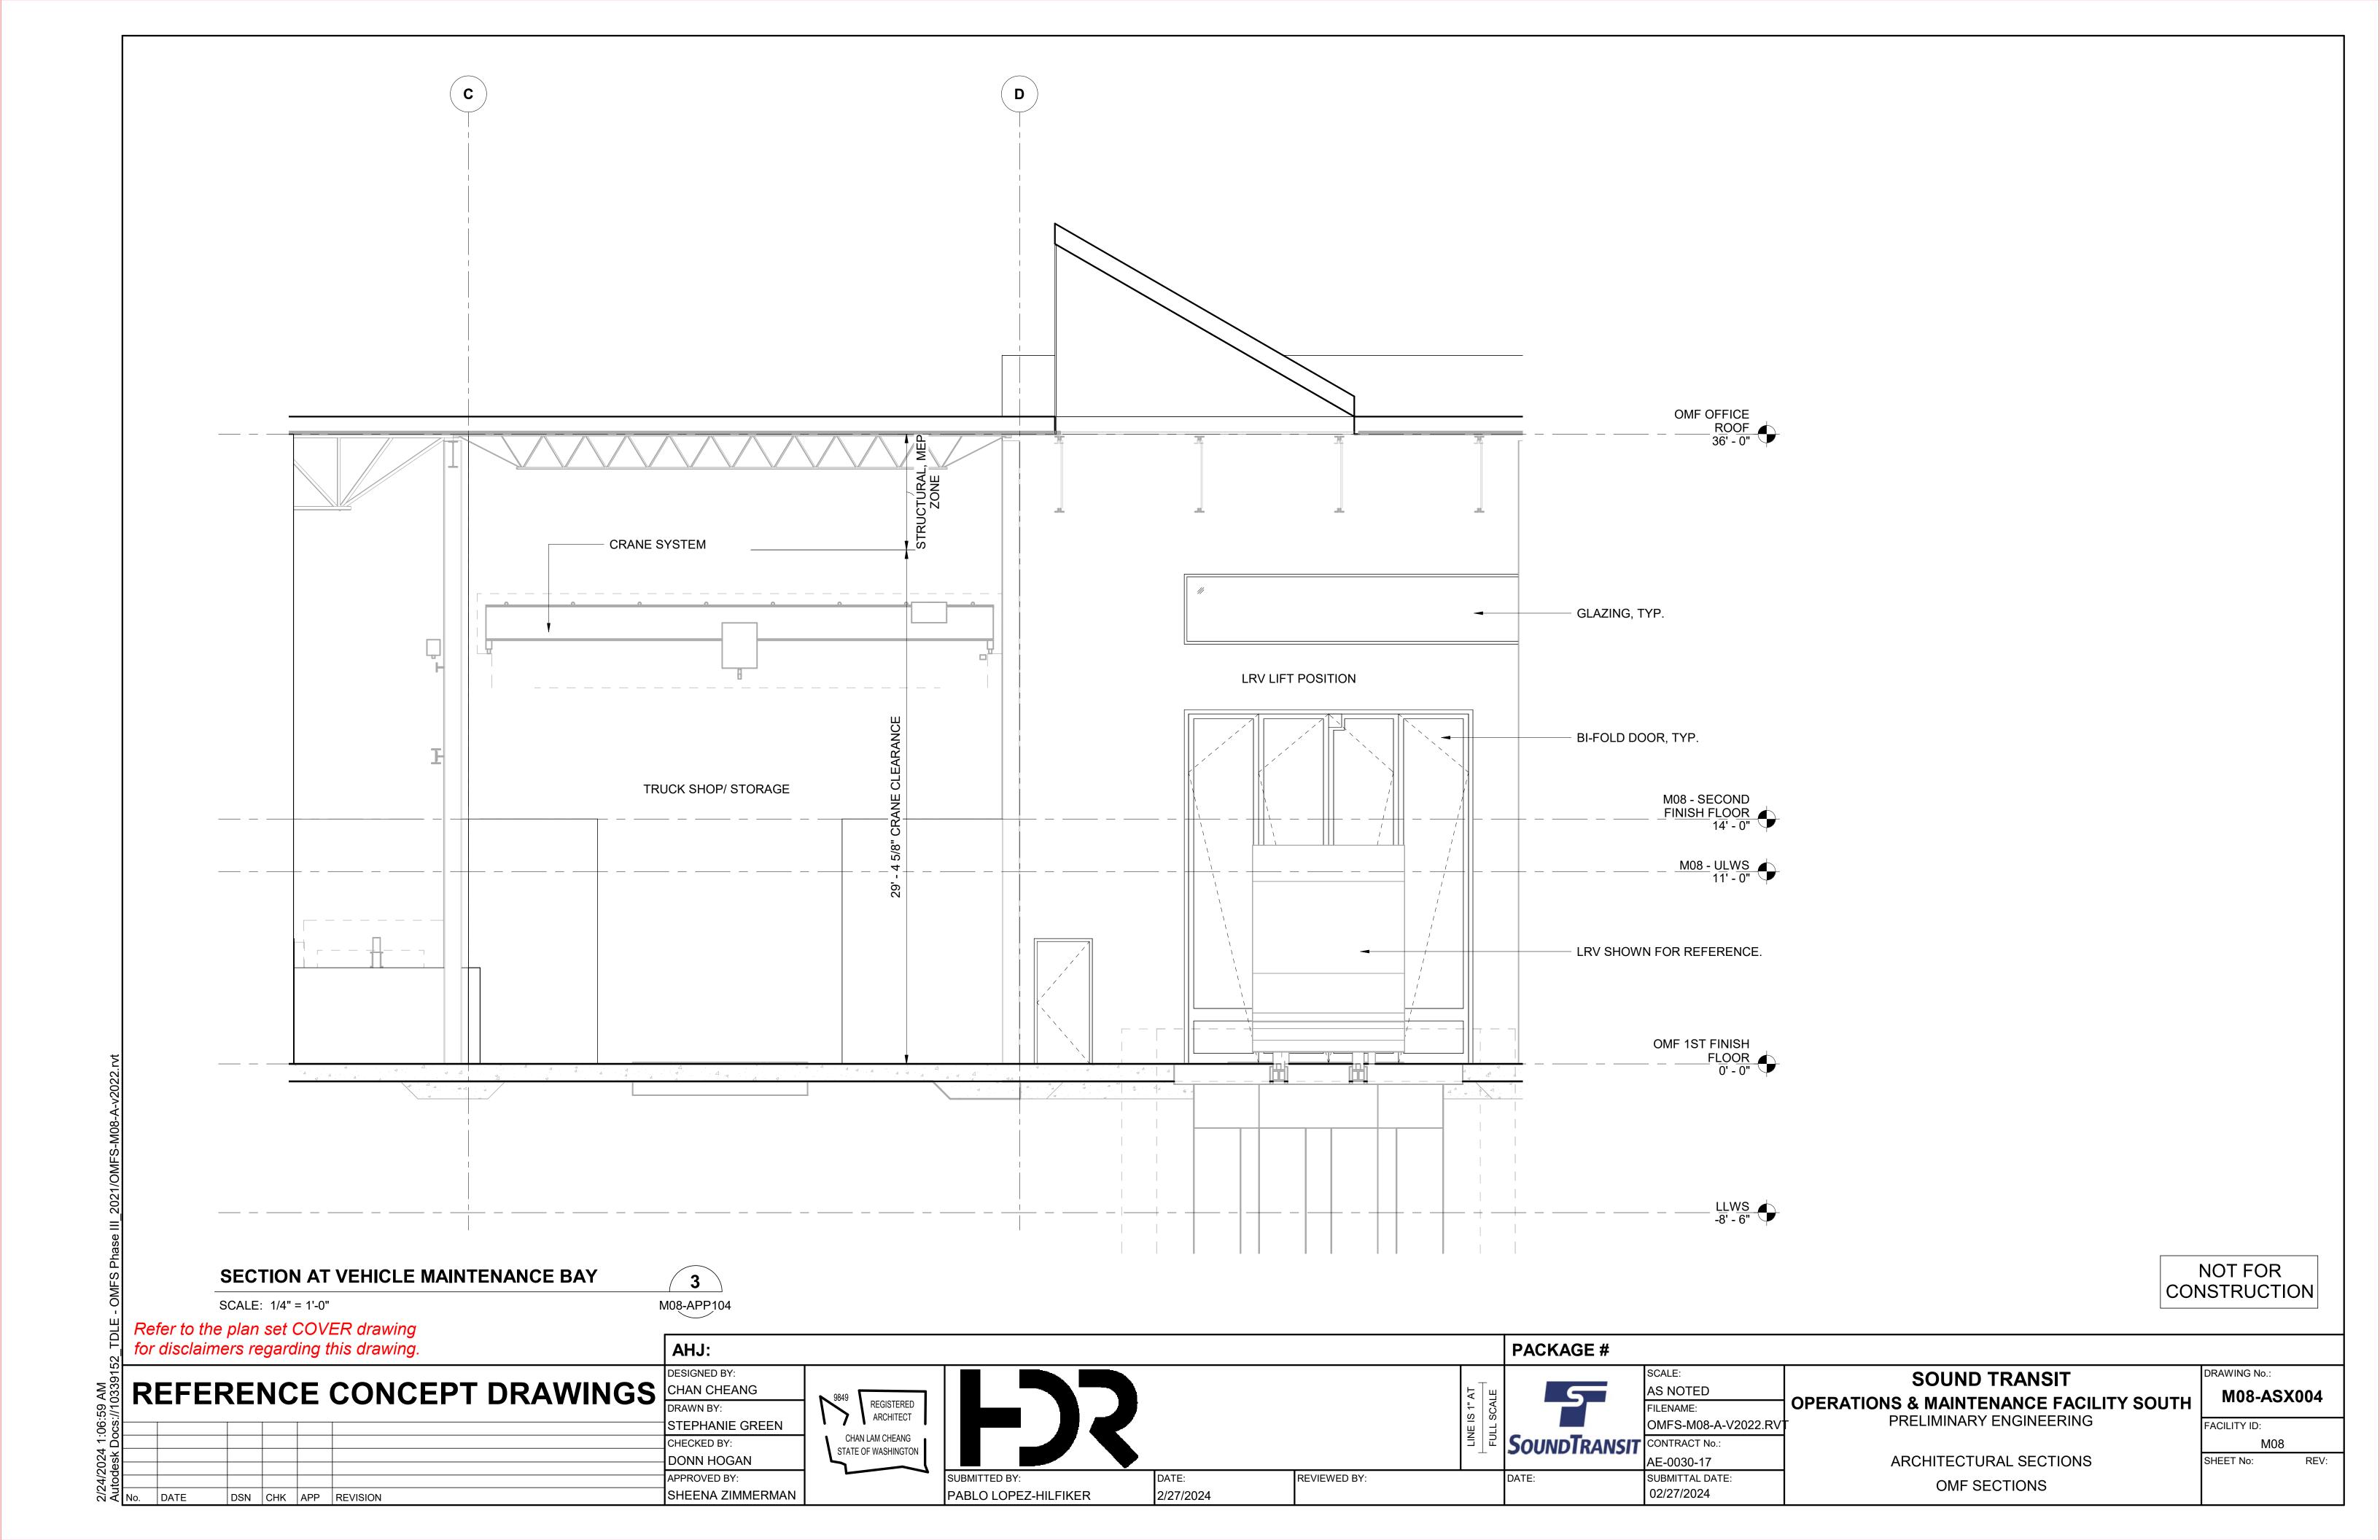
PABLO LOPEZ-HILFIKER


SHEENA ZIMMERMAN

DSN CHK APP REVISION



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DESIGNED BY: STEPHANIE GREEN CHECKED BY: DONN HOGAN

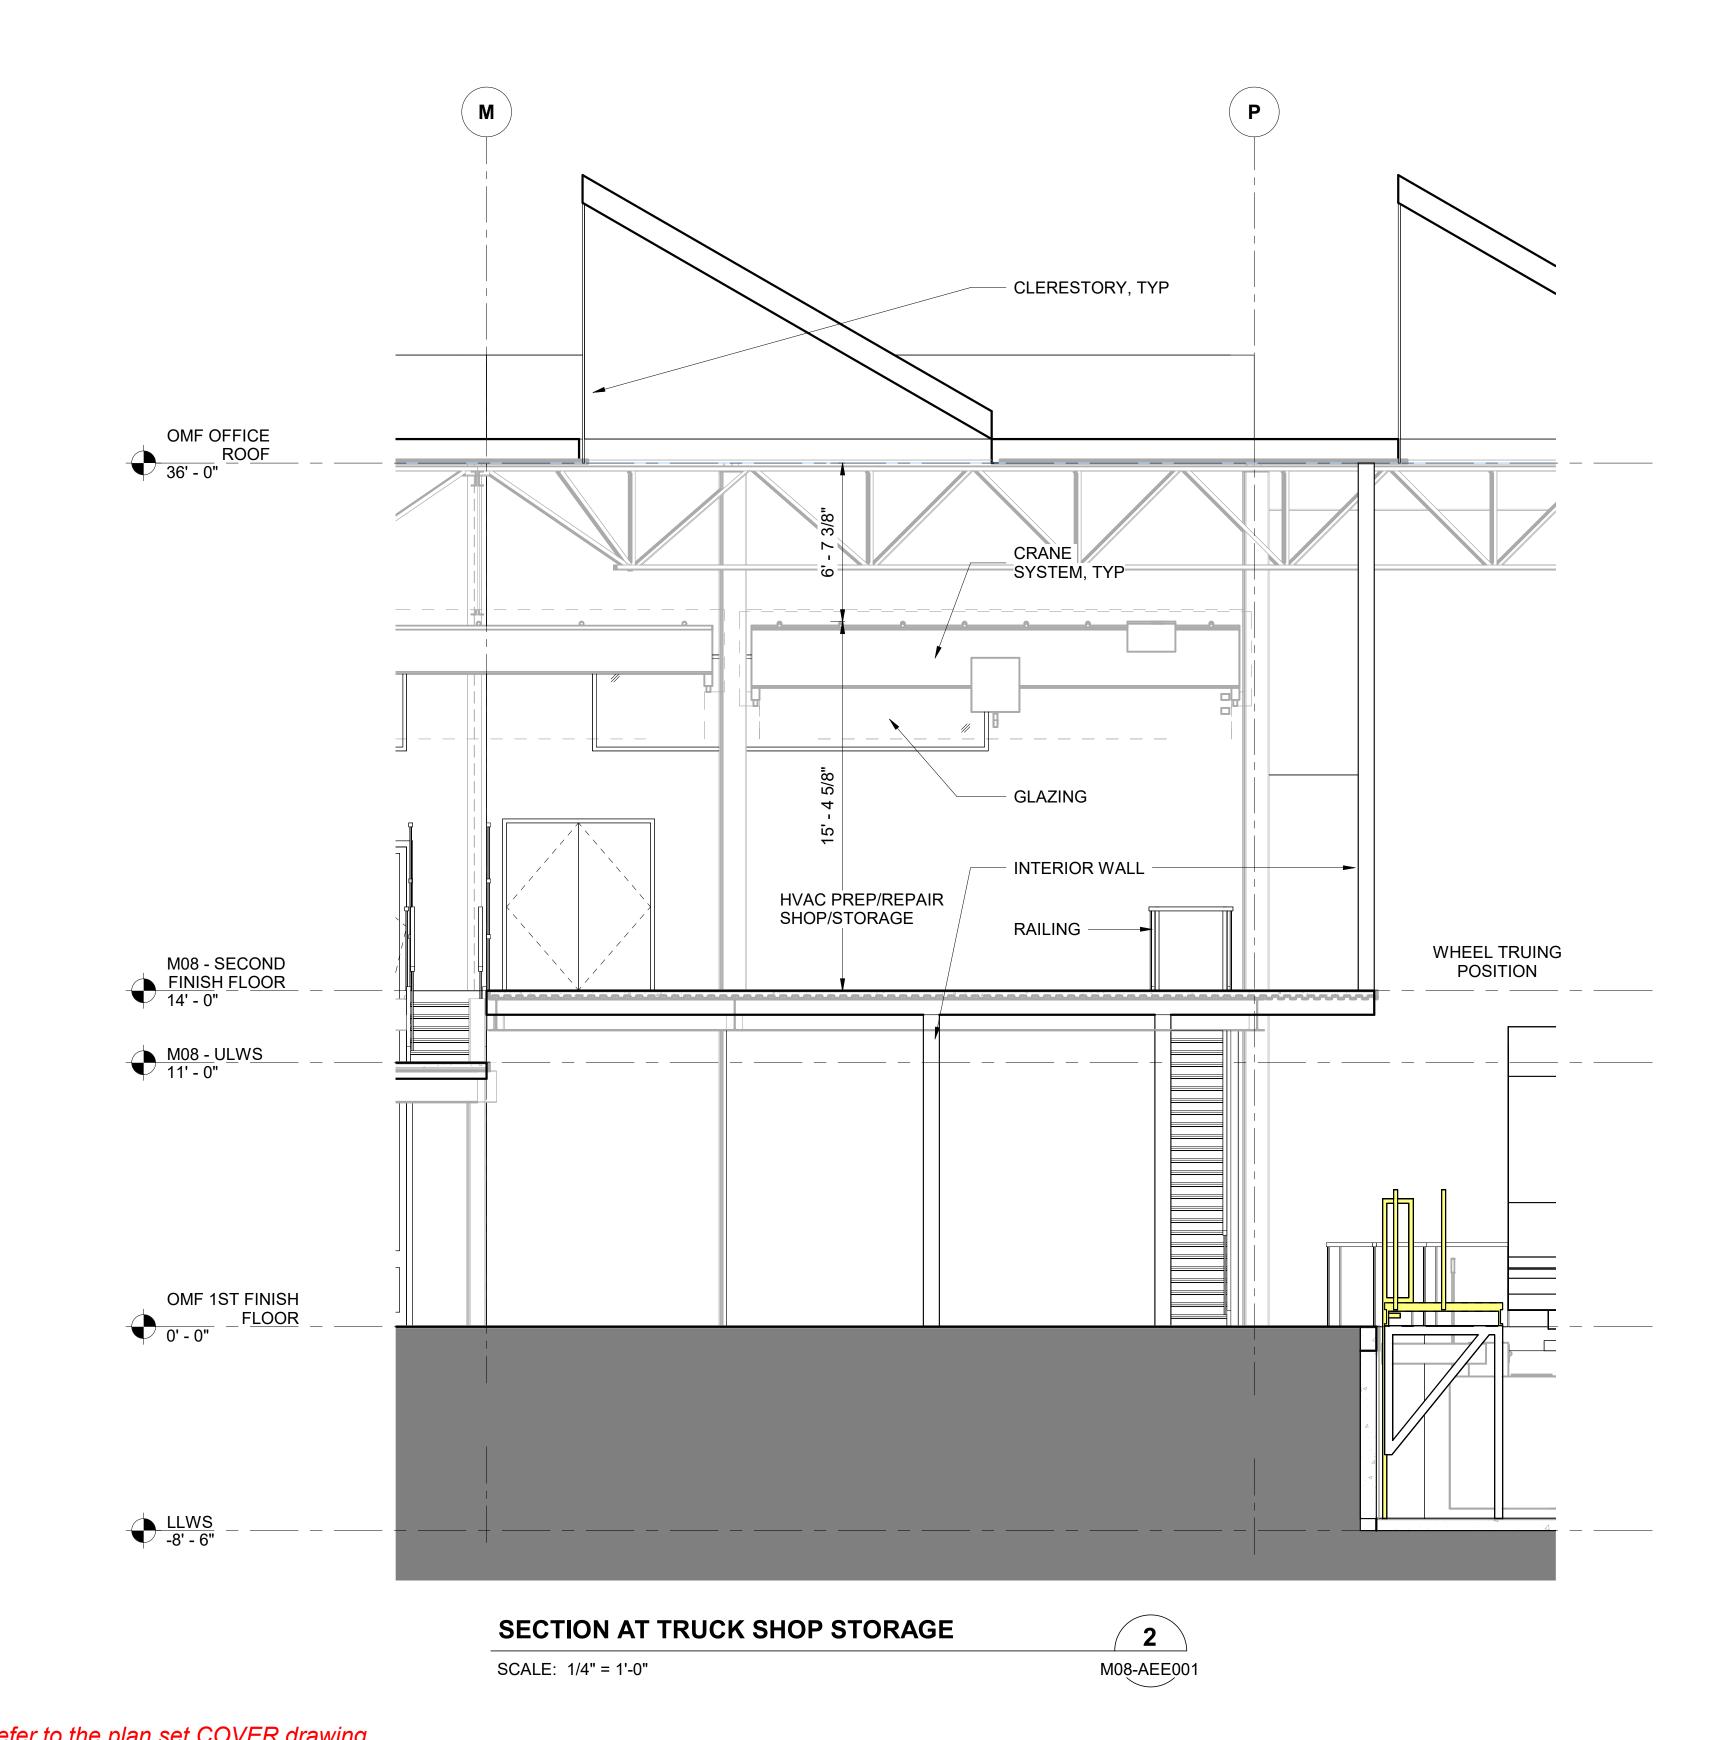9849 REGISTERED ARCHITECT CHAN LAM CHEANG STATE OF WASHINGTON

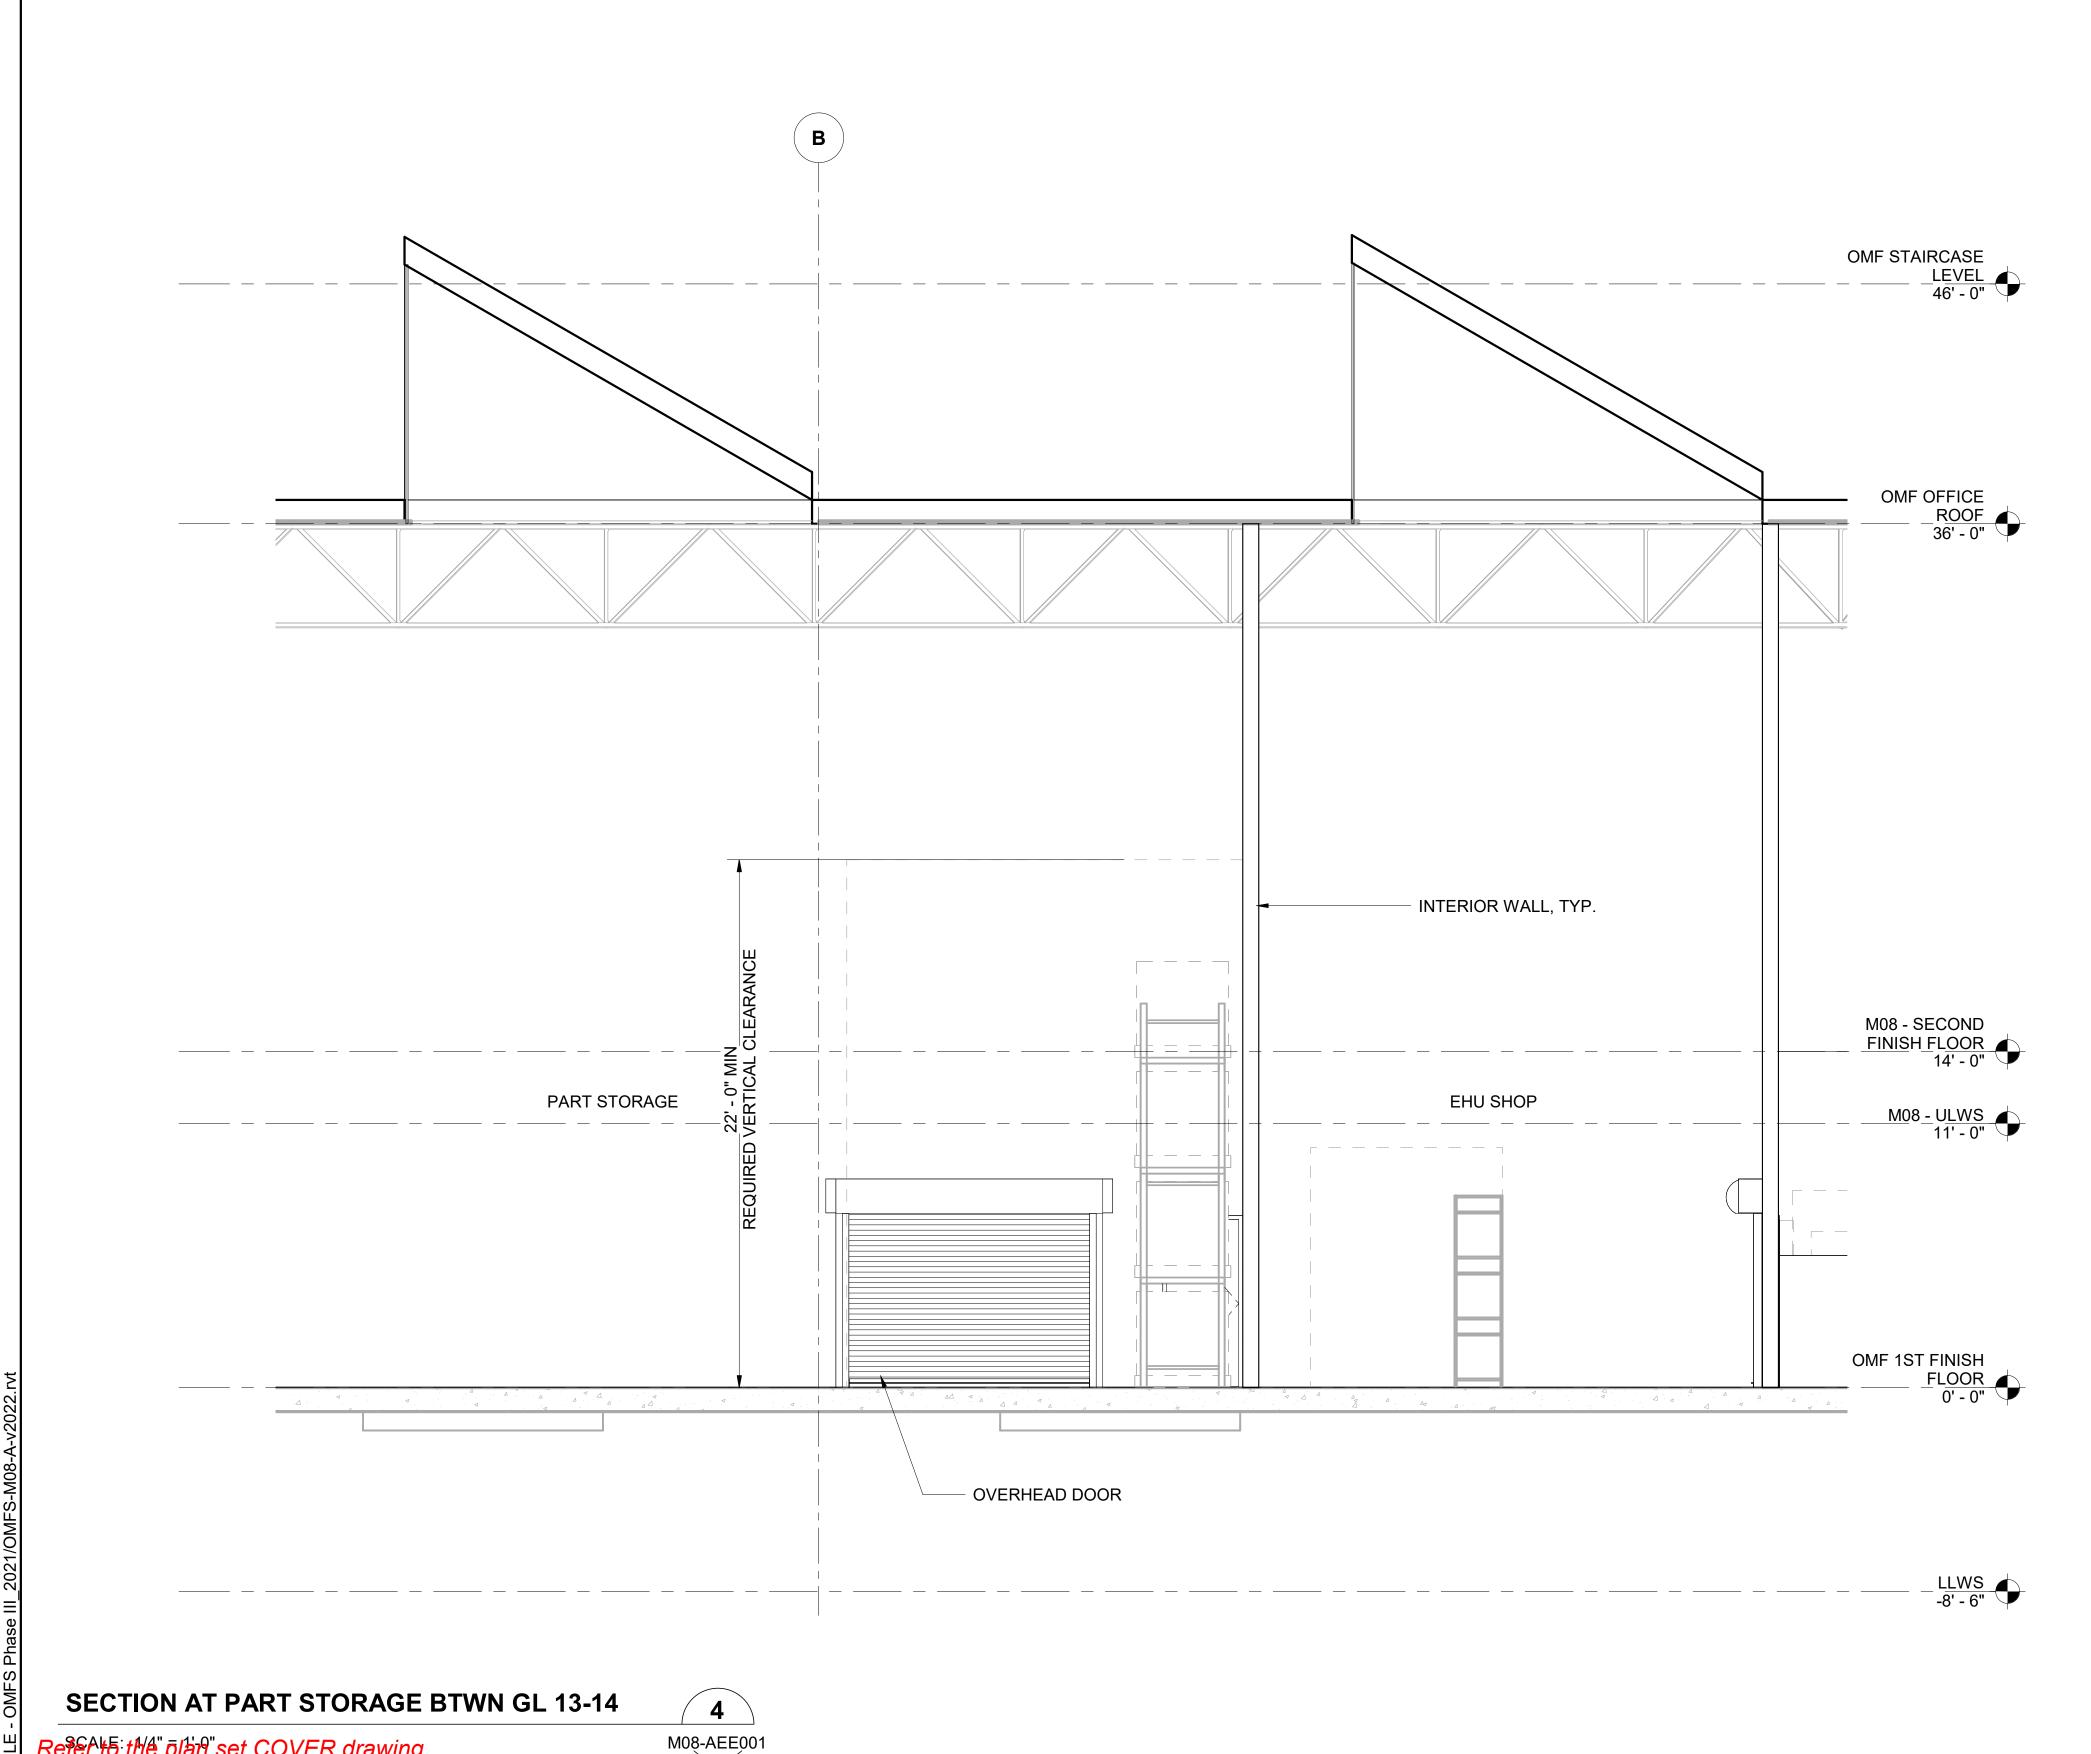PACKAGE # SOUNDTRANSIT CONTRACT No.:

AS NOTED FILENAME: OMFS-M08-A-V2022.RV AE-0030-17

SOUND TRANSIT OPERATIONS & MAINTENANCE FACILITY SOUTH PRELIMINARY ENGINEERING

ARCHITECTURAL SECTIONS

DRAWING No.: M08-ASX005 FACILITY ID:

M08 SHEET No:

REFERENCE CONCEPT DRAWINGS CHAN CHEANG DRAWN BY:

APPROVED BY: SHEENA ZIMMERMAN


PABLO LOPEZ-HILFIKER

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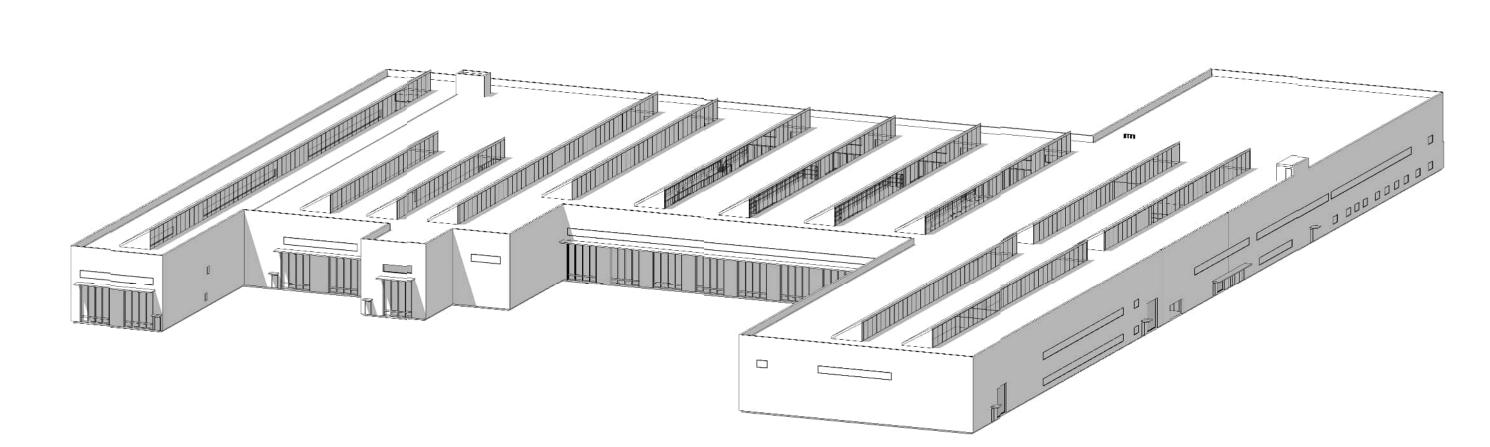
SUBMITTAL DATE:

OMF SECTIONS



OMF MASSING - LOOKING NE FROM SW CORNER

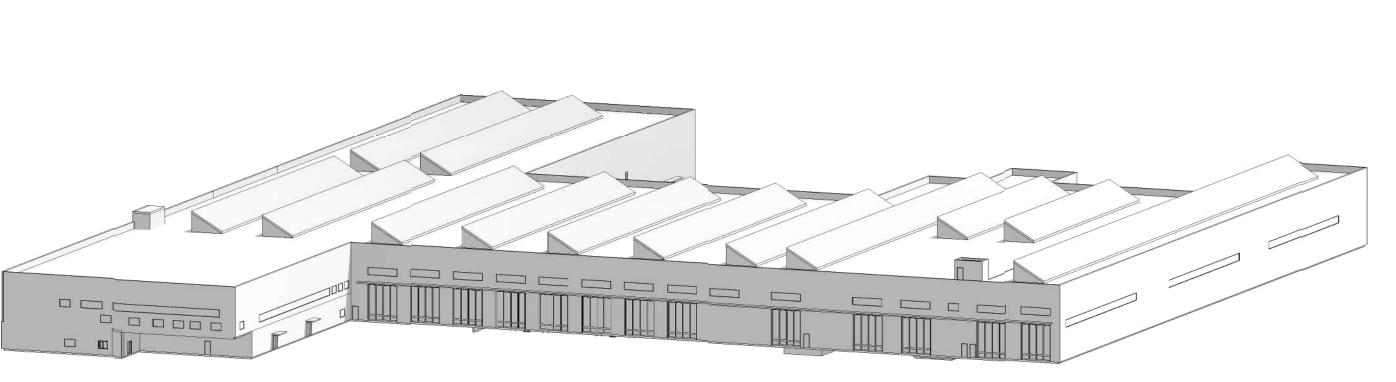OMF MASSING - LOOKING SE FROM NW CORNER



AHJ:

OMF MASSING - LOOKING SW FROM BE CORNER

OMF MASSING - LOOKING NW FROM SE CORNER

REVIEWED BY:

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DSN CHK APP REVISION

DESIGNED BY: REFERENCE CONCEPT DRAWINGS CHAN CHEANG DRAWN BY:

9849 REGISTERED ARCHITECT STEPHANIE GREEN CHAN LAM CHEANG STATE OF WASHINGTON DONN HOGAN APPROVED BY: SHEENA ZIMMERMAN

PABLO LOPEZ-HILFIKER

2/27/2024

PACKAGE #

5_ SOUNDTRANSIT CONTRACT No.:

AE-0030-17

SUBMITTAL DATE:

02/27/2024

OMFS-M08-A-V2022.RV

SOUND TRANSIT OPERATIONS & MAINTENANCE FACILITY SOUTH PRELIMINARY ENGINEERING

> ARCHITECTURAL MASSING VIEWS OMF MASSING VIEWS


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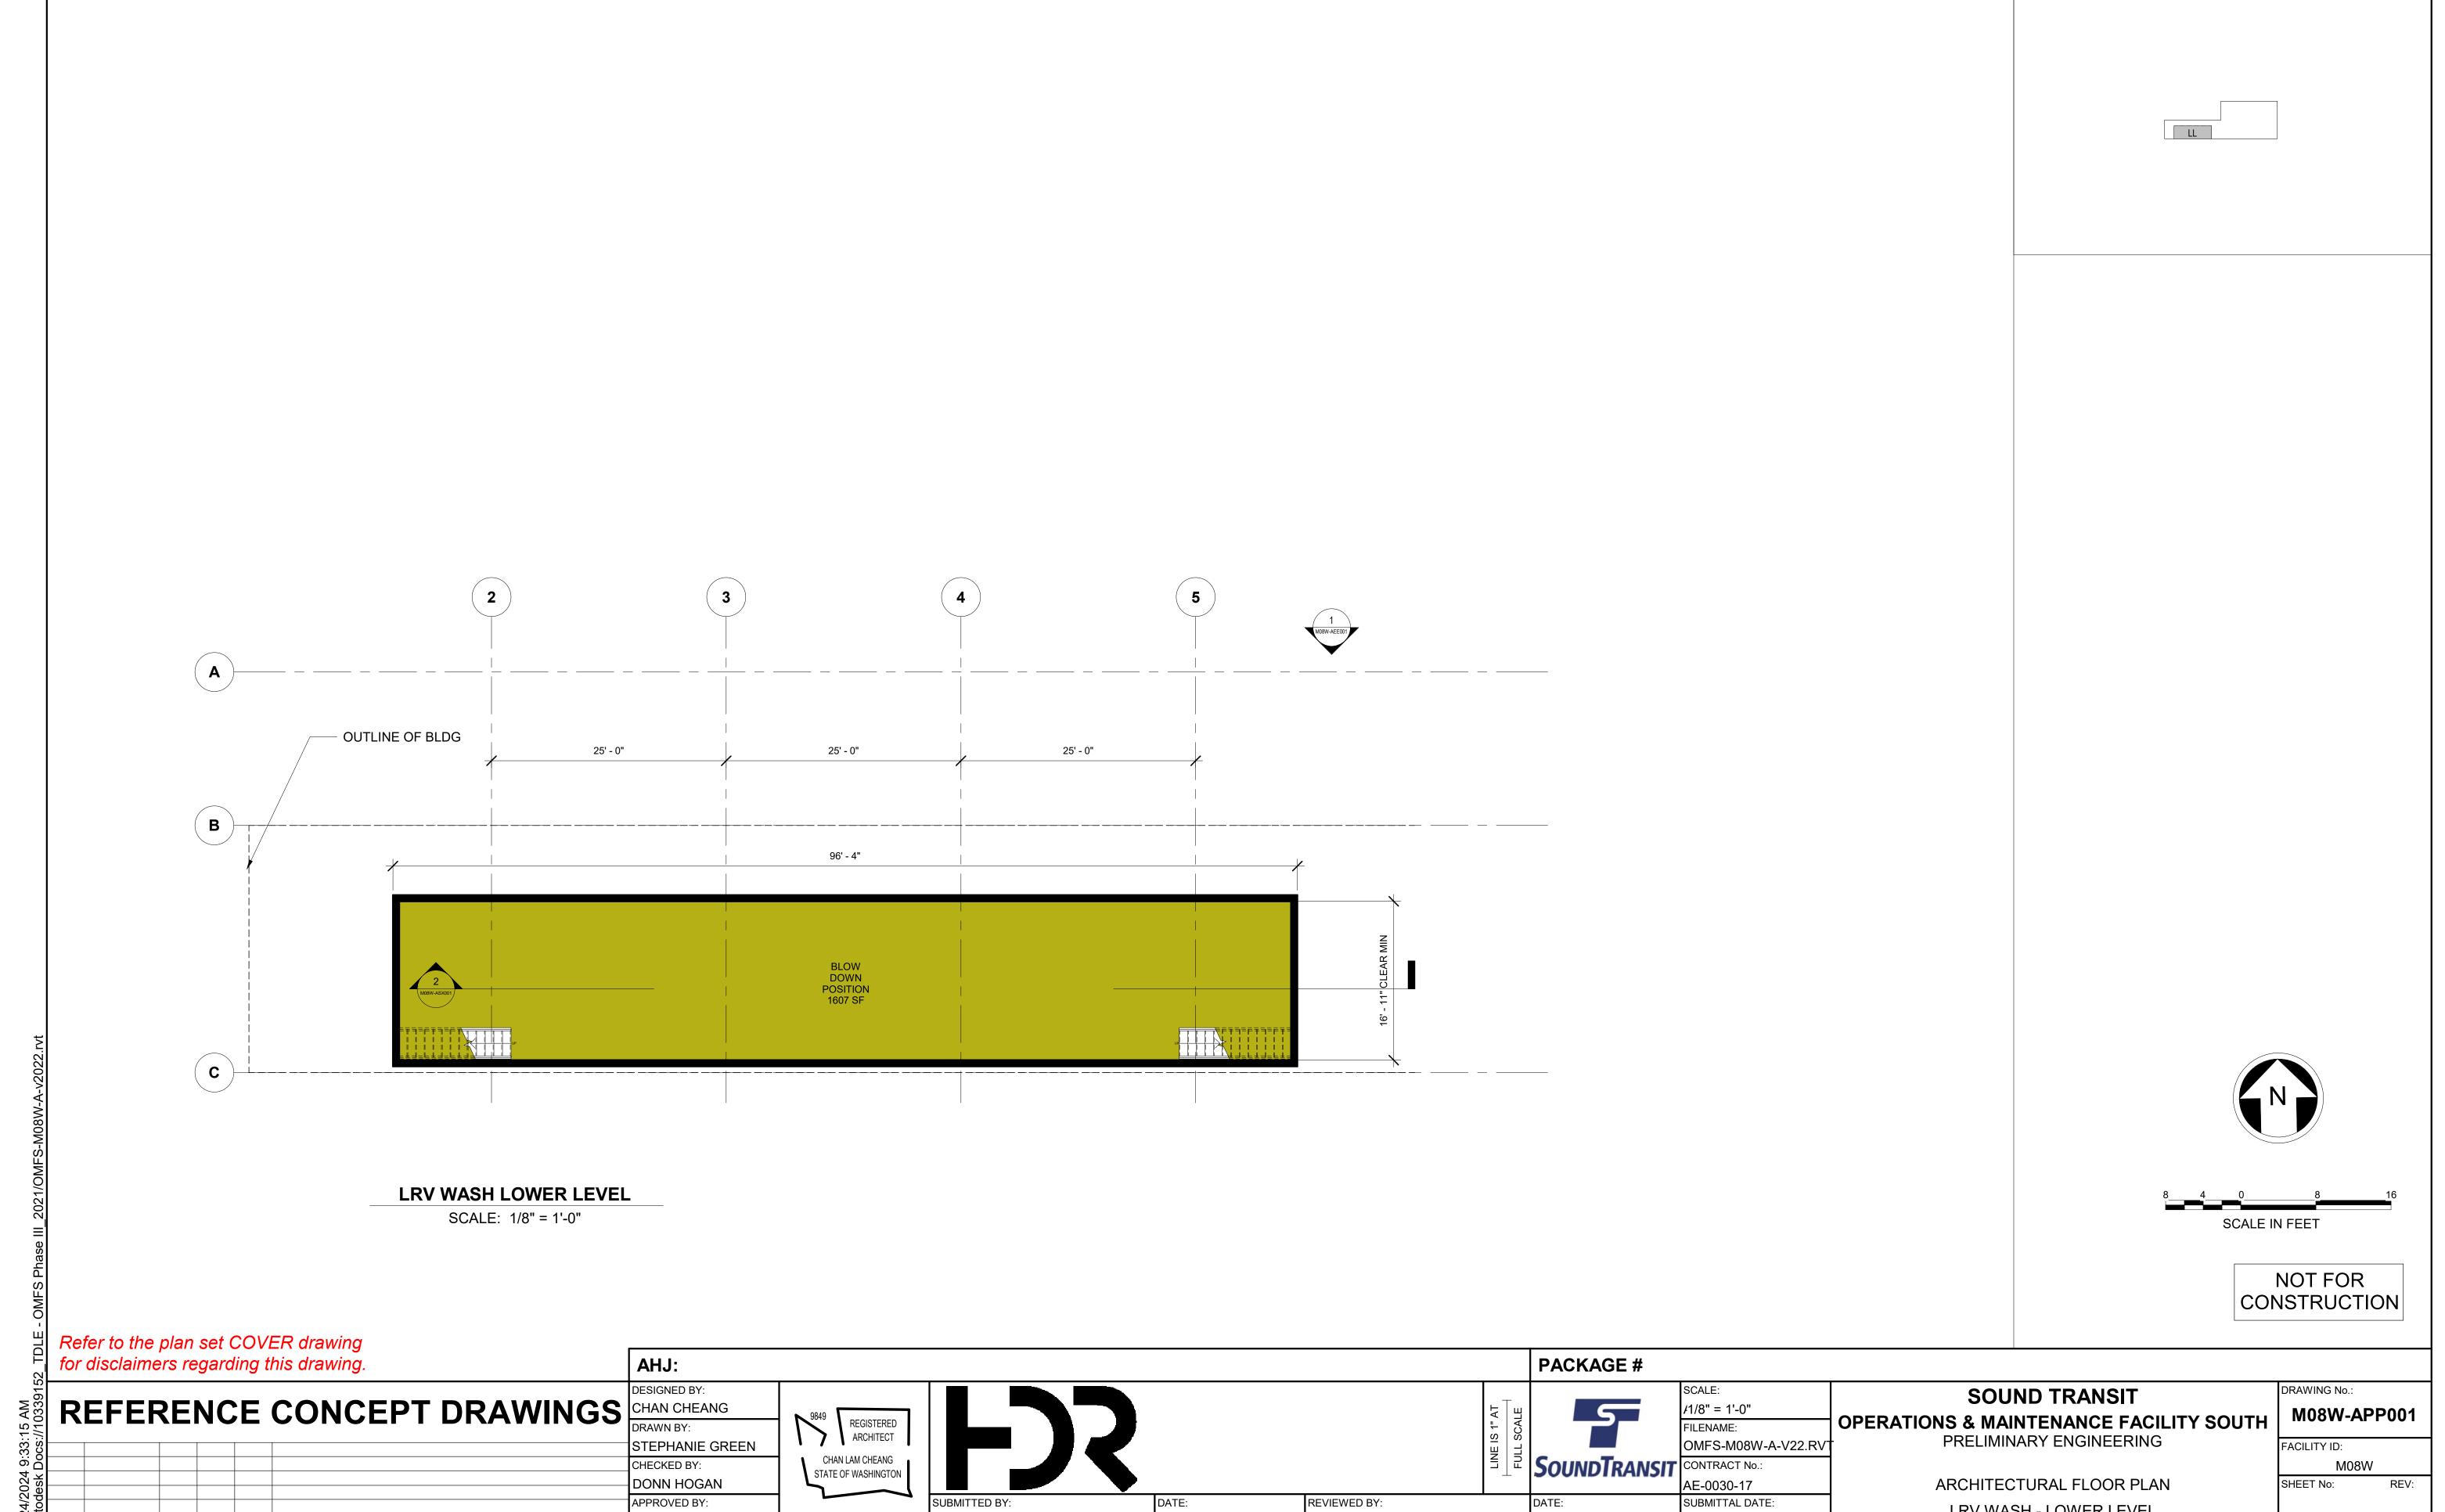
M08 SHEET No:

FACILITY ID:

NOT FOR

CONSTRUCTION



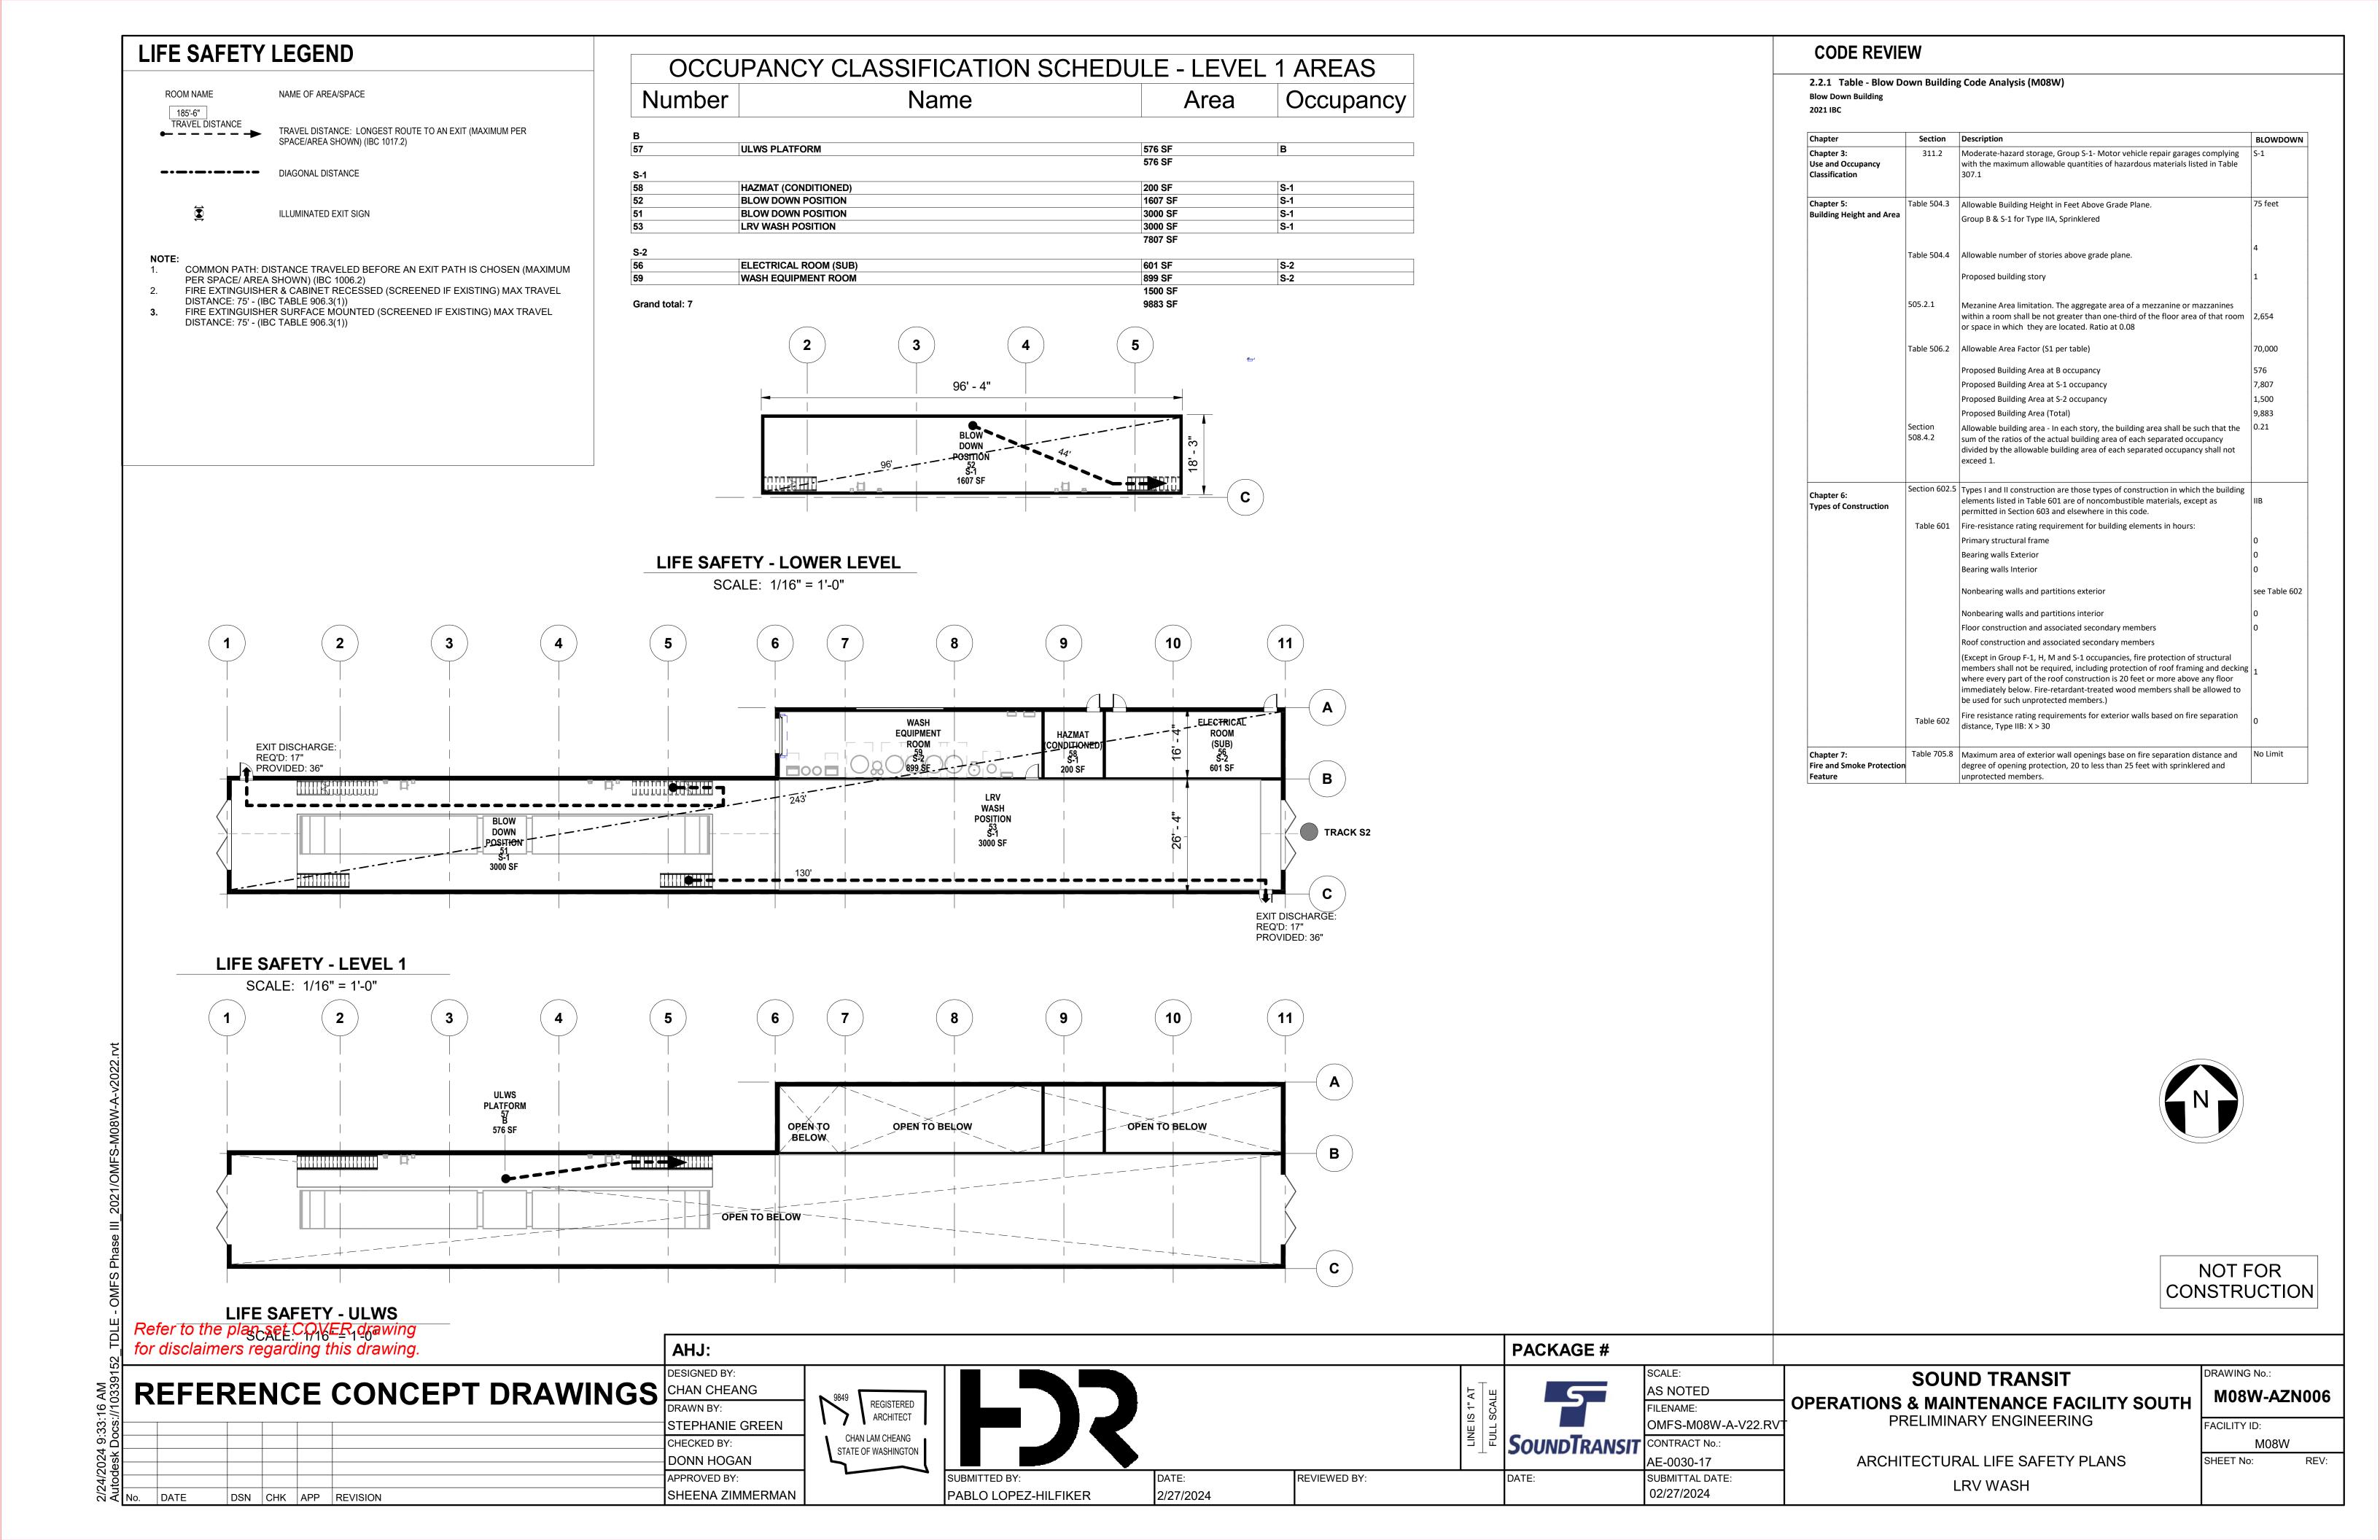

2/27/2024

PABLO LOPEZ-HILFIKER


SHEENA ZIMMERMAN


KEY PLAN - M08W

LRV WASH - LOWER LEVEL

02/27/2024

DSN CHK APP REVISION

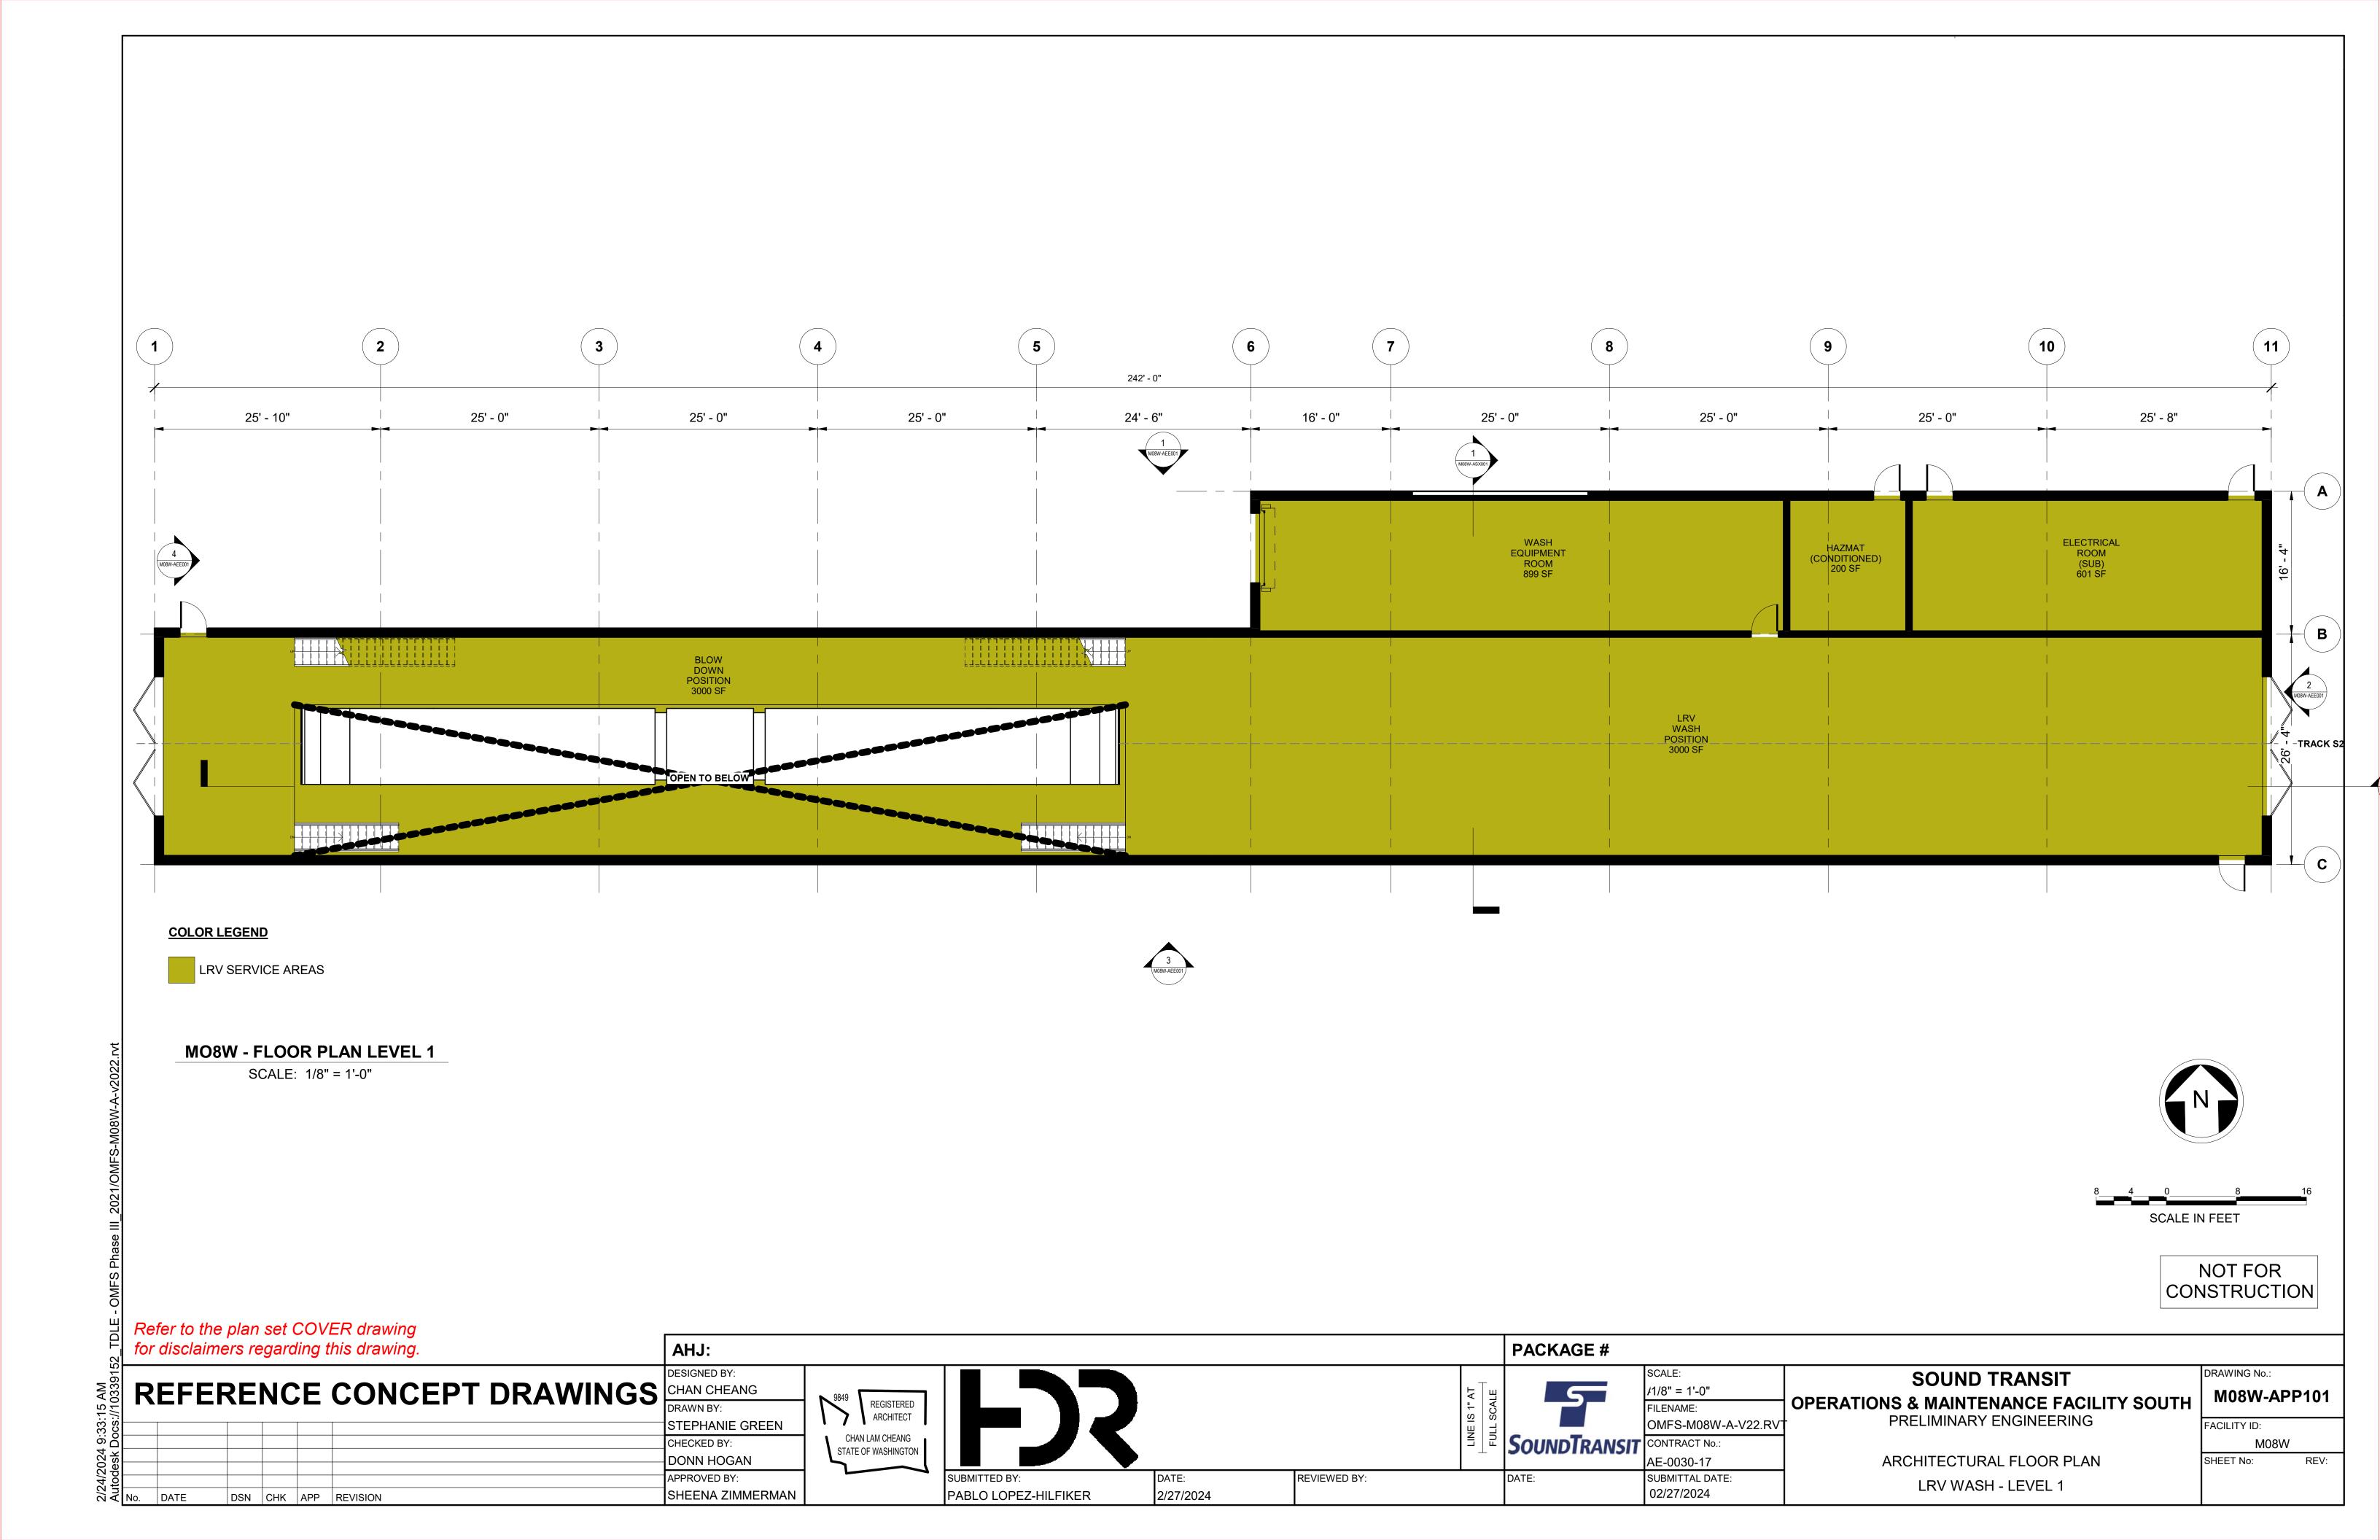

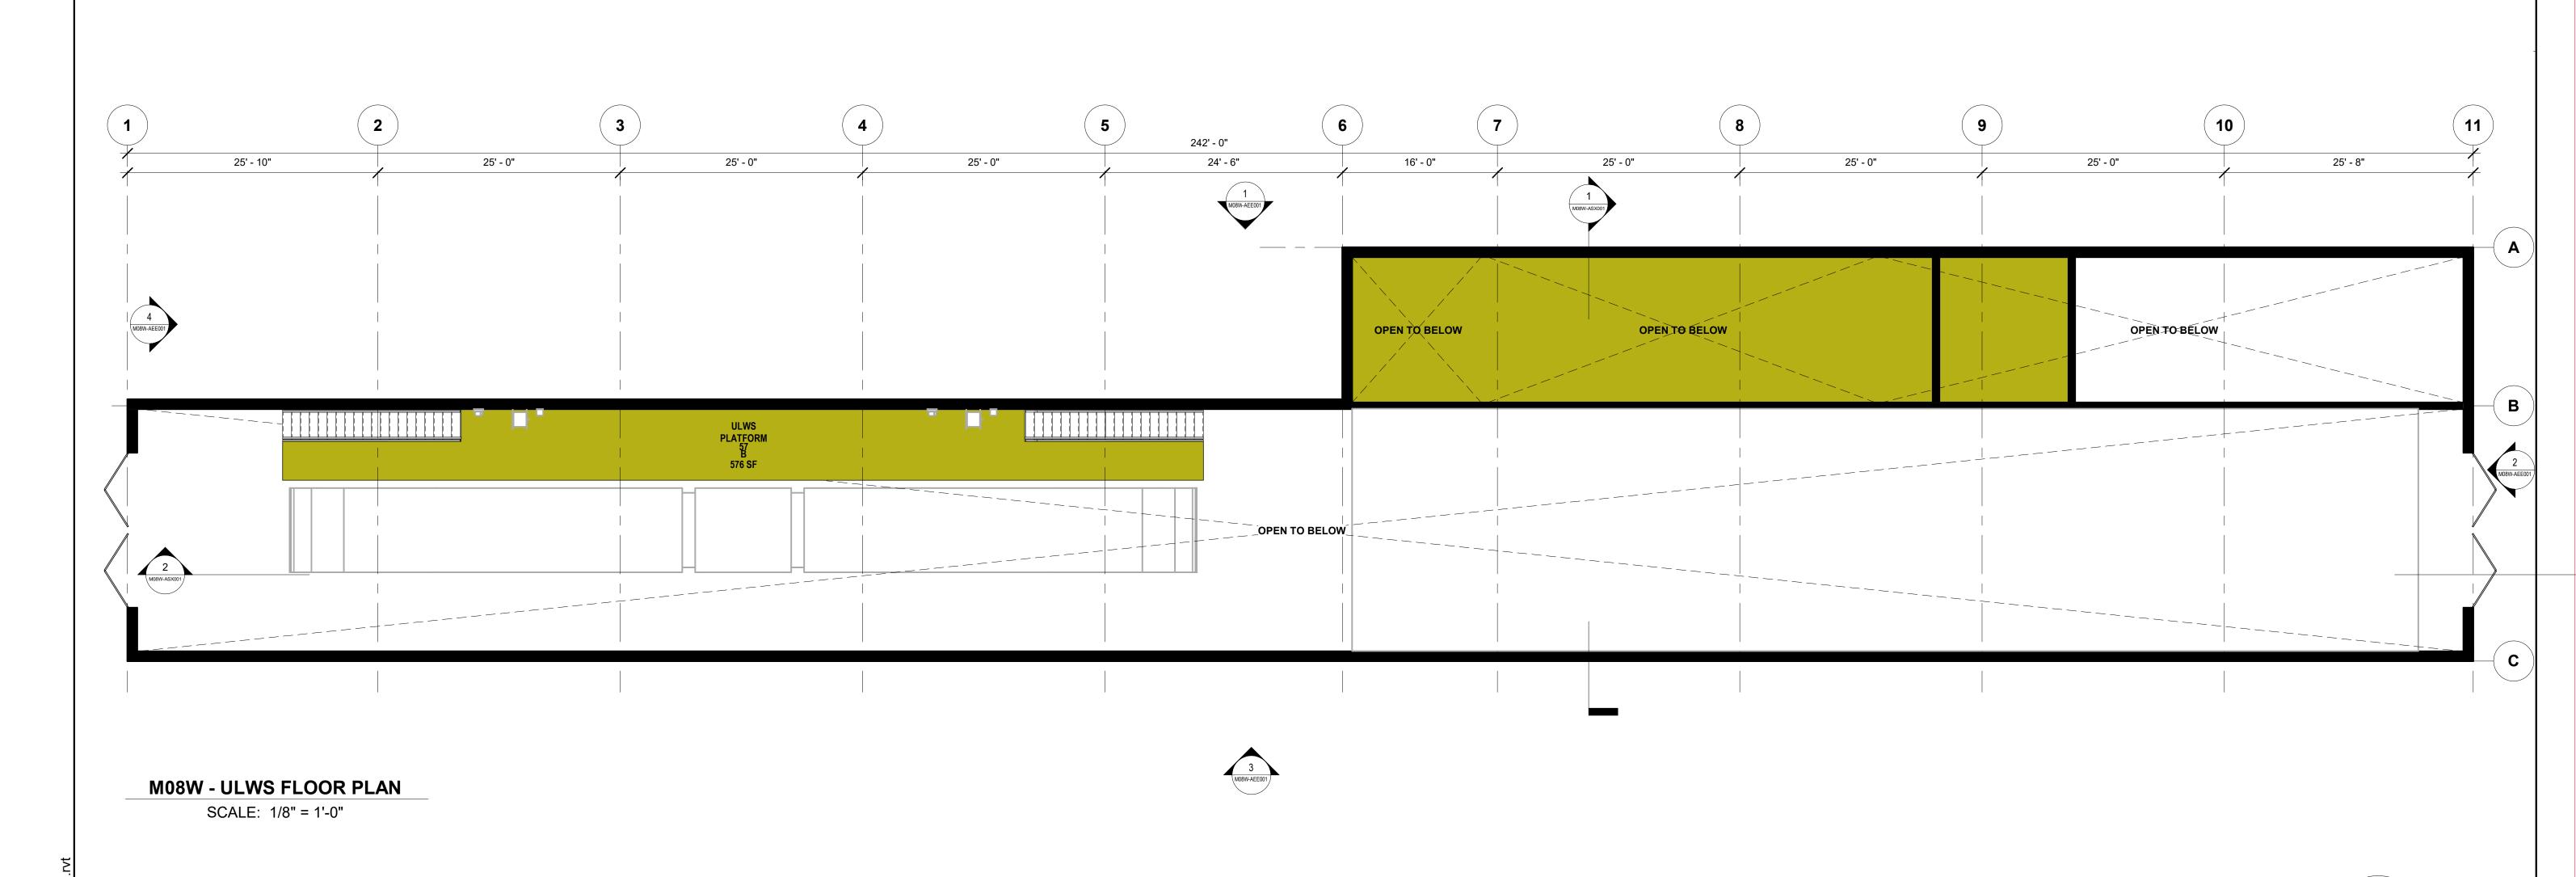

SCALE IN FEET

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DRAWING No.:

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REFERENCE CONCEPT DRAWINGS CHAN CHEANG DRAWN BY:

DESIGNED BY: STEPHANIE GREEN CHECKED BY: DONN HOGAN APPROVED BY: SHEENA ZIMMERMAN DSN CHK APP REVISION

9849 REGISTERED ARCHITECT CHAN LAM CHEANG STATE OF WASHINGTON PABLO LOPEZ-HILFIKER

AHJ:

2/27/2024

REVIEWED BY:

PACKAGE # SOUNDTRANSIT CONTRACT No.:

/1/8" = 1'-0" FILENAME: OMFS-M08W-A-V22.RV AE-0030-17 SUBMITTAL DATE:


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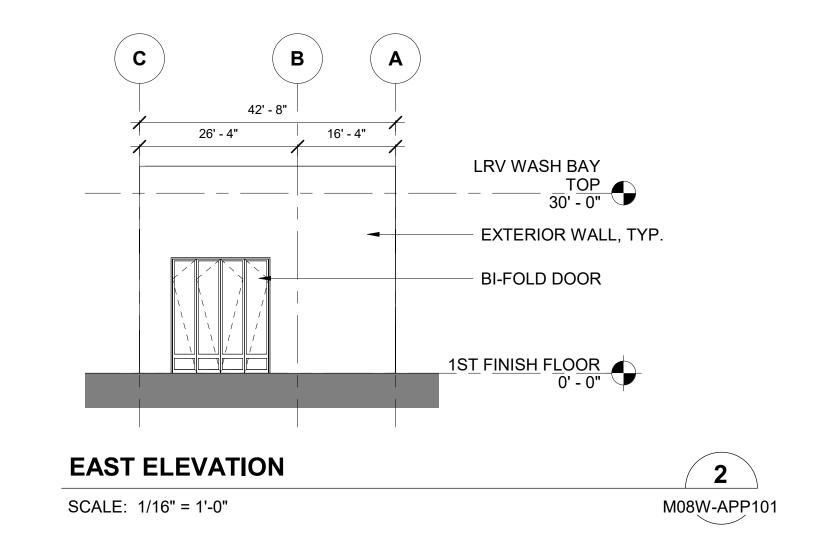
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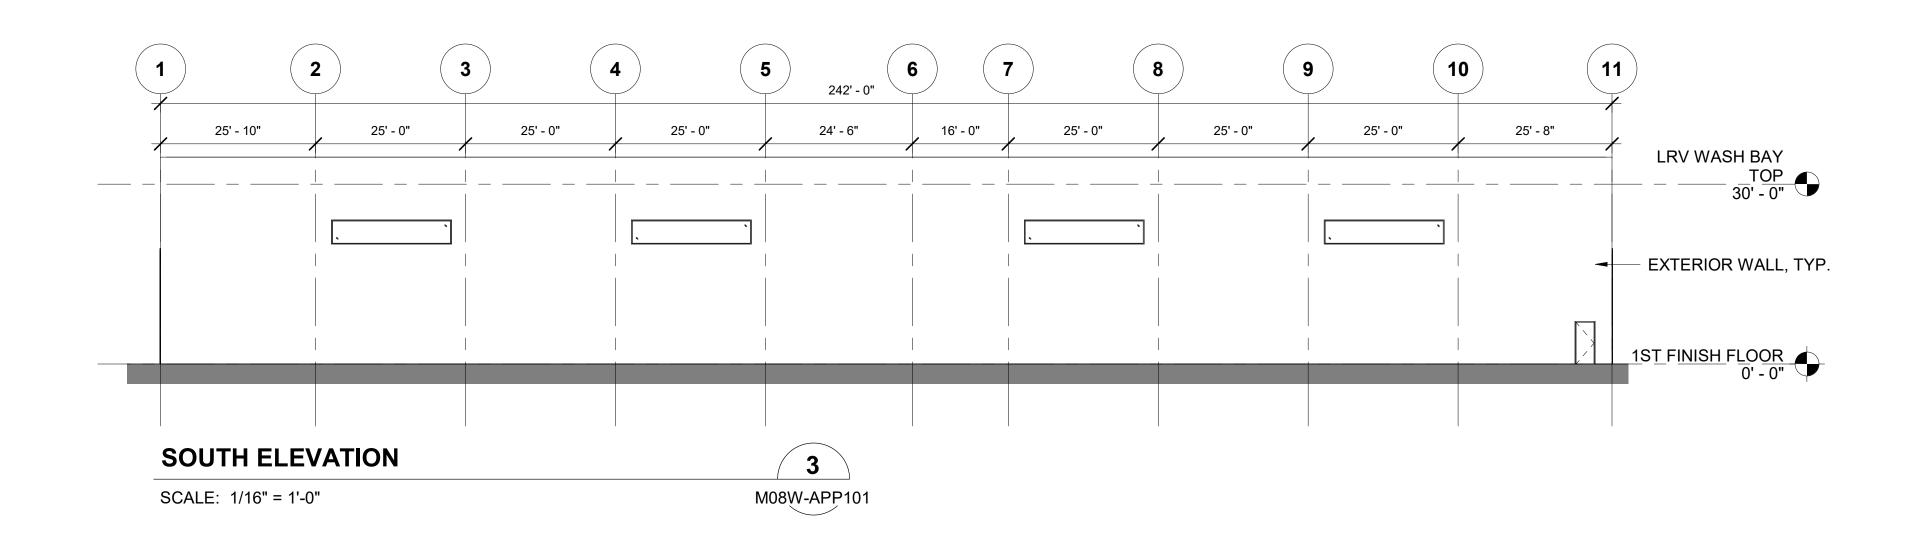
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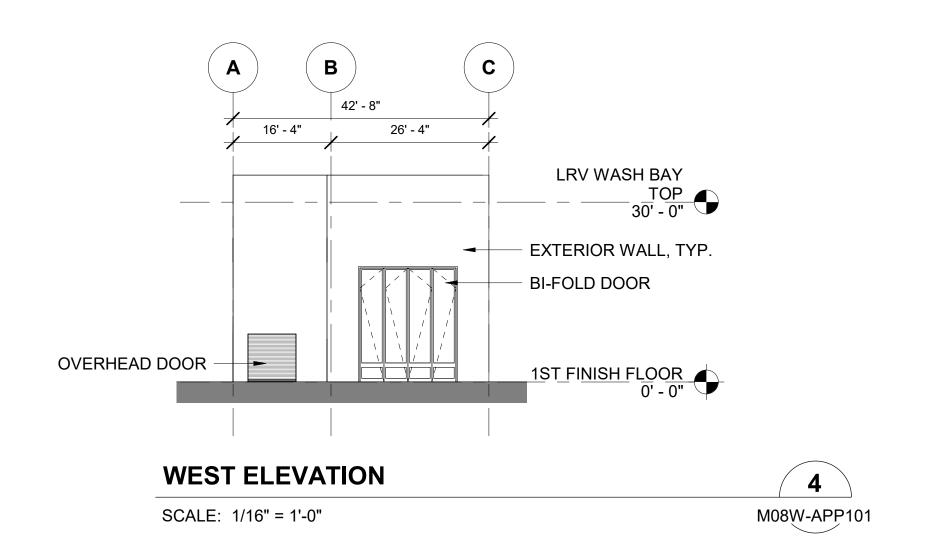
M08W-APP201 FACILITY ID:

W80M SHEET No:







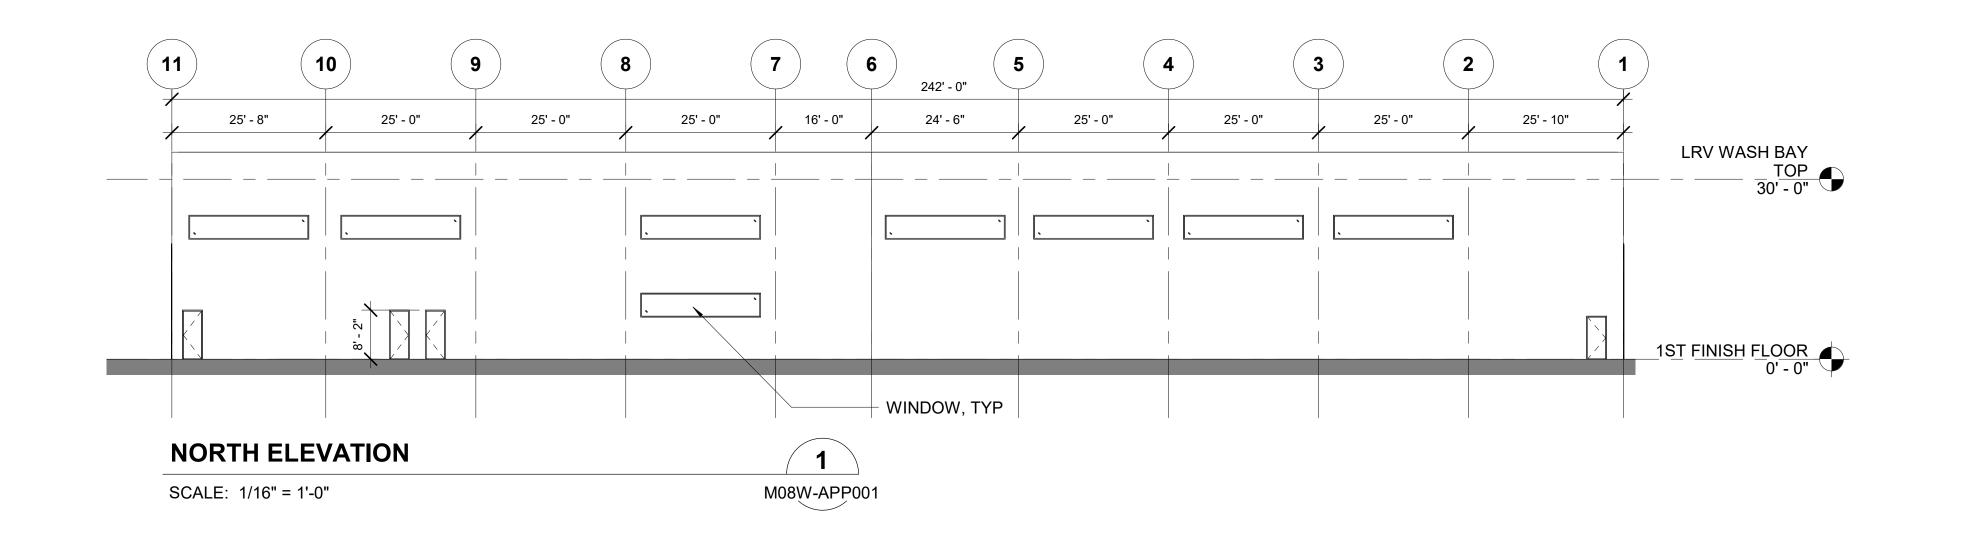

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DSN CHK APP REVISION

REFERENCE CONCEPT DRAWINGS CHAN CHEANG DRAWN BY: CHECKED BY:

DESIGNED BY: 9849 REGISTERED ARCHITECT STEPHANIE GREEN CHAN LAM CHEANG STATE OF WASHINGTON DONN HOGAN APPROVED BY: SHEENA ZIMMERMAN

AHJ:

2/27/2024 PABLO LOPEZ-HILFIKER

DATE:

REVIEWED BY:

PACKAGE # 5 SOUNDTRANSIT CONTRACT No.:

FILENAME: OMFS-M08W-A-V22.RV AE-0030-17

SUBMITTAL DATE:


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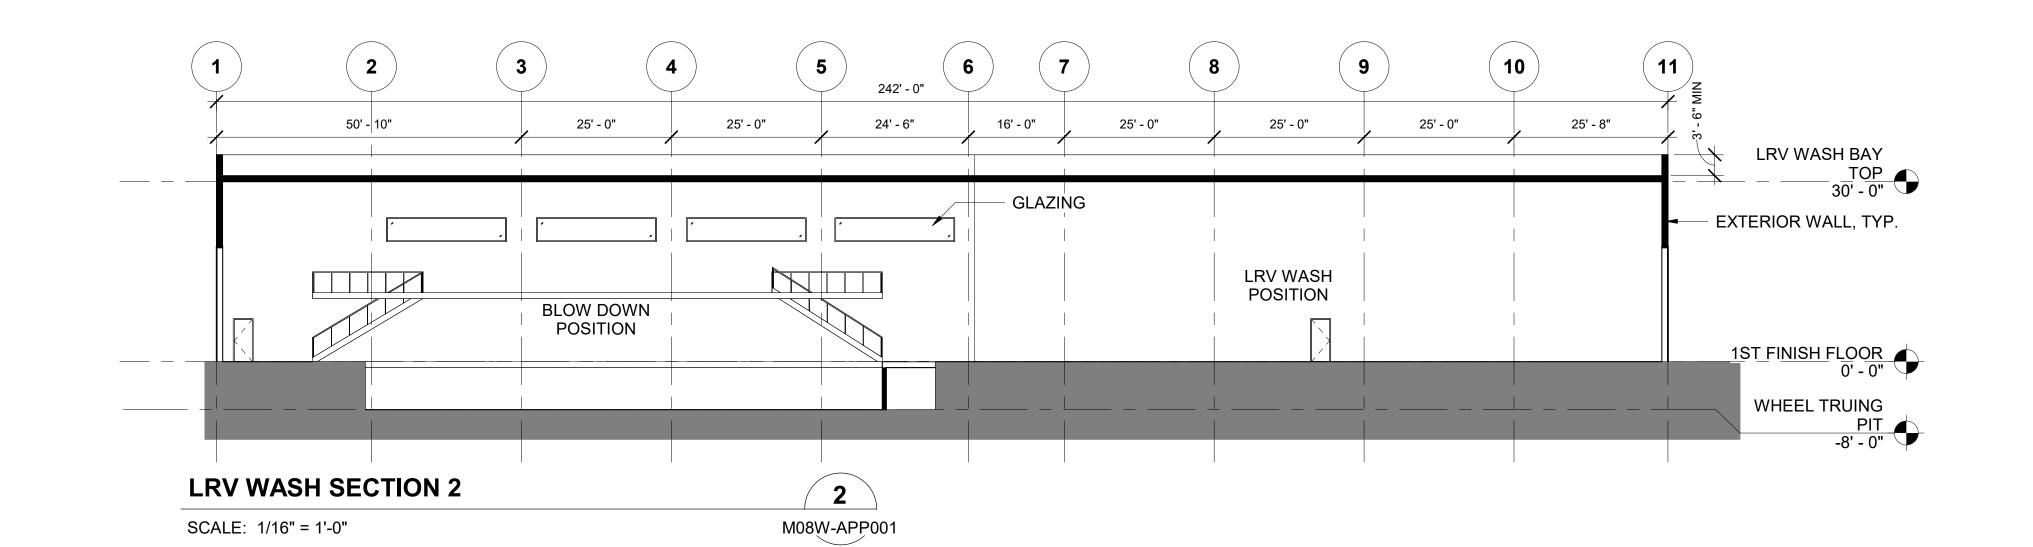
SOUND TRANSIT OPERATIONS & MAINTENANCE FACILITY SOUTH PRELIMINARY ENGINEERING

DRAWING No.: M08W-AEE001 FACILITY ID:

W80M SHEET No:

ARCHITECTURAL ELEVATIONS LRV WASH ELEVATIONS



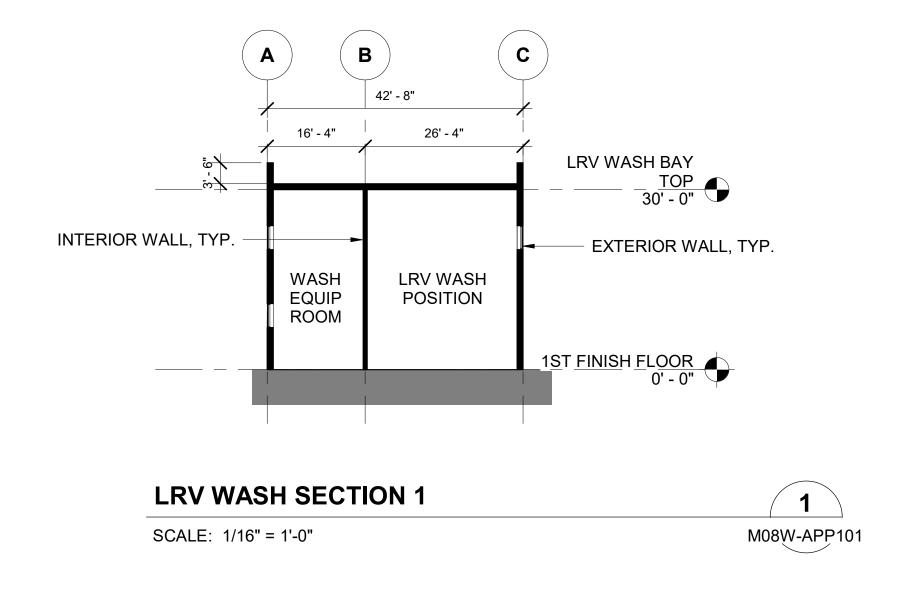

DRAWING No.:

Refer to the plan set COVER drawing for disclaimers regarding this drawing.

DESIGNED BY: REFERENCE CONCEPT DRAWINGS CHAN CHEANG DRAWN BY:

9849 REGISTERED ARCHITECT CHAN LAM CHEANG STATE OF WASHINGTON

AHJ:


PACKAGE # 5_

FILENAME:


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M08W-ASX001 FACILITY ID:


OPERATIONS & MAINTENANCE FACILITY SOUTH OMFS-M08W-A-V22.RV STEPHANIE GREEN SOUNDTRANSIT CONTRACT No.: CHECKED BY: W80M DONN HOGAN AE-0030-17 ARCHITECTURAL SECTIONS SHEET No: APPROVED BY: SUBMITTAL DATE: REVIEWED BY: LRV WASH - SECTIONS 2/27/2024 02/27/2024 PABLO LOPEZ-HILFIKER SHEENA ZIMMERMAN DSN CHK APP REVISION

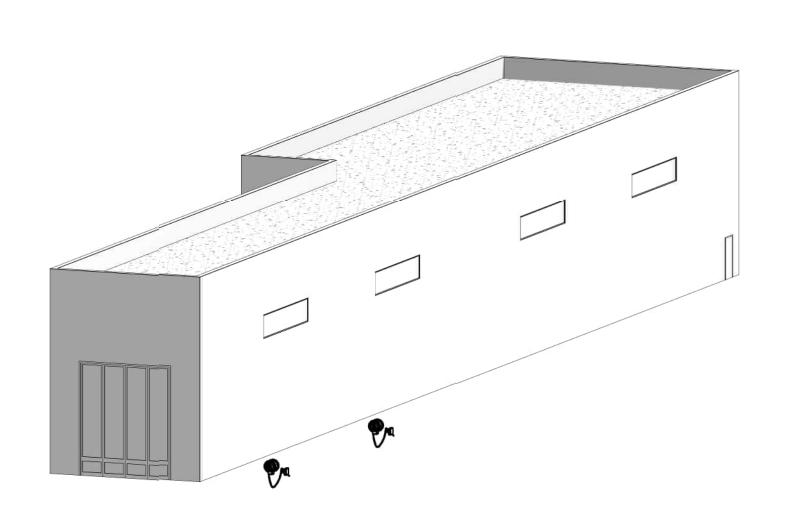


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3 LRV WASH MASSING - LOOKING SW FROM NE CORNER

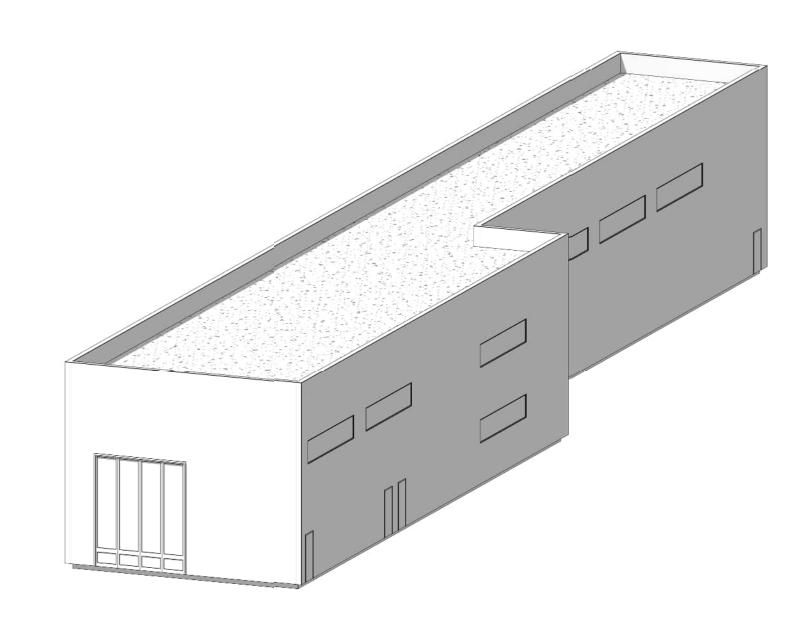

(2) LRV WASH MASSING -

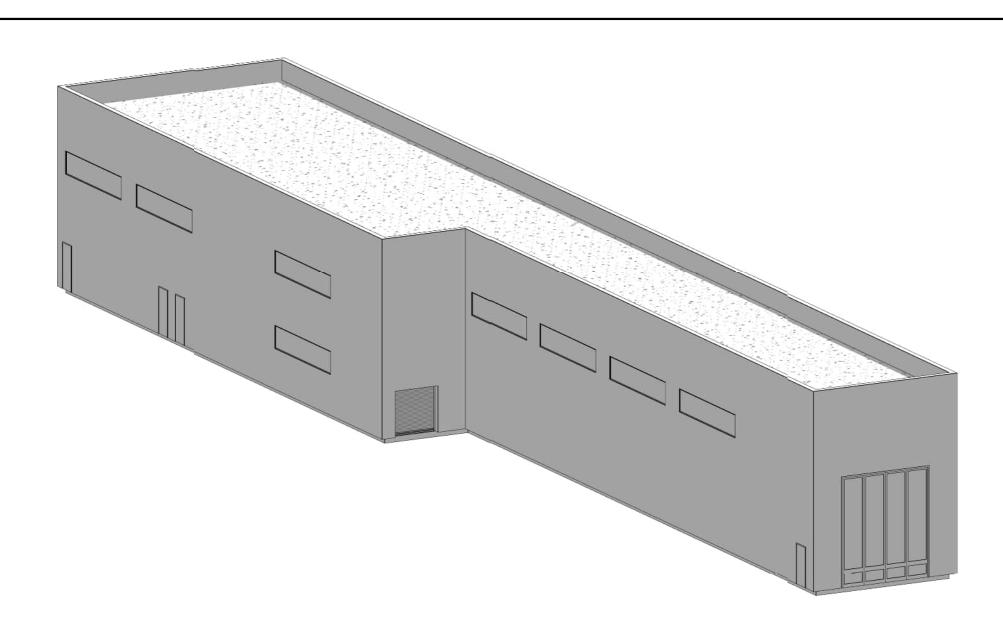

4 LRV WASH MASSING - LOOKING NW FROM SE CORNER

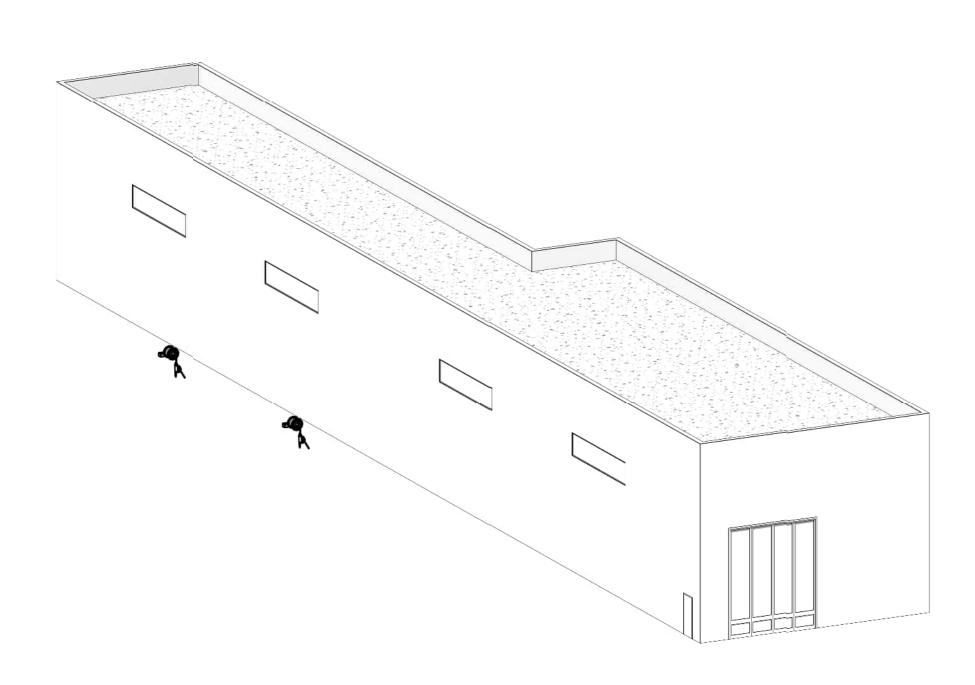NOT FOR CONSTRUCTION

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REFERENCE CONCEPT DRAWINGS CHAN CHEANG DRAWN BY:

STEPHANIE GREEN DONN HOGAN APPROVED BY: SHEENA ZIMMERMAN DSN CHK APP REVISION

9849 REGISTERED ARCHITECT CHAN LAM CHEANG STATE OF WASHINGTON

AHJ:

PABLO LOPEZ-HILFIKER

2/27/2024

REVIEWED BY:

PACKAGE # 5 SOUNDTRANSIT CONTRACT No.:

FILENAME: OMFS-M08W-A-V22.RV AE-0030-17 SUBMITTAL DATE:

02/27/2024

SOUND TRANSIT OPERATIONS & MAINTENANCE FACILITY SOUTH PRELIMINARY ENGINEERING

> ARCHITECTURAL MASSING VIEWS LRV WASH MASSING VIEWS

DRAWING No.: M08W-AMP001

FACILITY ID: W80M SHEET No:

OCCUPANCY CLASSIFICATION SCHEDULE - LEVEL 1 AREAS Name Occupancy Area FACILITIES TRADES SHOP - OVERHEAD 2203 SF 2203 SF RAIL TRACTION POWER LINE CREW CHIEF RAIL FACILITIES CHIEF FACILITY SPECIALIST FACILITIES AREA MANAGER **FACILITIES AREA MANAGER FACILITIES AREA MANAGER** 150 SF 120 SF 120 SF 144 SF 146 SF 122 SF 557 SF 129 SF 172 SF 158 SF 218 SF 2217 SF 253 SF 596 SF 121 SF 121 SF 158 SF 121 SF 159 SF 121 SF 159 SF 1453 SF 150 SF HOTELING OFFICE TRANSIT SUPERINTENDENT - RAIL FACILITIES MAINTENANCE
RAIL TRACK/ ROW CHIEF
RAIL FACILITIES CHIEF (POWER) RAIL FACILITIES SUPERINTENDENT MOW TECHNICAL TRAINER FACILITIES TRAINING ROOM WOMEN'S RR MEN'S RR KITCHENETTE MEDIA ROOM (COPY/FILE/PRINT) FILE STORAGE ROOM CONFERENCE ROOM BREAK/ LUNCH/ CREW ROOM KITCHEN/ VENDING AREA WOMEN'S RR'S/SHOWERS MEN'S RR'S/SHOWERS FACILITIES COORDINATOR MEN'S LOCKERS
(2) HOTELING WKSTATIONS FACILITIES MAINTENANCE SUPERVISOR FACILITIES MANAGER RAIN GEAR STORAGE RAIN GEAR STORAGE RAIN GEAR STORAGE SINK STATION COMPRESSOR/LUBE ROOM WOMEN'S LOCKERS FLEX LOCKERS TRAINING STORAGE
RAIL TRACK & SIGNAL SUPERINTENDENT RAIL TRACTION POWER CHIEF
GENDER NEUTRAL RESTROOM MAINTENANCE SCHEDULER/ PLANNER
RAIL ELECTRICAL WORKER- APPRENTICE TASS- III WAY, POWER & SIGNALS RAIL SIGNALS & COMM CHIEF TASS-III FACILITIES CHAIR/ TABLE STOR. TRAINING SUPERINTENDENT
FACILITIES TECHNICAL TRAINER CHAIR/TABLE STOR.
MOW TRAINING ROOM 11161 SF S-1 HIGH BAY SERVICE AREA IT/DATA ROOM BATTERY TEST 5002 SF 258 SF 211 SF 113 SF 2187 SF 2187 SF 2189 SF 2187 SF 1219 SF 6065 SF 2187 SF 1093 SF 1093 SF 984 SF 422 SF CUSTODIAL
CUSTODIAL AND GARDENER SHOP SIGNALS SHOP POWER SHOP TRACK SHOP
PAINT SHOP/ STORAGE STOCK ROOM FACILITIES SHOP NRV SHOP/ STORAGE COMMON WORK AREA FACILITIES TRADES SHOP 2203 SF 1093 SF 1093 SF 31786 SF S-2
SPRINKLER VALVE ROOM
ELECTRICAL ROOM MECHANICAL ROOM

CODE REVIEW

2.2.1 Table - MOW Building Code Analysis (M09)

2021 IBC

Chapter	Section	Description	MOW (site B)
Chapter 3: Use and Occupancy	304.1	Business Group B - Offices, Training Rooms, Conference Rooms, Locker rooms, Administrative spaces, Exercise rooms, Media rooms.	В
Classification	311.2	Moderate-hazard storage, Group S-1- Motor vehicle repair garages complying with the maximum allowable quantities of hazardous materials listed in Table 307.1	S-1
	311.3	Low-hazard storage, Group S-2 Buildings used for the storage of noncombustible materials such as products on wood pallets or in paper cartons with or without single thickness divisions; or in paper wrappings.	S-2
Chapter 5: Building Height and Area	Table 504.3	Allowable Building Height in Feet Above Grade Plane. Group A-2, B, S-1 & S-2 for Type IB, Sprinklered	85 feet
	Table 504.4	Allowable number of stories above grade plane for Type IB.	6 (B) 5 (S-1)
		Proposed building story	1
	Table 506.2	Allowable Area Factor (S1 per table)	150,000 (B)
	Section 506.2.4	Multiple-occupancy, multistory buildings, with nonseparated occupancy	104,000 (S-1 Aa=
		approach.	178,125 (B)
		Aa=[At + (NS x If)]xSa Equation 5-1.	123,500 (S-1)
		Aa = Allowable area At=Tabular allowable area factor	
		NS=Tabular allowable area factor for a nonsprinklered building	
		If=Area factor increase due to frontage at 506.3	
		B (NS)=UL (IB)	
		S-1 (NS)=48,000 (IB)	
	Section 506.3	Frontage increase.	If=0.75
		W=(L1 X w1 + L2 x w2) Equation 5-4	0.70
		W= Calculated width of public way or open space	
		Ln-Length of a portion of the exterior perimeter wall	
		F=Building perimeter that fronts on a public way or open space having a width of	
		20 feet or more. If=[F/p-0.25]W/30 Equation 5-5	
		p = Perimeter of entire building	
	Section 508.3.2		123,500
		Proposed Building Area at B occupancy	11,383
		Proposed Building Area at S-1 occupancy	31,858
		Proposed Building Area at S-2 occupancy	1,895
		Proposed Building Area (total)	45,136
	Section 508.3.3 Section 508.4.2	Occupancy separation for Group S-1 from Group B	None 0.72
		Allowable building area - In each story, the building area shall be such that the sum of the ratios of the actual building area of each separated occupancy divided by the allowable building area of each separated occupancy shall not exceed 1.	
	Table 508.4	Required separation of occupancies between S-1 & B	None
Chapter 6: Types of Construction	Section 602.2	Types I and II - Types I and II construction are those types of construction in which the building elements listed in Table 601 are of noncombustible materials, except as permitted in Section 603 and elsewhere in this code.	IIA
	Table 601	Fire-resistance rating requirement for building elements in hours:	
		Primary structural frame	1
		Bearing walls Exterior	1
		Bearing walls Interior	1
		Nonbearing walls and partitions exterior Nonbearing walls and partitions interior	see Table 60
		Floor construction and associated secondary members	1
		Roof construction and associated secondary members	
		(Except in Group F-1, H, M and S-1 occupancies, fire protection of structural members shall not be required, including protection of roof framing and decking where every part of the roof construction is 20 feet or more above any floor immediately below. Fire-retardant-treated wood members shall be allowed to be used for such unprotected members.)	1
	Table 602	Fire resistance rating requirements for exterior walls based on fire separation distance, Type IIA X > 30 feet	0
Chapter 7:	Table 705.8	Exterior Wall: Maximum area of exterior wall openings base on fire separation	No Limit
Fire and Smoke Protection Feature		distance and degree of opening protection, 20 to less than 25 feet with sprinklered and unprotected members.	

NOT FOR CONSTRUCTION

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DSN CHK APP REVISION

DESIGNED BY: REFERENCE CONCEPT DRAWINGS CHAN CHEANG DRAWN BY: STEPHANIE GREEN CHECKED BY:

9849 REGISTERED ARCHITECT CHAN LAM CHEANG STATE OF WASHINGTON SHEENA ZIMMERMAN

AHJ:

DONN HOGAN

APPROVED BY:



PABLO LOPEZ-HILFIKER





2/27/2024

SOUNDTRANSIT

PACKAGE #

AS NOTED FILENAME: OMFS-M09-A-V2022.RV CONTRACT No.: AE-0030-17

SUBMITTAL DATE:


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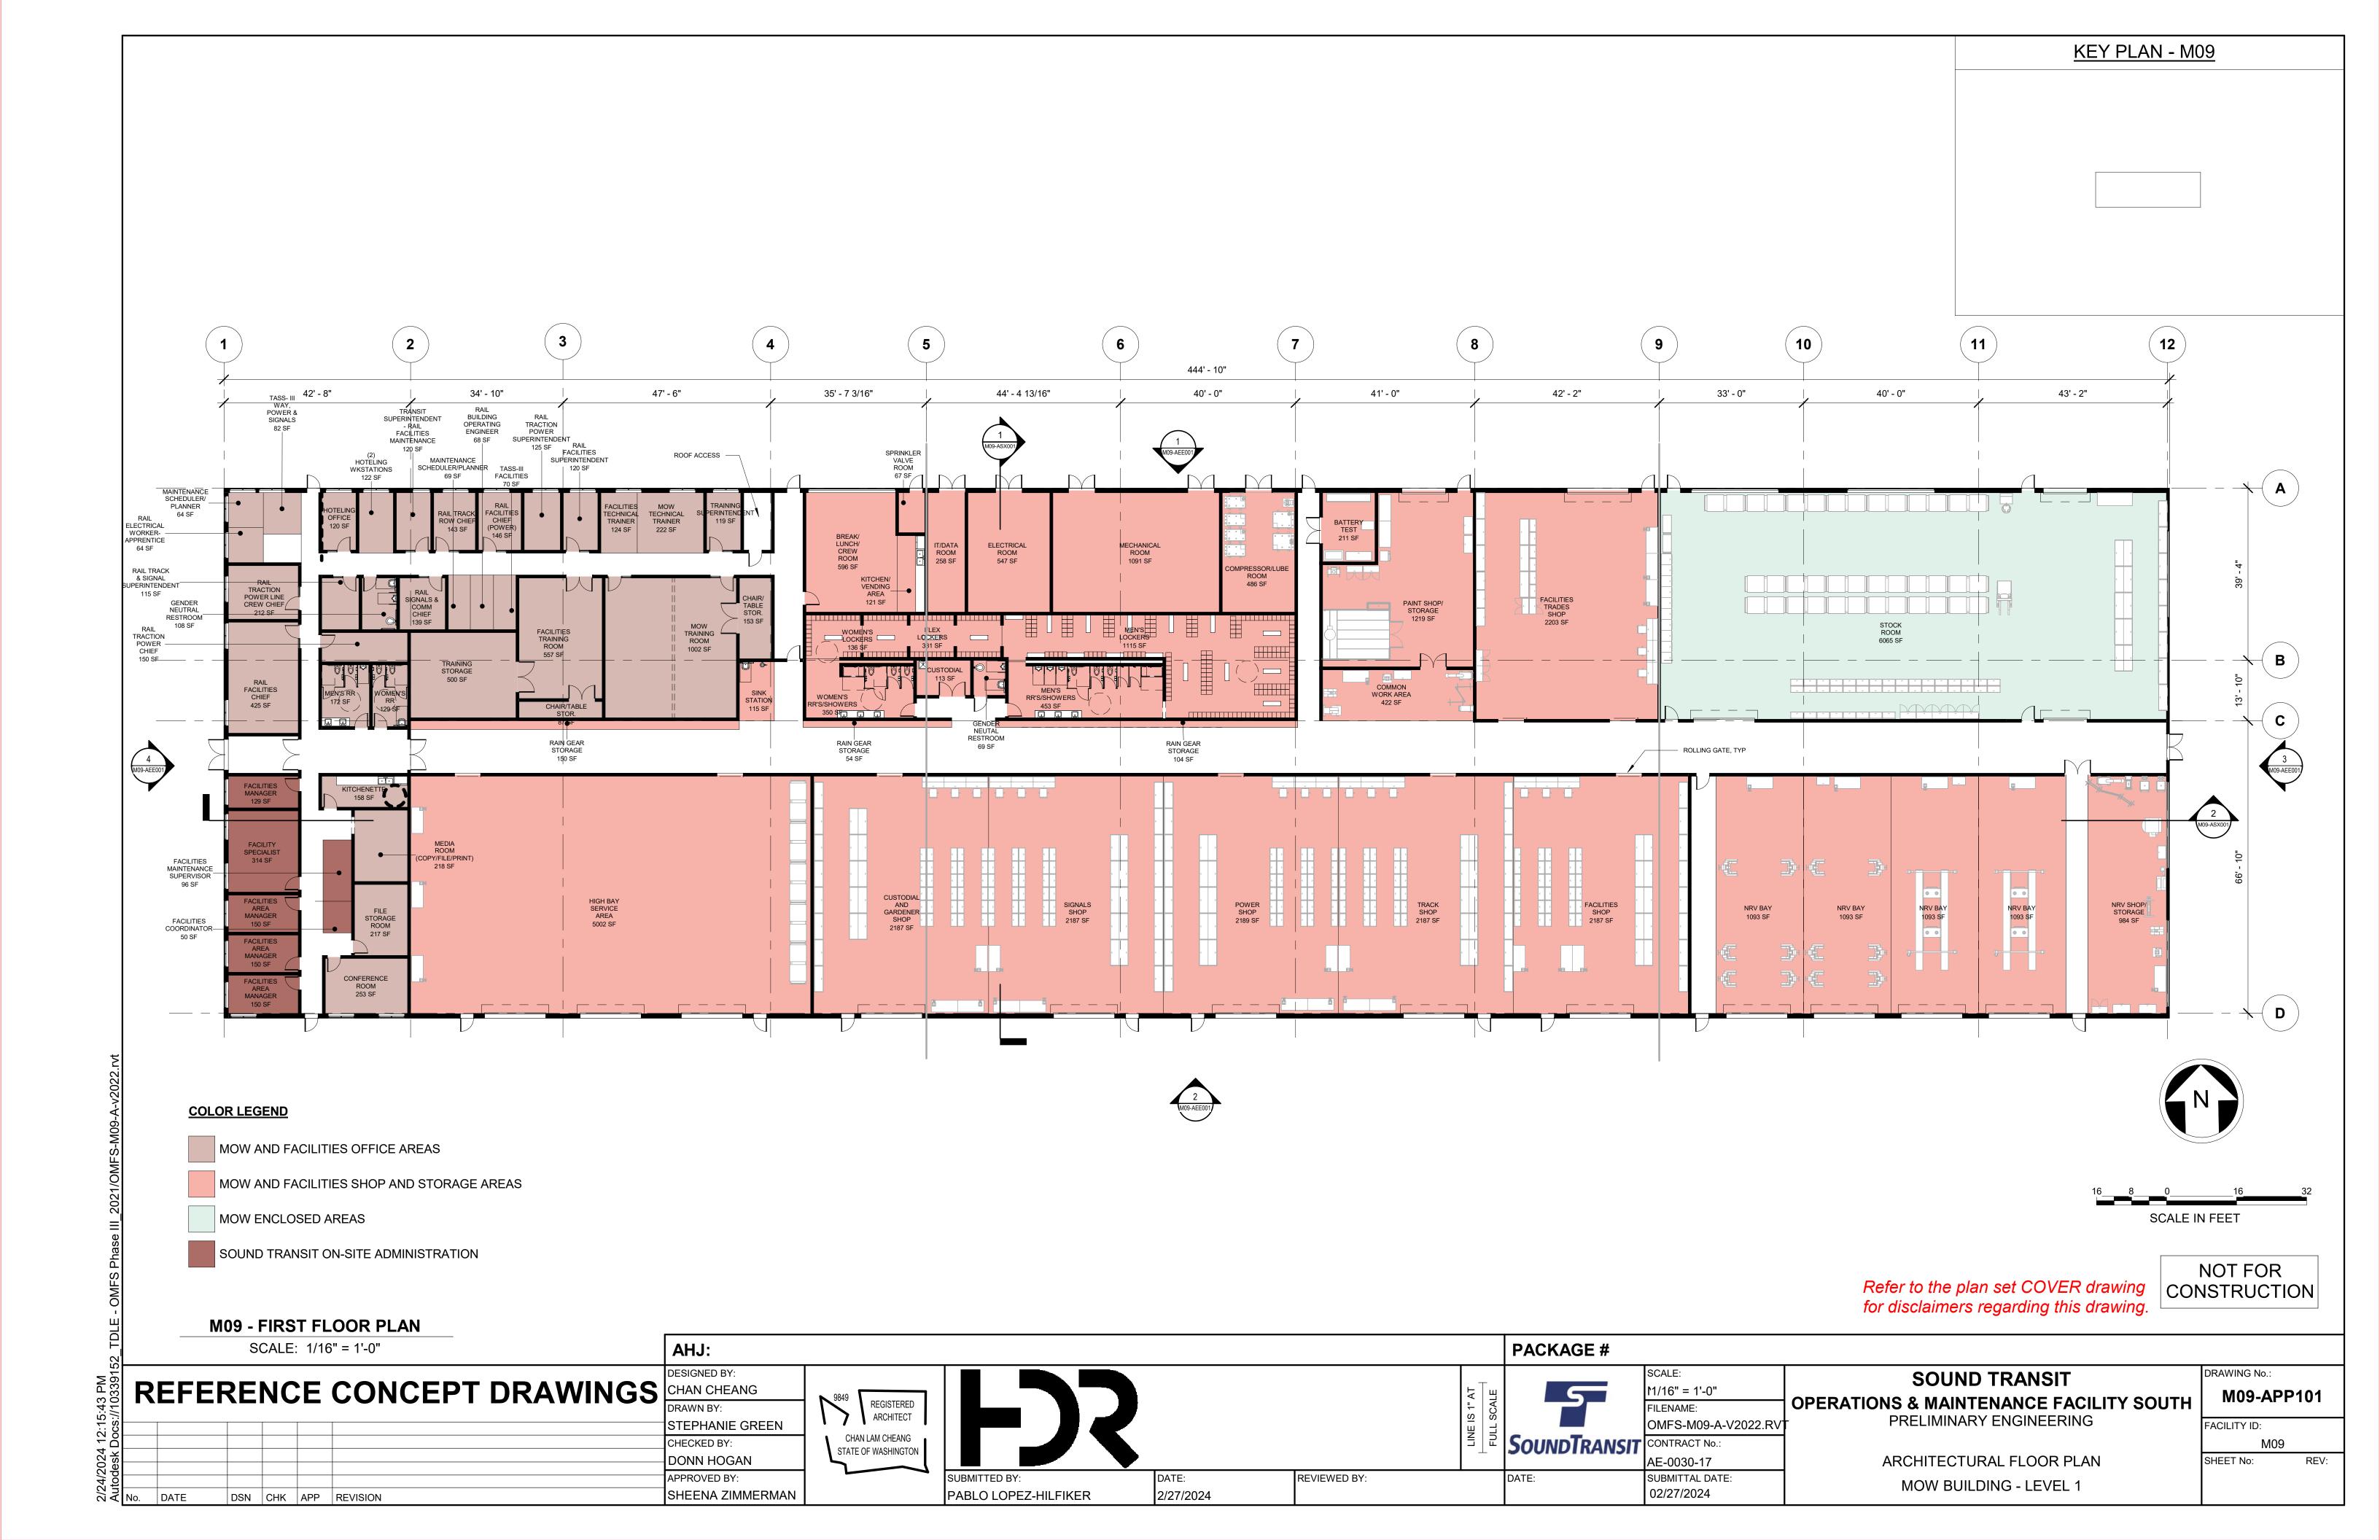
SOUND TRANSIT OPERATIONS & MAINTENANCE FACILITY SOUTH PRELIMINARY ENGINEERING


DRAWING No.: M09-AZN007

ARCHITECTURAL LIFE SAFETY MOW BUILDING OCCUPANCY CLASSIFICATION SCHEDULE

FACILITY ID: M09 SHEET No:



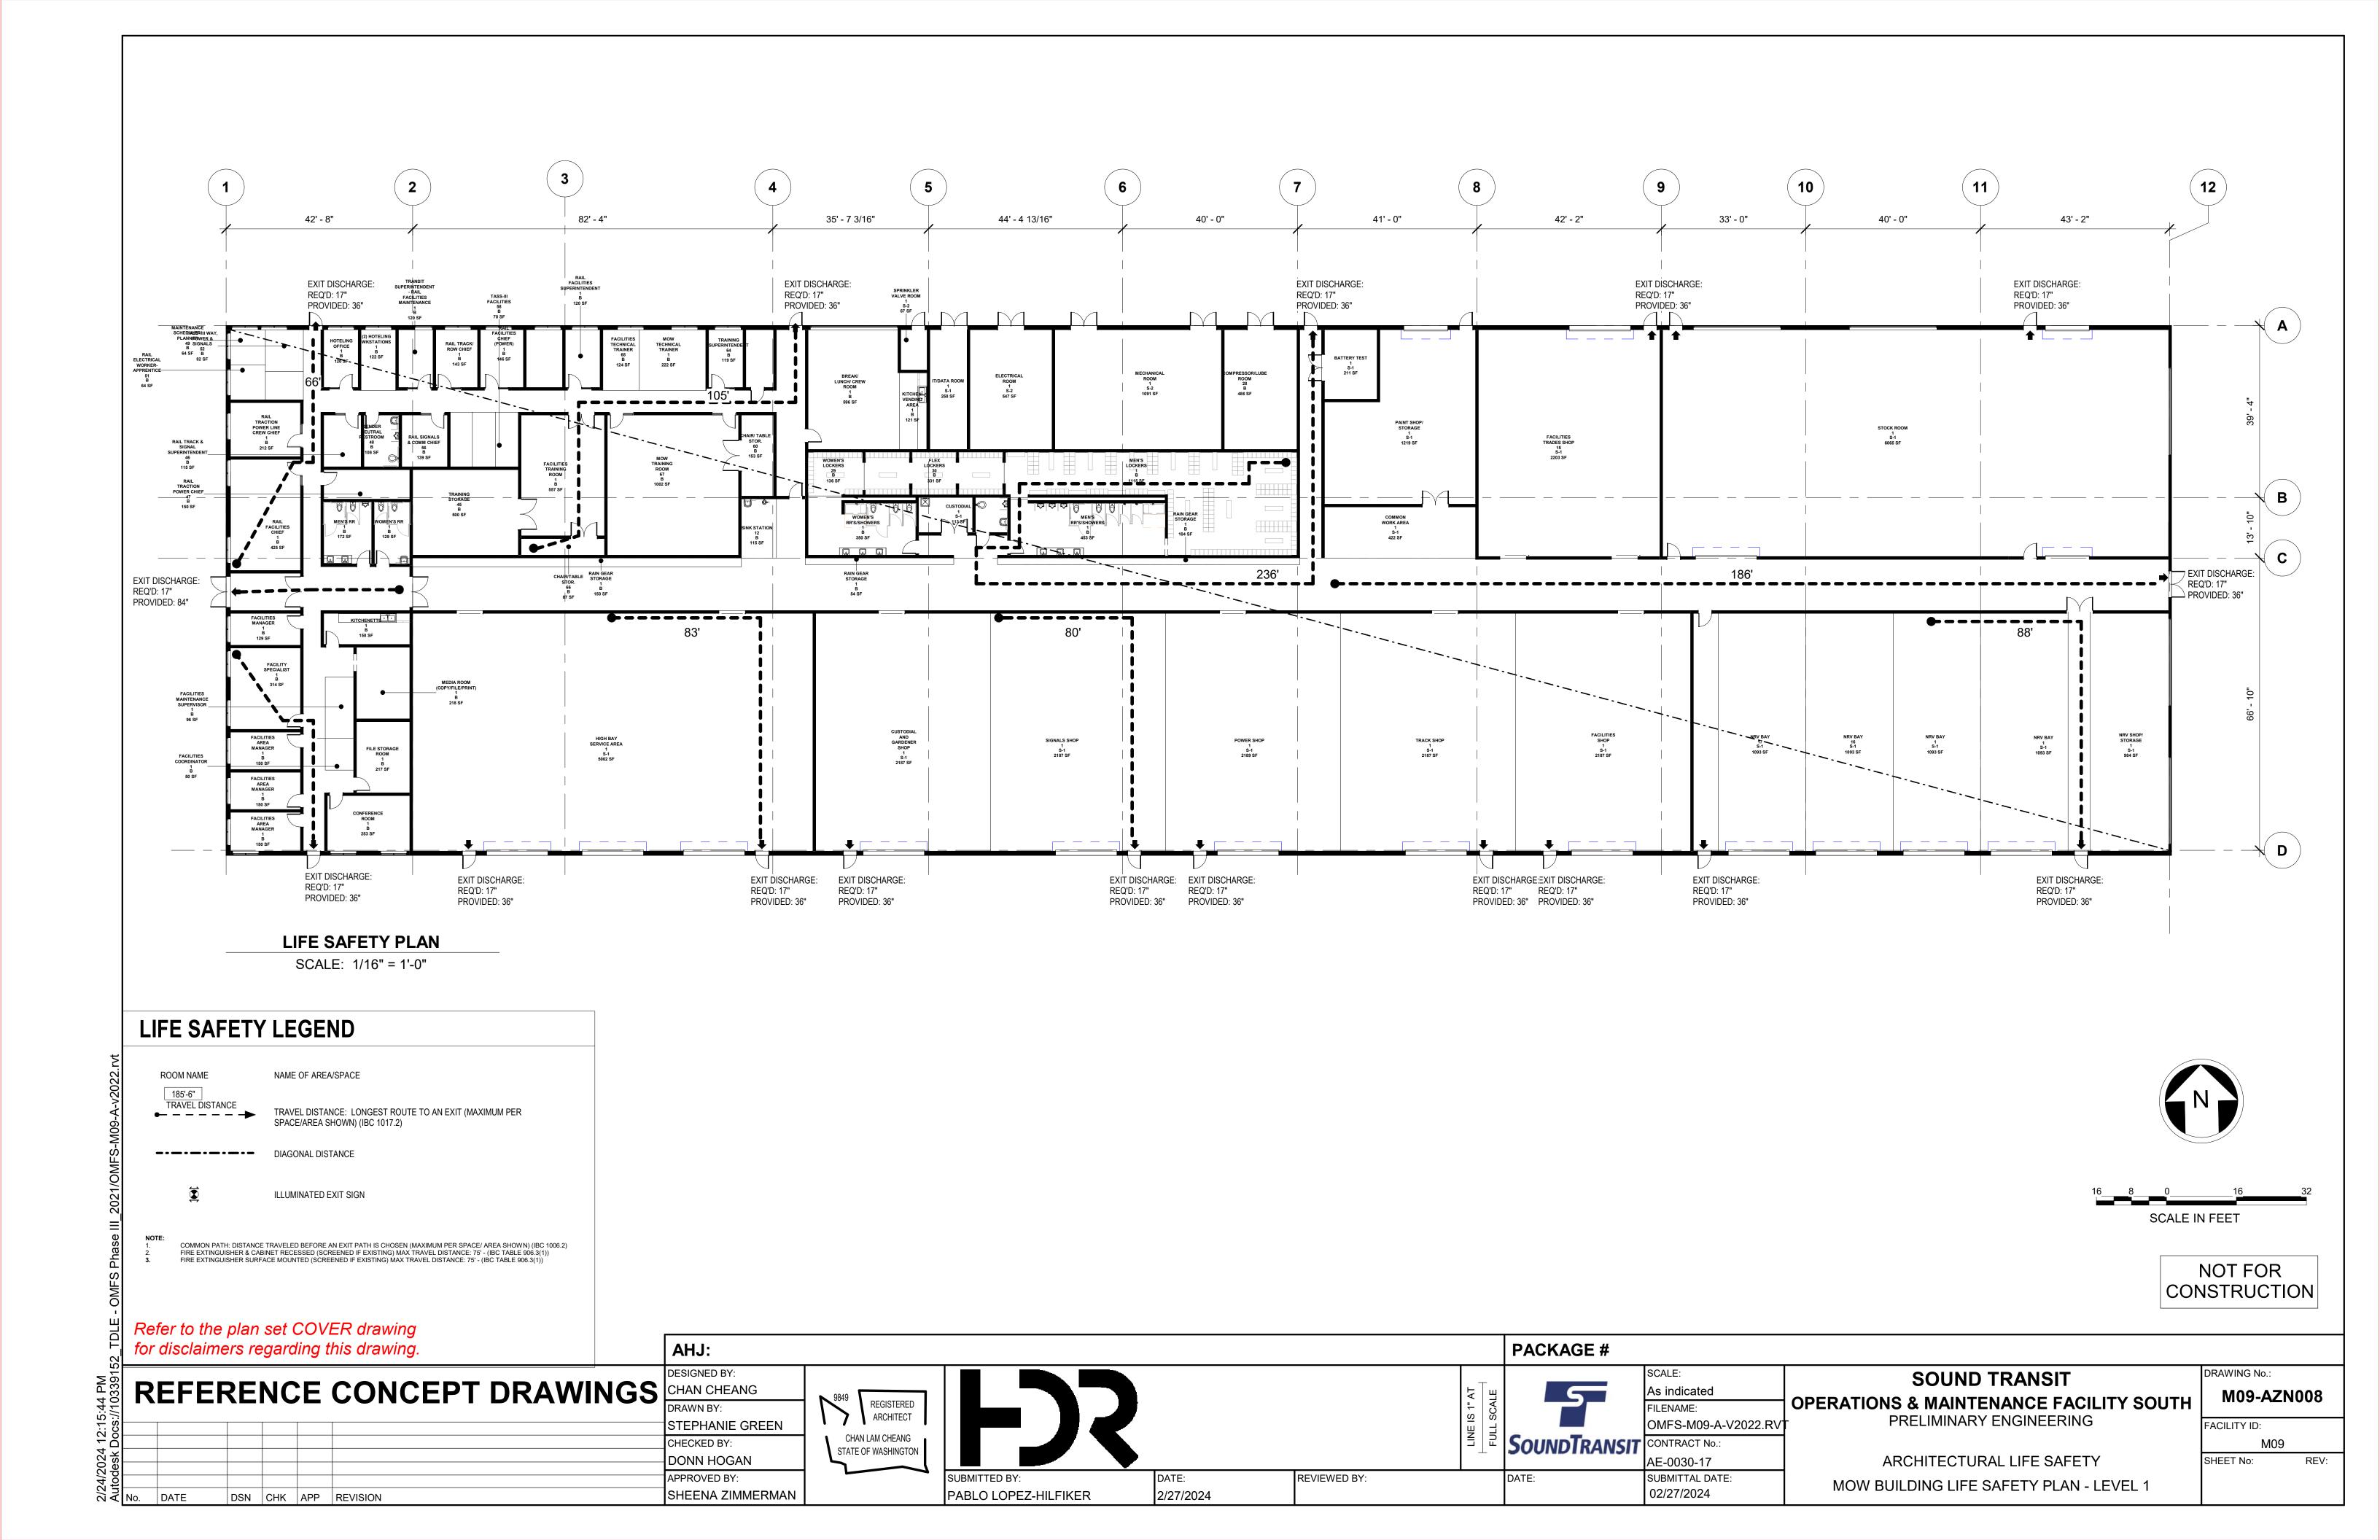

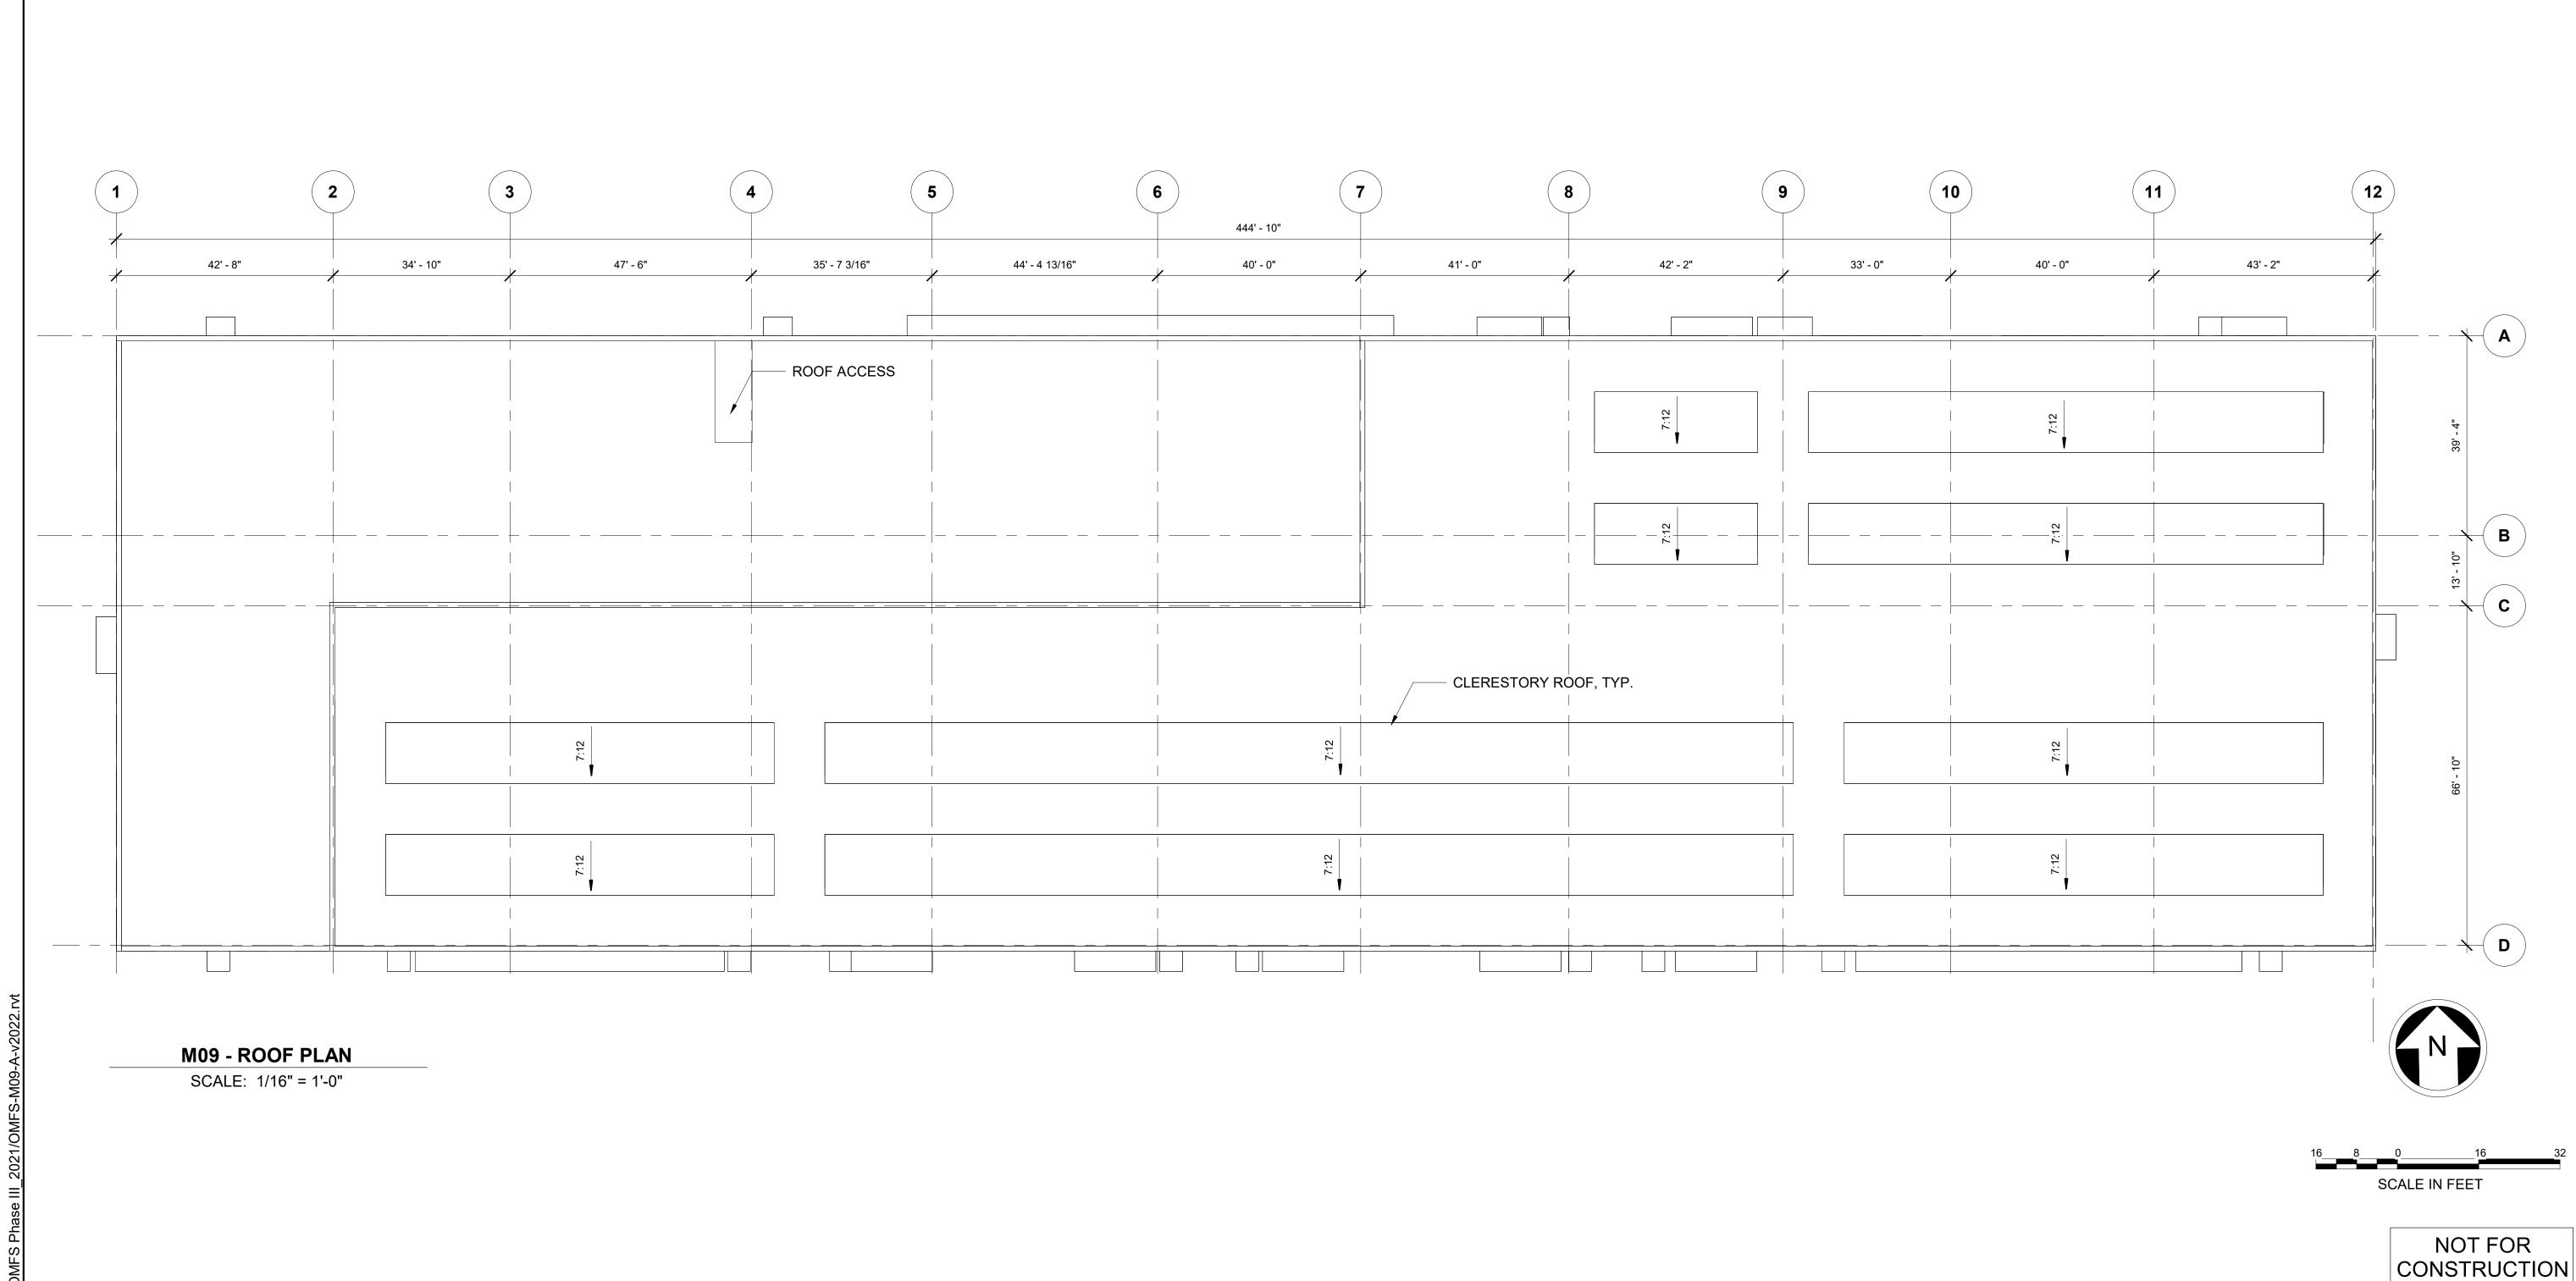

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9849 REGISTERED ARCHITECT CHAN LAM CHEANG STATE OF WASHINGTON PABLO LOPEZ-HILFIKER

AHJ:

DATE:

REVIEWED BY:

2/27/2024

PACKAGE #

SOUNDTRANSIT CONTRACT No.: AE-0030-17 SUBMITTAL DATE:

1/16" = 1'-0" FILENAME: OMFS-M09-A-V2022.RV

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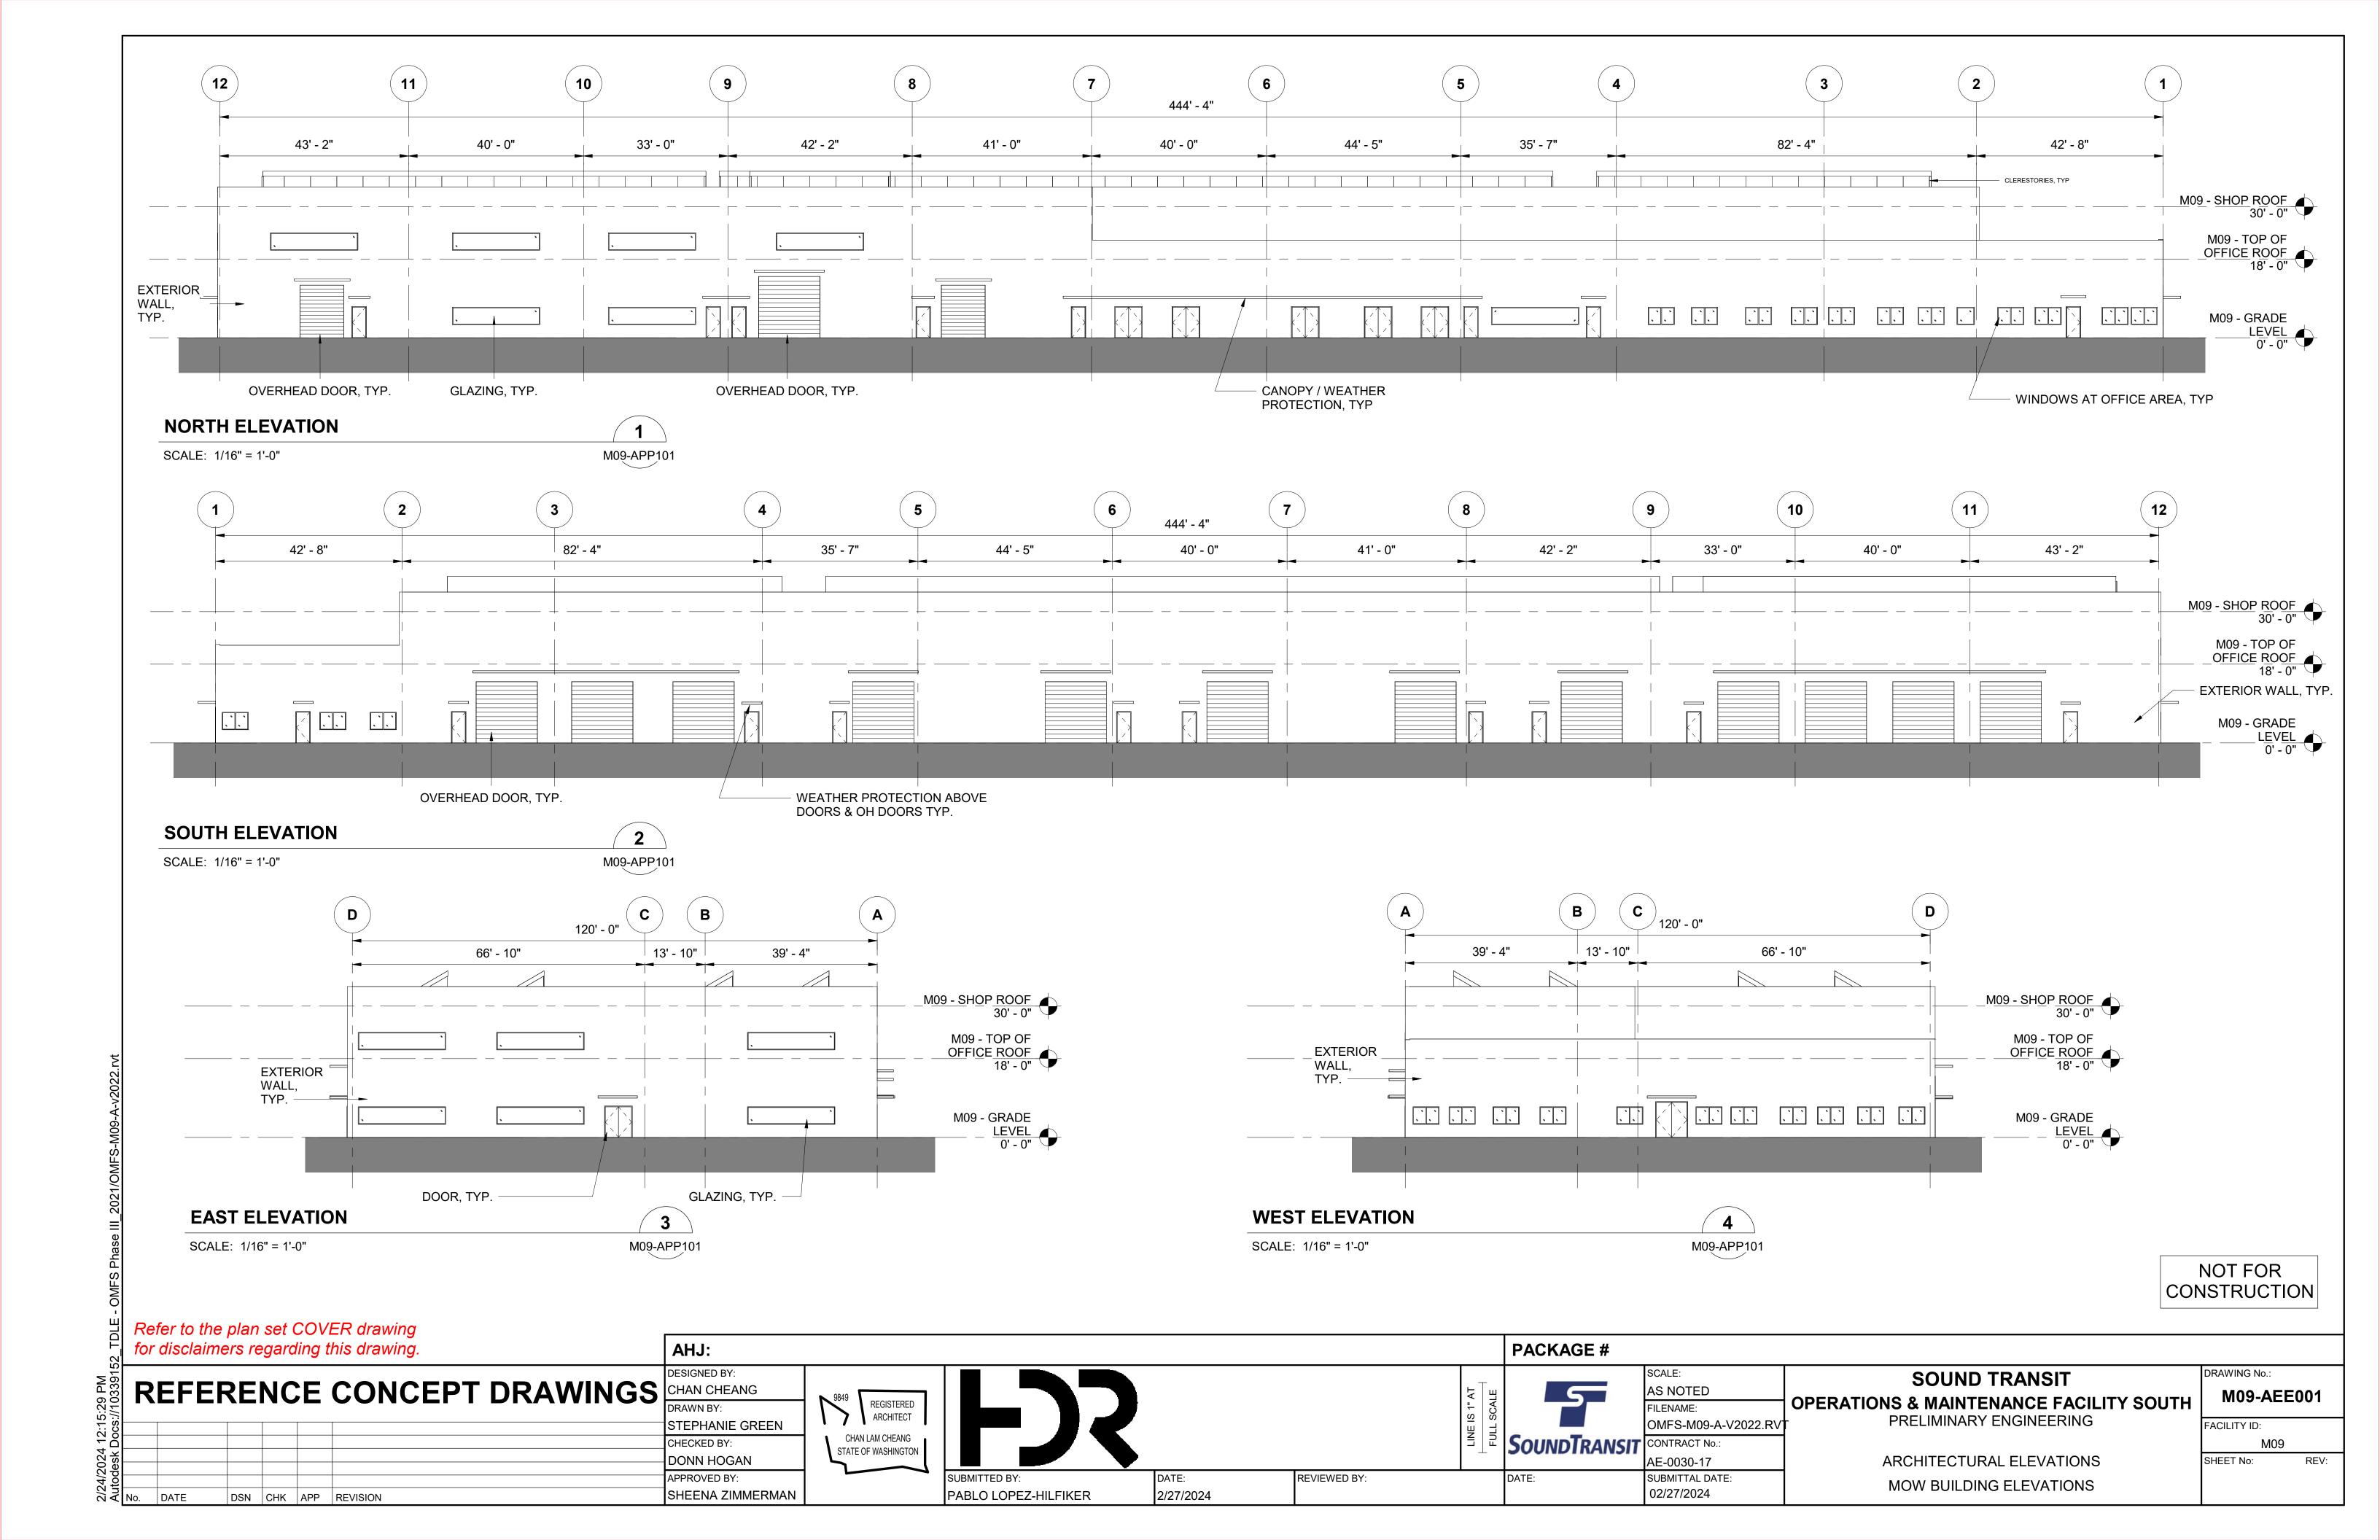
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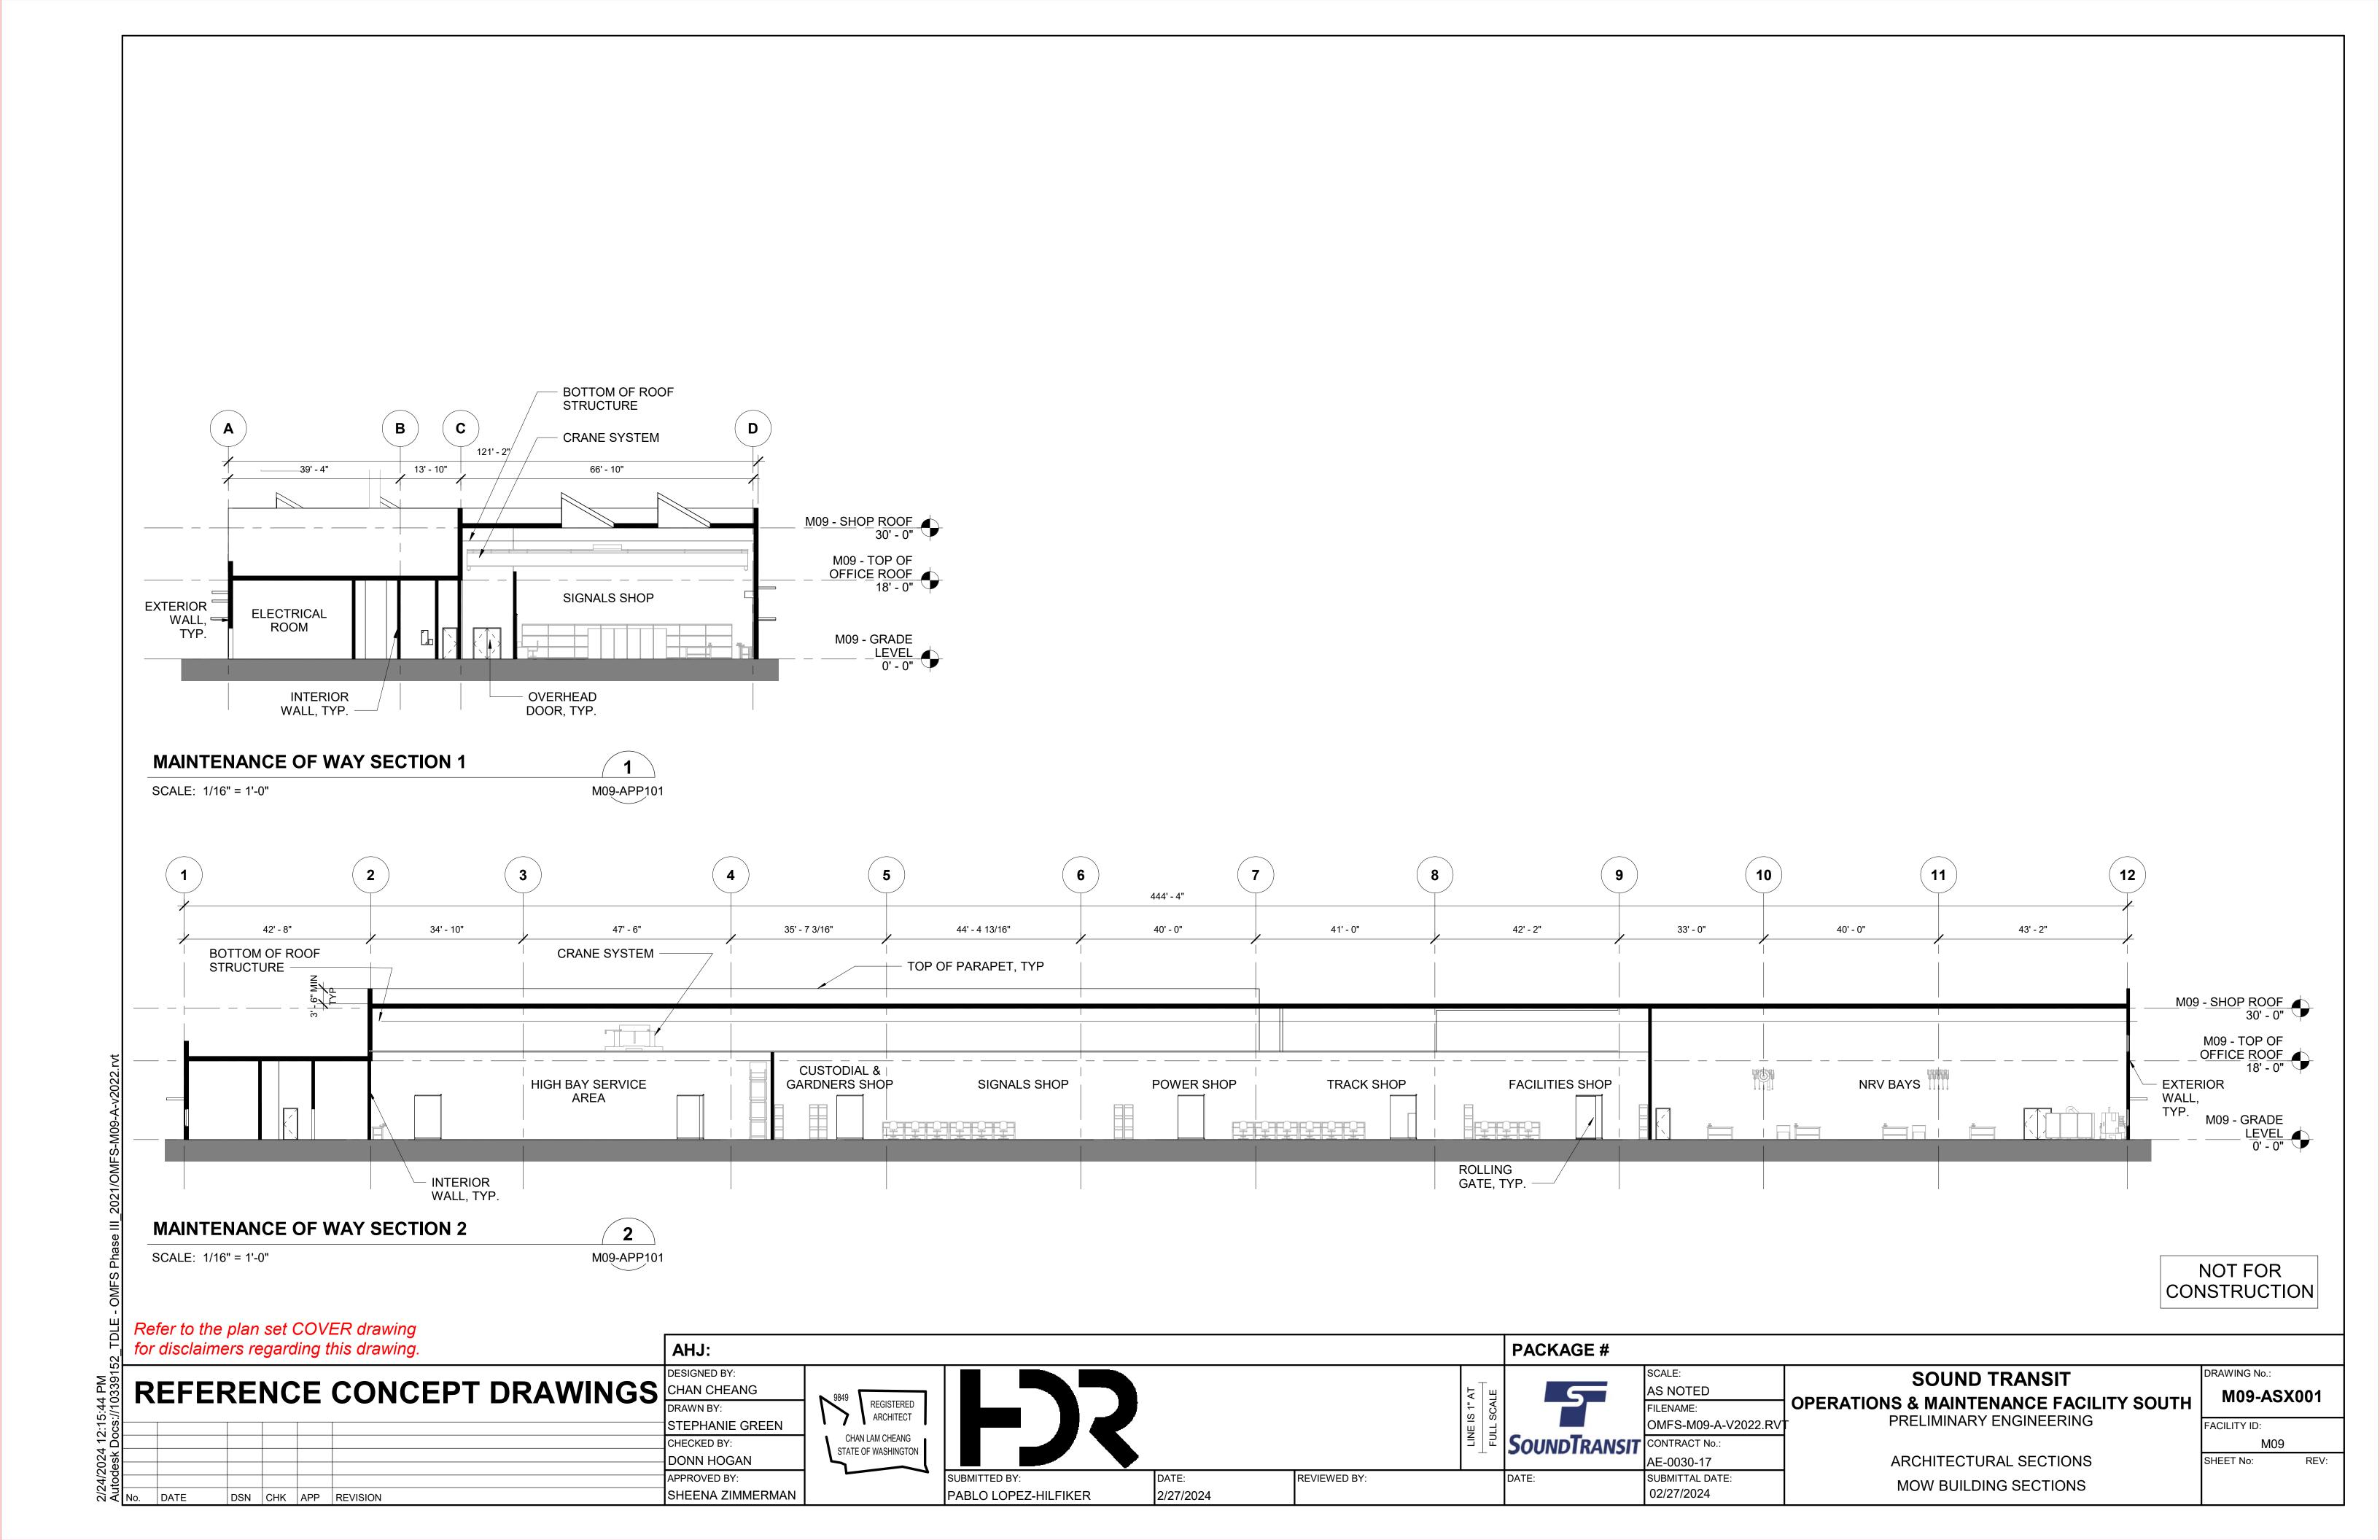
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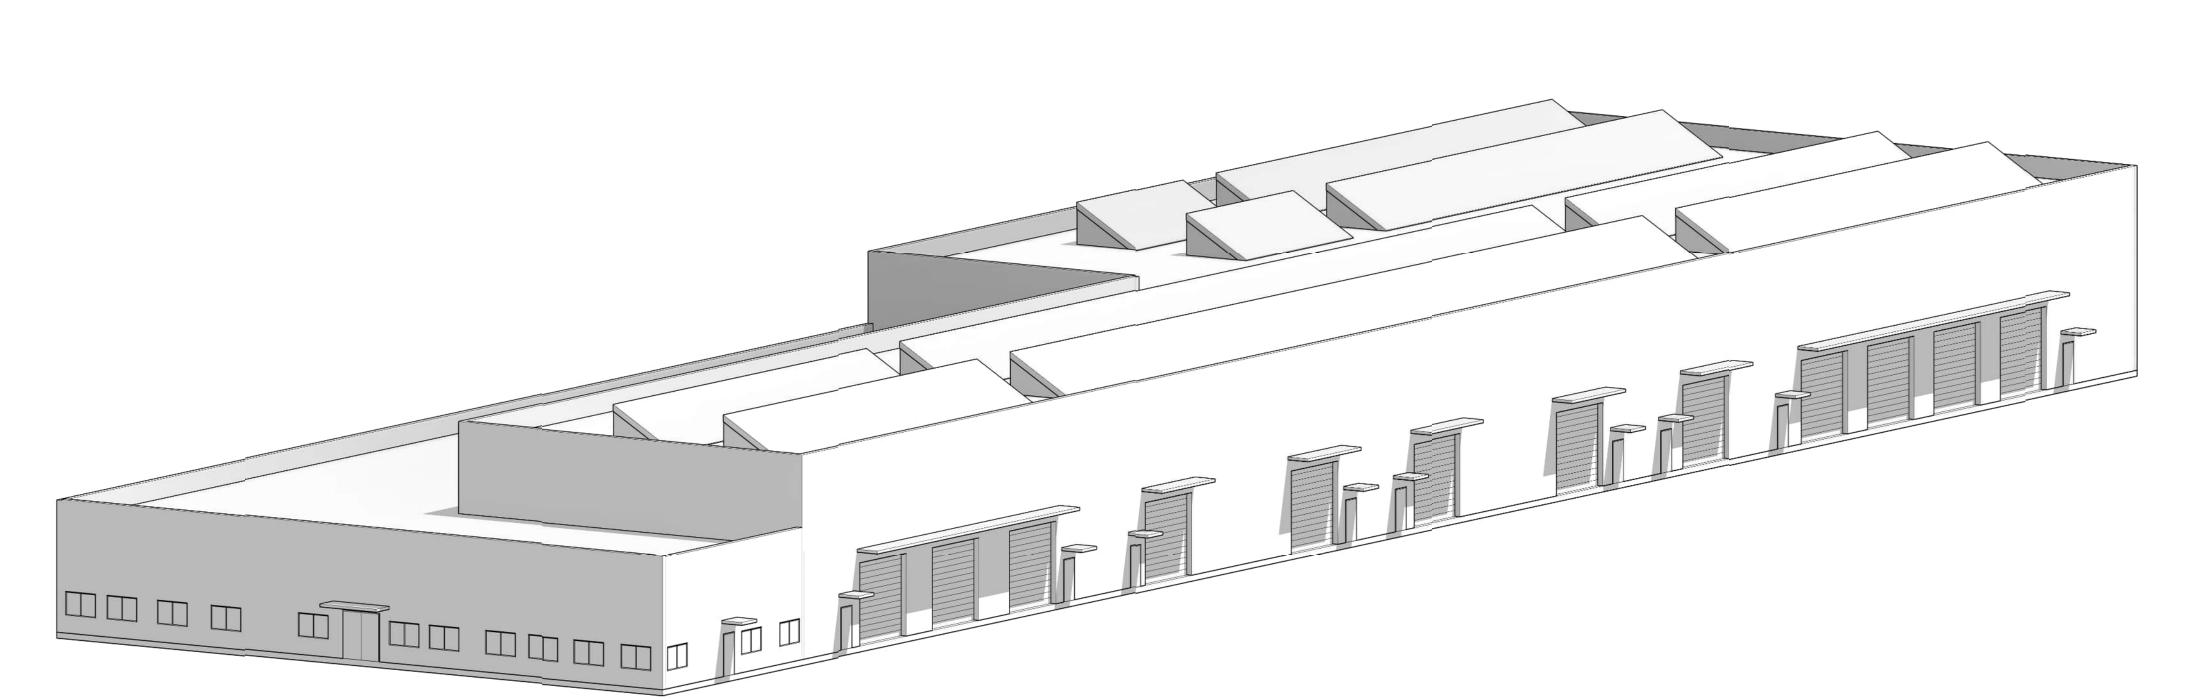
ARCHITECTURAL ROOF PLAN MOW BUILDING - ROOF PLAN

FACILITY ID: M09

SHEET No:







MAINTENANCE OF WAY MASSING VIEW - LOOKING NE FROM SW CORNER

AHJ:

MAINTENANCE OF WAY MASSING VIEW - LOOKING SW FROM NE CORNER

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STEPHANIE GREEN CHECKED BY: DONN HOGAN APPROVED BY: SHEENA ZIMMERMAN DSN CHK APP REVISION

9849 REGISTERED ARCHITECT CHAN LAM CHEANG STATE OF WASHINGTON

PABLO LOPEZ-HILFIKER

DATE: 2/27/2024

REVIEWED BY:

PACKAGE # SOUNDTRANSIT CONTRACT No.:

FILENAME: OMFS-M09-A-V2022.RV AE-0030-17

SUBMITTAL DATE:

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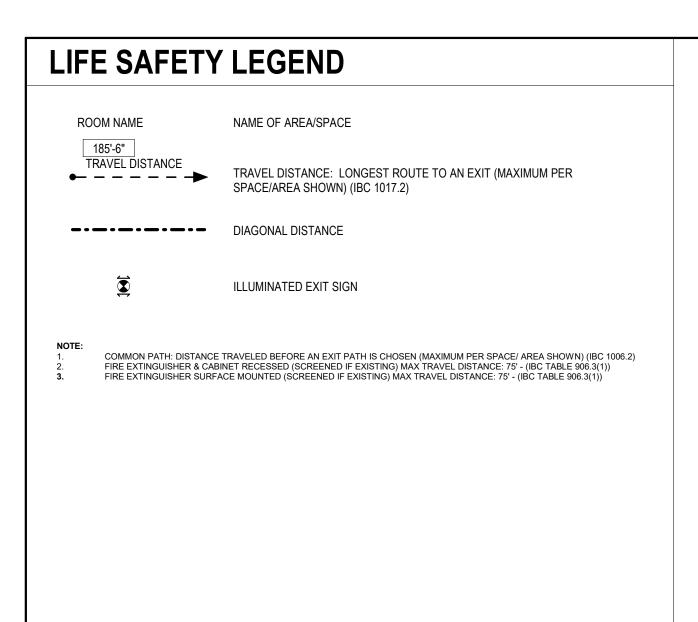
SOUND TRANSIT OPERATIONS & MAINTENANCE FACILITY SOUTH
PRELIMINARY ENGINEERING

MOW BUILDING MASSING VIEWS


ARCHITECTURAL MASSING VIEWS

DRAWING No.: M09-AMP001 FACILITY ID:

M09 SHEET No:



OCCUPANCY CLASSIF	ICATION SCHEDULE - LEVEL 1 AREAS	
Name	Area	Occupancy
S-1		
NON-REVENUE VEHICLE WASH BAY	1258 SF	S-1
WASH EQUIP. ROOM	210 SF	S-1
FACILITY NRV	2059 SF	S-1
	3527 SF	

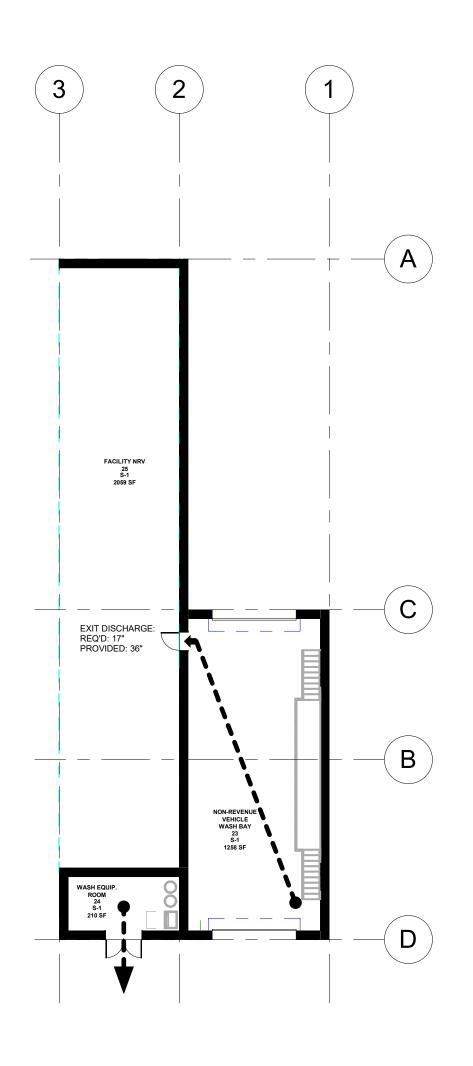

LIFE SAFETY PLAN SCALE: 1/16" = 1'-0"

CODE REVIEW

2.2.4 Table - NRV Wash Code Analysis (M09W)

2021 IBC

Chapter	Section	Description	O&M Facility
Chapter 3: Use and Occupancy Classification	311.2	Business Group B occupancy includes, among others, the use of a building or structure, or a portion thereof, for office, professional or service-type transactions, including storage of records and accounts. Business occupancies shall include, but not be limited to, the following: Car wash	В
Chapter 5: Building Height and Area	Table 504.3	Allowable Building Height in Feet Above Grade Plane. Group A-2, B, S-1 & S-2 for Type IB, Sprinklered, for Type IIB.	75 feet
	Table 504.4	Allowable number of stories above grade plane.	4
		Proposed building story	1
	Table 506.2	Allowable Area Factor (B per table)	92,000
		Proposed Building Area at S-1 occupancy	3,474
	Section 508.4.2	Allowable building area - In each story, the building area shall be such that the sum of the ratios of the actual building area of each separated occupancy divided by the allowable building area of each separated occupancy shall not exceed 1.	0.03
Chapter 6: Types of Construction	Section 602.5	Types I and II - Types I and II construction are those types of construction in which the building elements listed in Table 601 are of noncombustible materials, except as permitted in Section 603 and elsewhere in this code.	IIB
	Table 601	Fire-resistance rating requirement for building elements in hours:	
		Primary structural frame	0
		Bearing walls Exterior	0
		Bearing walls Interior	0
		Nonbearing walls and partitions exterior	see Table 60
		Nonbearing walls and partitions interior	0
		Floor construction and associated secondary members	0
		Roof construction and associated secondary members	
		(Except in Group F-1, H, M and S-1 occupancies, fire protection of structural members shall not be required, including protection of roof framing and decking where every part of the roof construction is 20 feet or more above any floor immediately below. Fire-retardant-treated wood members shall be allowed to be used for such unprotected members.)	0
	Table 602	Fire resistance rating requirements for exterior walls based on fire separation distance, Type IIB: 30 feet > X > 10	0
Chapter 7: Fire and Smoke Protection Feature	Table 705.8	Maximum area of exterior wall openings based on fire separation distance and degree of opening protection, 20 to less than 25 feet with sprinklered and unprotected members.	No Limit



NOT FOR CONSTRUCTION

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DSN CHK APP REVISION

DESIGNED BY: REFERENCE CONCEPT DRAWINGS CHAN CHEANG DRAWN BY:

9849 REGISTERED ARCHITECT CHAN LAM CHEANG STATE OF WASHINGTON SHEENA ZIMMERMAN

PACKAGE # SOUNDTRANSIT CONTRACT No.:

AS NOTED FILENAME: OMFS-M09W-A-V2022.RVT AE-0030-17

SOUND TRANSIT OPERATIONS & MAINTENANCE FICILITY SOUTH PRELIMINARY ENGINEERING

M09W-AZN009 FACILITY ID:

DRAWING No.:

ARCHITECTURAL LIFE SAFETY

M09W SHEET No:

STEPHANIE GREEN CHECKED BY: DONN HOGAN APPROVED BY:


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2/27/2024 PABLO LOPEZ-HILFIKER


REVIEWED BY:

SUBMITTAL DATE: 02/27/2024

NRV LIFE SAFETY PLAN

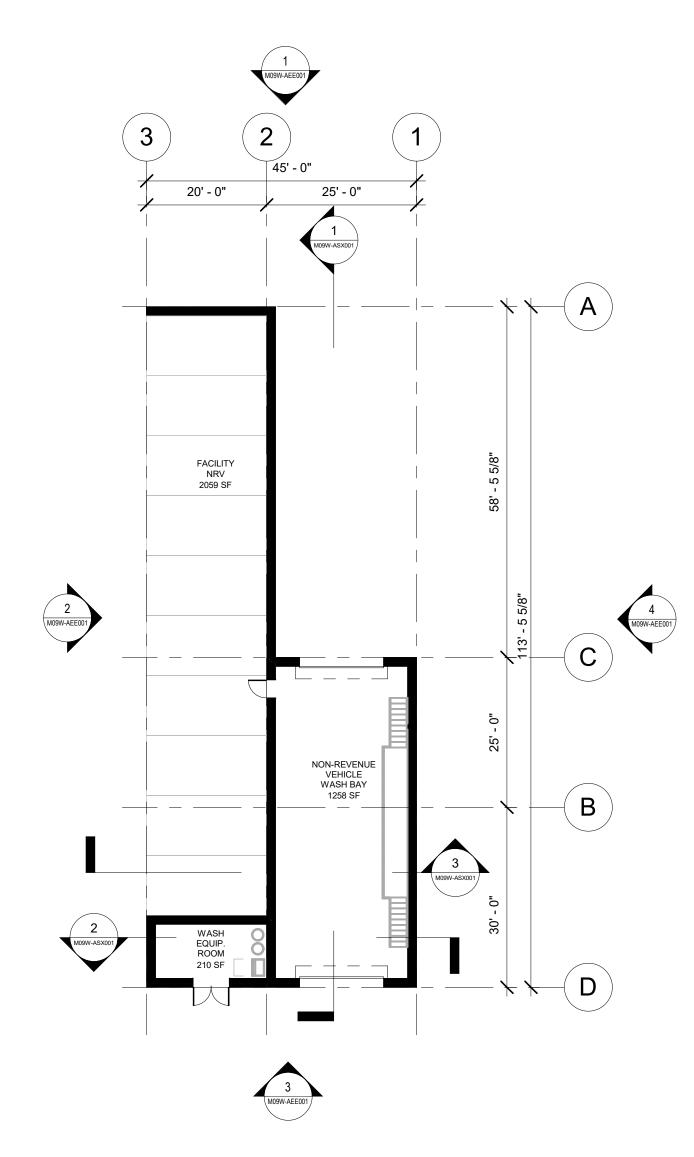

NRV WASH FLOOR PLAN SCALE: 1/16" = 1'-0"

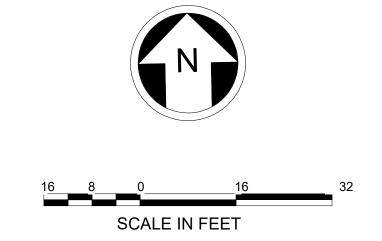

NOT FOR CONSTRUCTION

DRAWING No.:

Refer to the plan set COVER drawing for disclaimers regarding this drawing.

DSN CHK APP REVISION

REFERENCE CONCEPT DRAWINGS CHAN CHEANG DRAWN BY:

DESIGNED BY: STEPHANIE GREEN CHECKED BY: DONN HOGAN APPROVED BY: SHEENA ZIMMERMAN

AHJ:

9849 REGISTERED ARCHITECT CHAN LAM CHEANG STATE OF WASHINGTON PABLO LOPEZ-HILFIKER

SUBMITTED BY:	DATE:
PABLO LOPEZ-HILFIKER	2/27/2024

PACKAGE # SOUNDTRANSIT CONTRACT No.:

/1/16" = 1'-0" FILENAME: OMFS-M09W-A-V2022.RVT


SOUND TRANSIT OPERATIONS & MAINTENANCE FICILITY SOUTH


PRELIMINARY ENGINEERING


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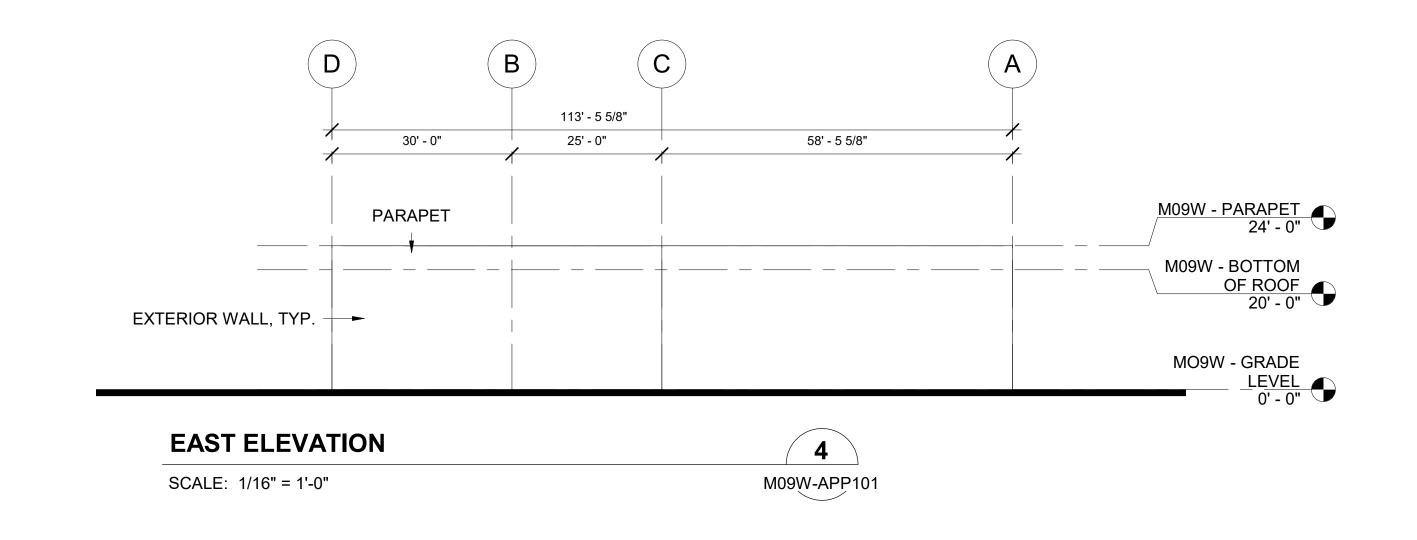
M09W SHEET No:

AE-0030-17 ARCHITECTURAL FLOOR PLAN SUBMITTAL DATE: REVIEWED BY: NRV WASH LEVEL 1 02/27/2024



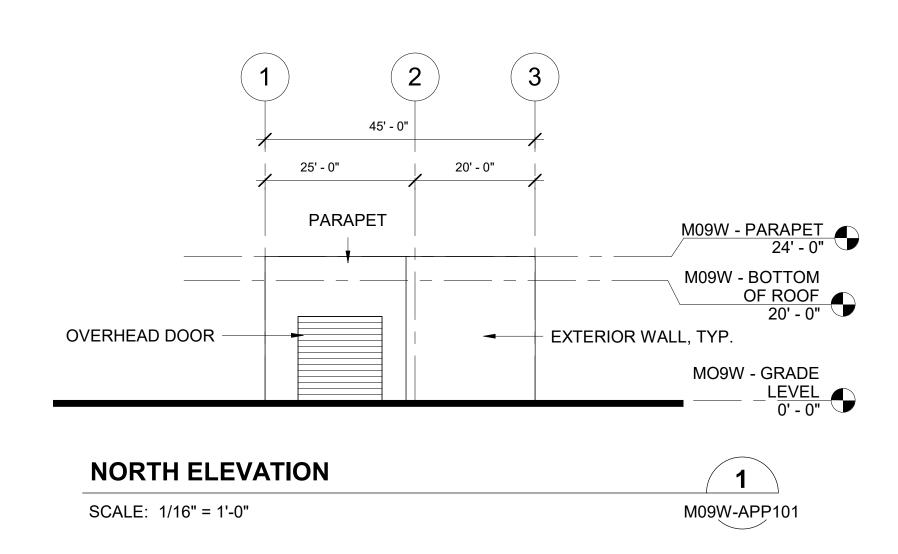

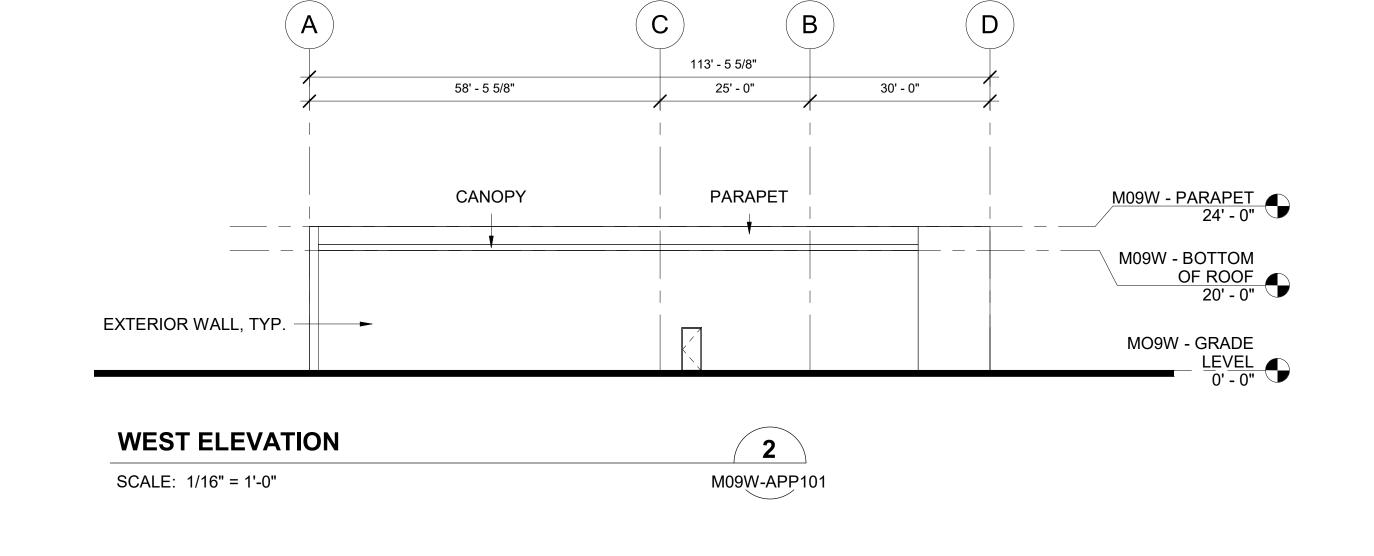

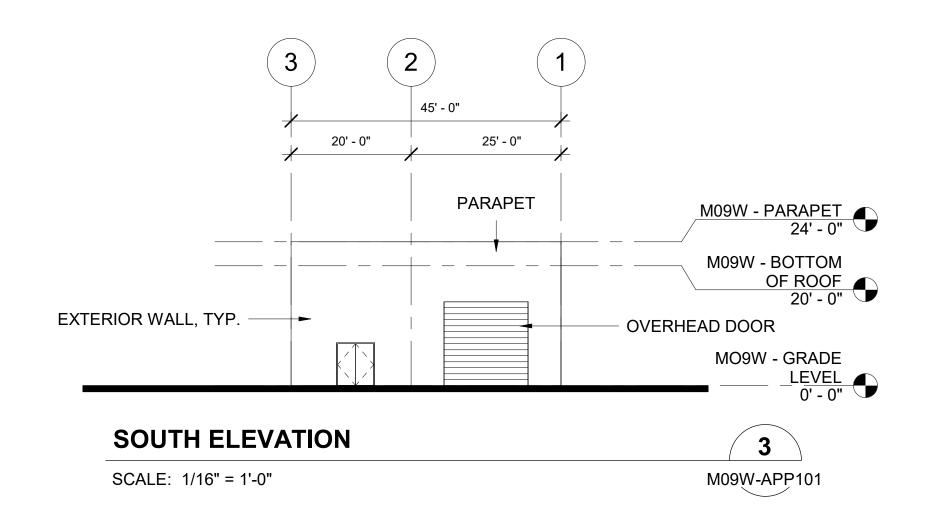

Refer to the plan set COVER drawing for disclaimers regarding this drawing.

DSN CHK APP REVISION

DESIGNED BY: REFERENCE CONCEPT DRAWINGS CHAN CHEANG DRAWN BY:

STEPHANIE GREEN CHECKED BY: DONN HOGAN APPROVED BY: SHEENA ZIMMERMAN

AHJ:

REGISTERED ARCHITECT CHAN LAM CHEANG STATE OF WASHINGTON



SOUNDTRANSIT

PACKAGE #

AS NOTED FILENAME: OMFS-M09W-A-V2022.RVT CONTRACT No.: AE-0030-17

SOUND TRANSIT OPERATIONS & MAINTENANCE FICILITY SOUTH PRELIMINARY ENGINEERING

ARCHITECTURAL ELEVATIONS

DRAWING No.: M09W-AEE001 FACILITY ID:


PABLO LOPEZ-HILFIKER


REVIEWED BY: 2/27/2024


SUBMITTAL DATE: 02/27/2024

NRV WASH ELEVATIONS

M09W SHEET No:

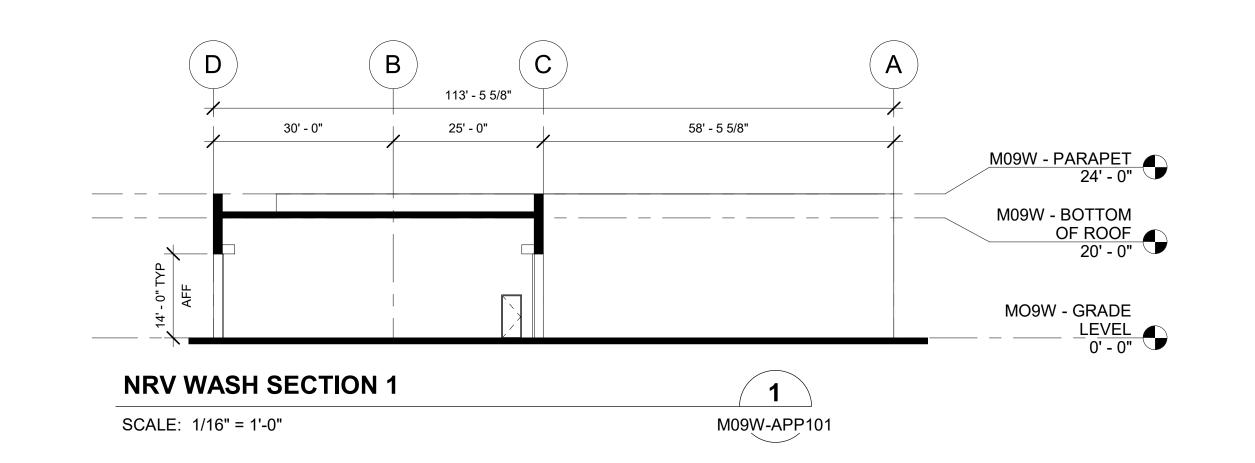

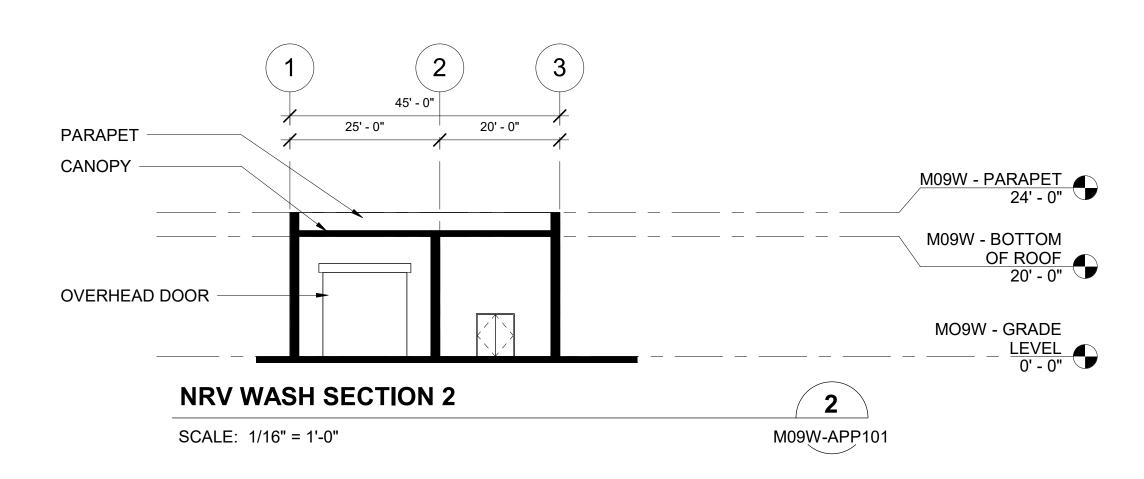


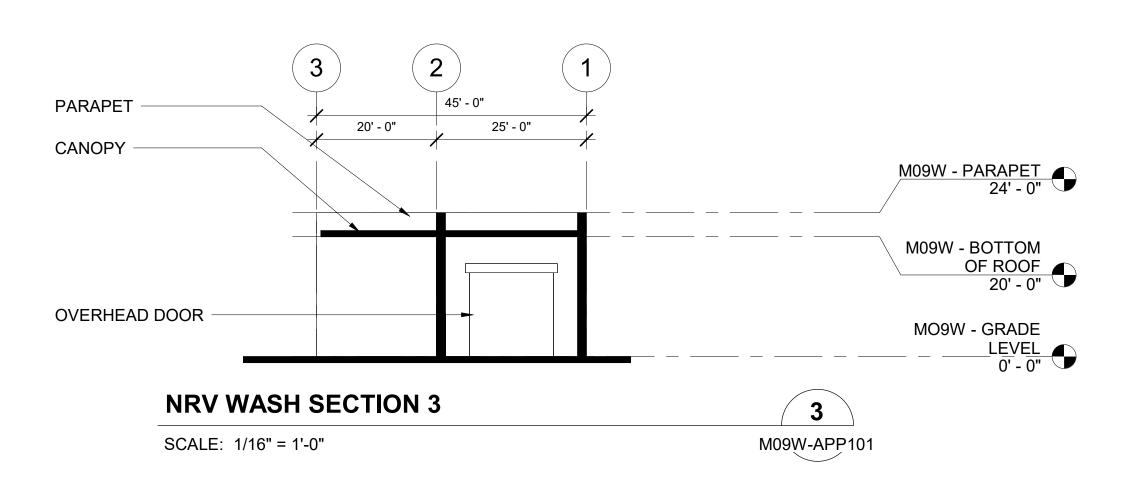

Refer to the plan set COVER drawing for disclaimers regarding this drawing. AHJ: PACKAGE # DESIGNED BY: DRAWING No.: **SOUND TRANSIT** REFERENCE CONCEPT DRAWINGS CHAN CHEANG DRAWN BY: 5 M09W-ASX001 9849 REGISTERED ARCHITECT **OPERATIONS & MAINTENANCE FICILITY SOUTH** FILENAME: PRELIMINARY ENGINEERING OMFS-M09W-A-V2022.RVT STEPHANIE GREEN FACILITY ID: CHAN LAM CHEANG STATE OF WASHINGTON SOUNDTRANSIT CONTRACT No.: M09W CHECKED BY: DONN HOGAN AE-0030-17 ARCHITECTURAL SECTIONS SHEET No: SUBMITTAL DATE: APPROVED BY: DATE: REVIEWED BY: NRV WASH SECTIONS 2/27/2024 02/27/2024 PABLO LOPEZ-HILFIKER

SHEENA ZIMMERMAN

DSN CHK APP REVISION

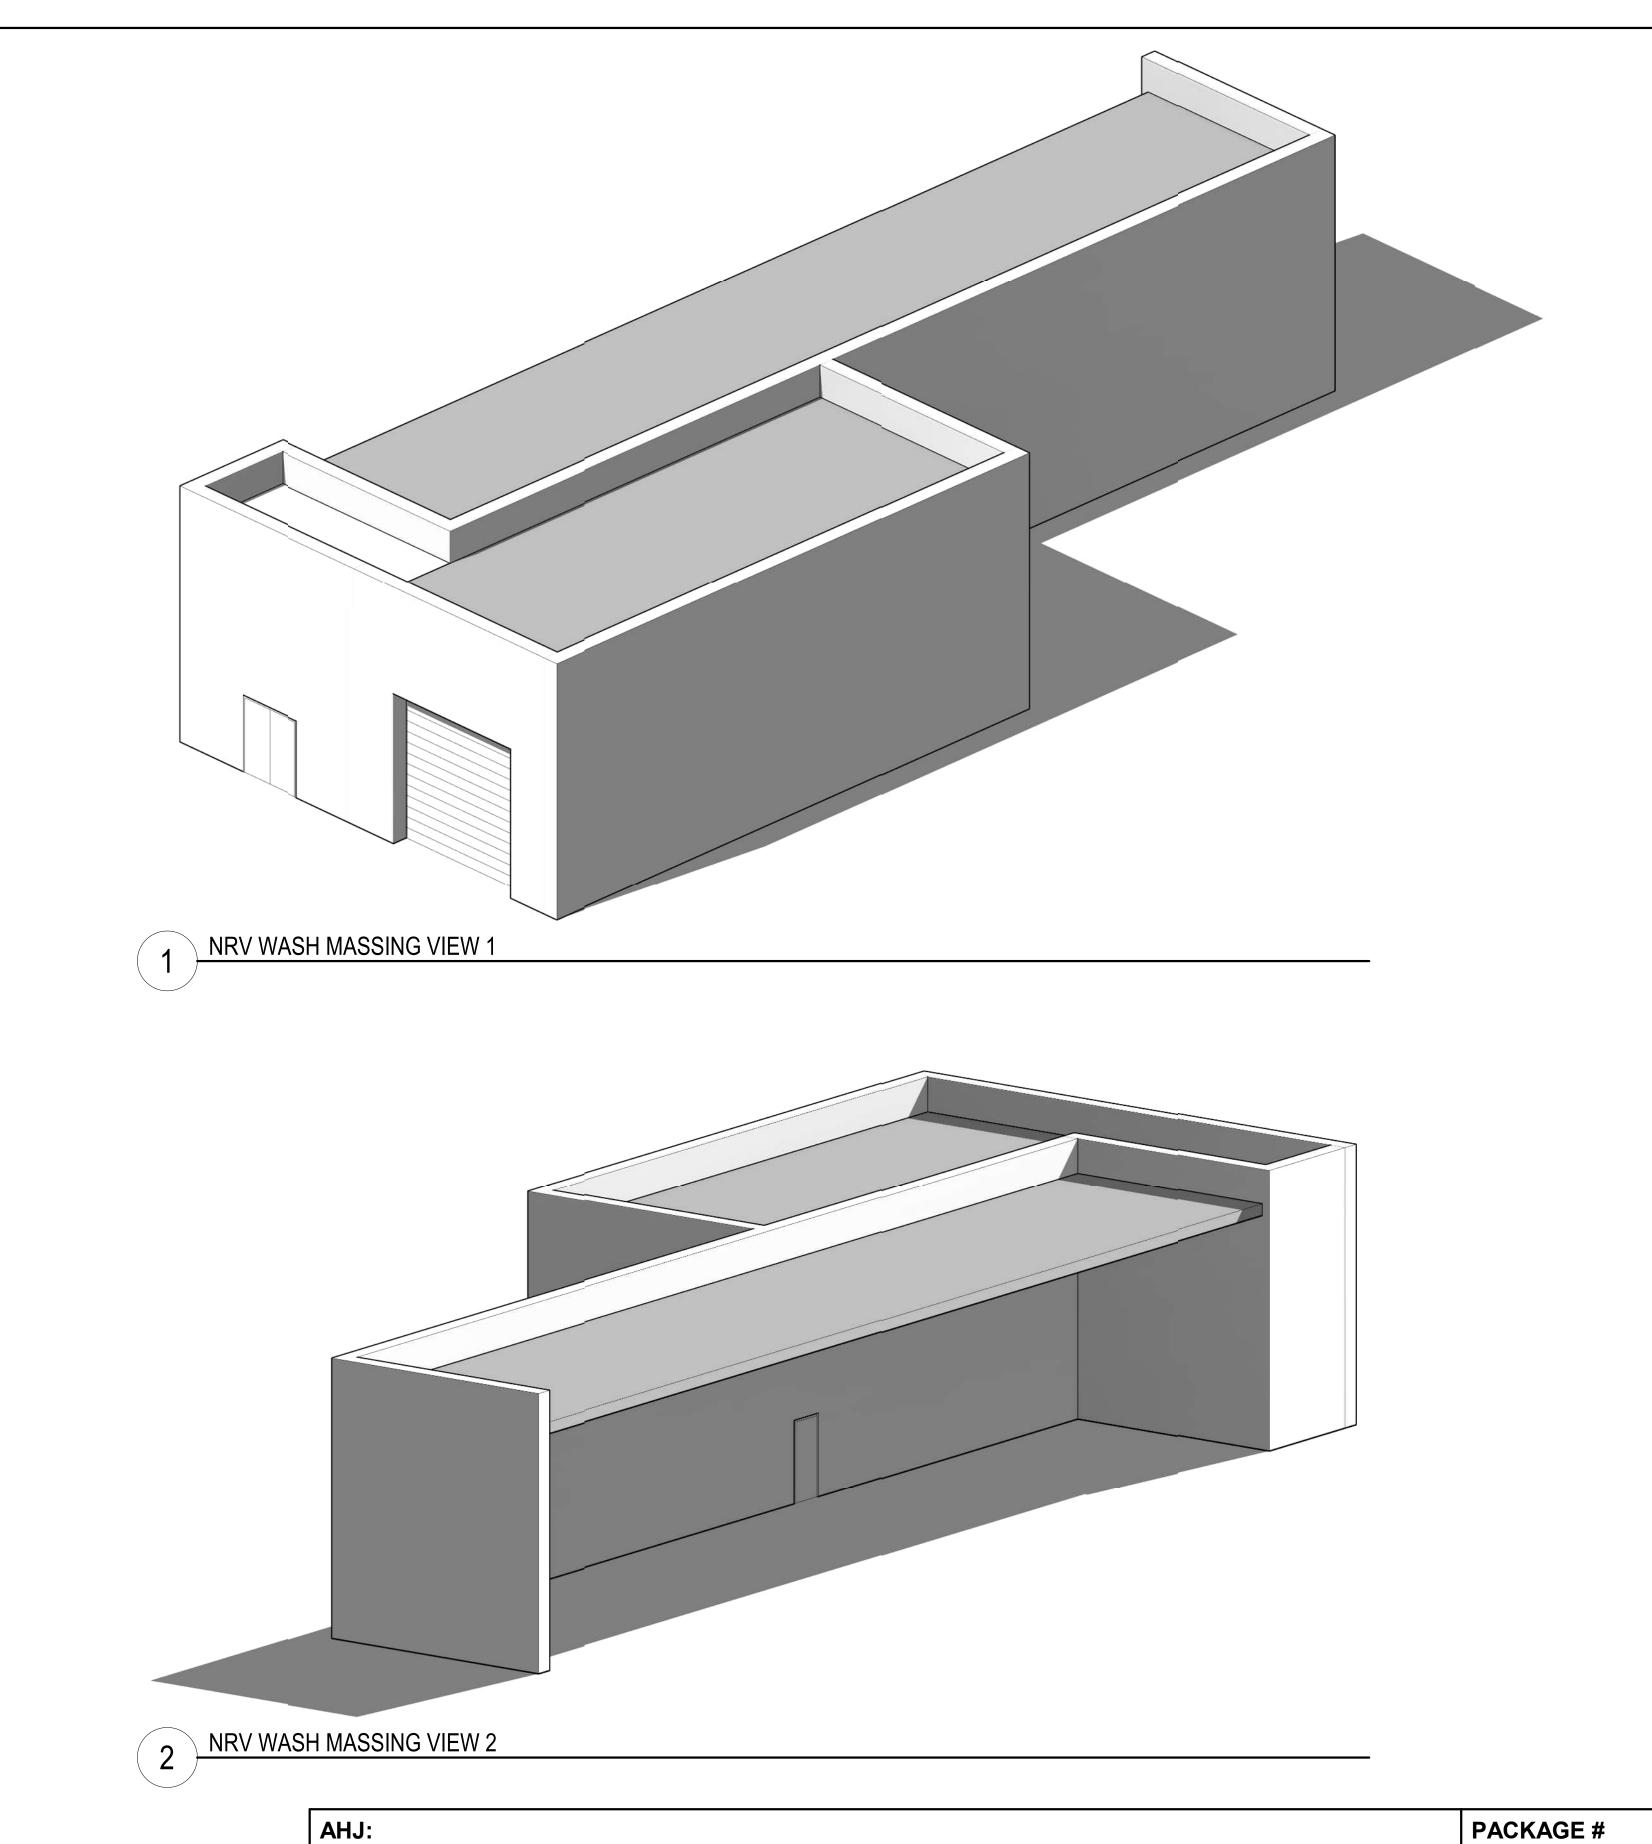

DRAWING No.:

Refer to the plan set COVER drawing for disclaimers regarding this drawing.

DESIGNED BY: REFERENCE CONCEPT DRAWINGS CHAN CHEANG DRAWN BY: STEPHANIE GREEN CHECKED BY:

9849 REGISTERED ARCHITECT CHAN LAM CHEANG STATE OF WASHINGTON

SOUNDTRANSIT CONTRACT No.:

AS NOTED FILENAME: OMFS-M09W-A-V2022.RVT AE-0030-17

SOUND TRANSIT OPERATIONS & MAINTENANCE FICILITY SOUT
VT PRELIMINARY ENGINEERING

ARCHITECTURAL MASSING VIEWS

ТН	M09W-AMP001
	FACILITY ID:
	1 10004

NRV WASH VIEWS

DONN HOGAN APPROVED BY: SHEENA ZIMMERMAN DSN CHK APP REVISION


PABLO LOPEZ-HILFIKER


2/27/2024


REVIEWED BY:


SUBMITTAL DATE: 02/27/2024


M09W SHEET No:

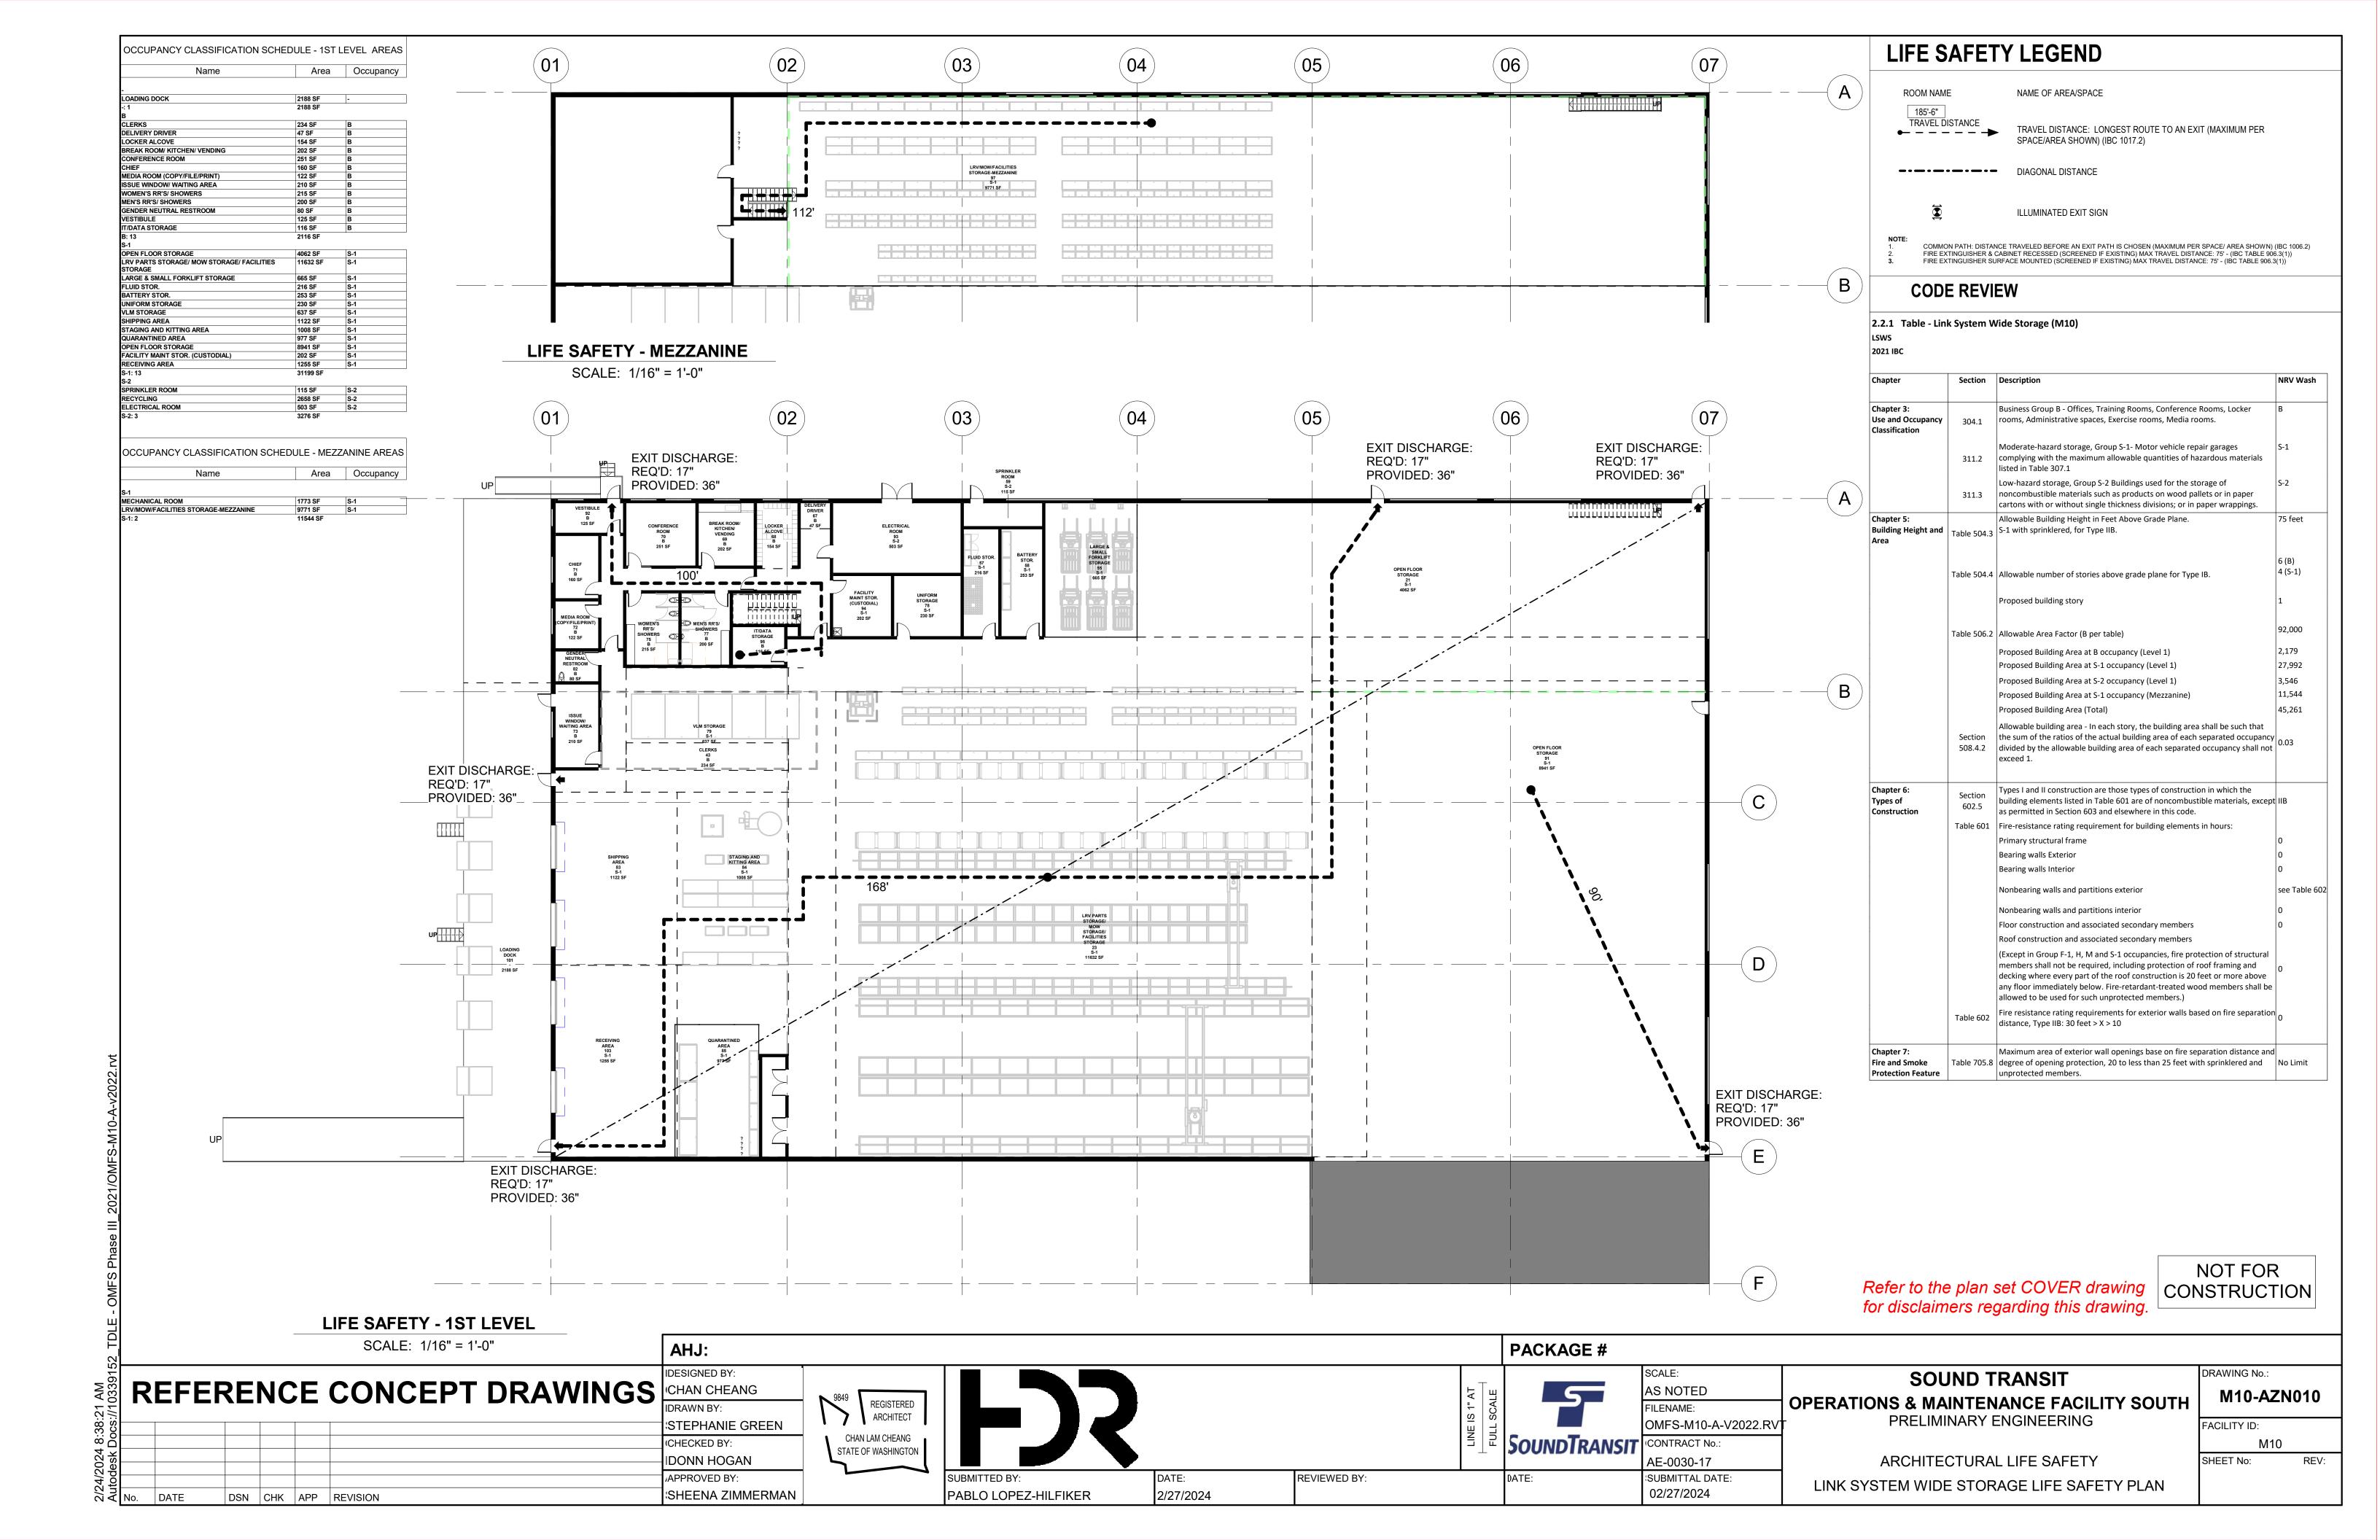


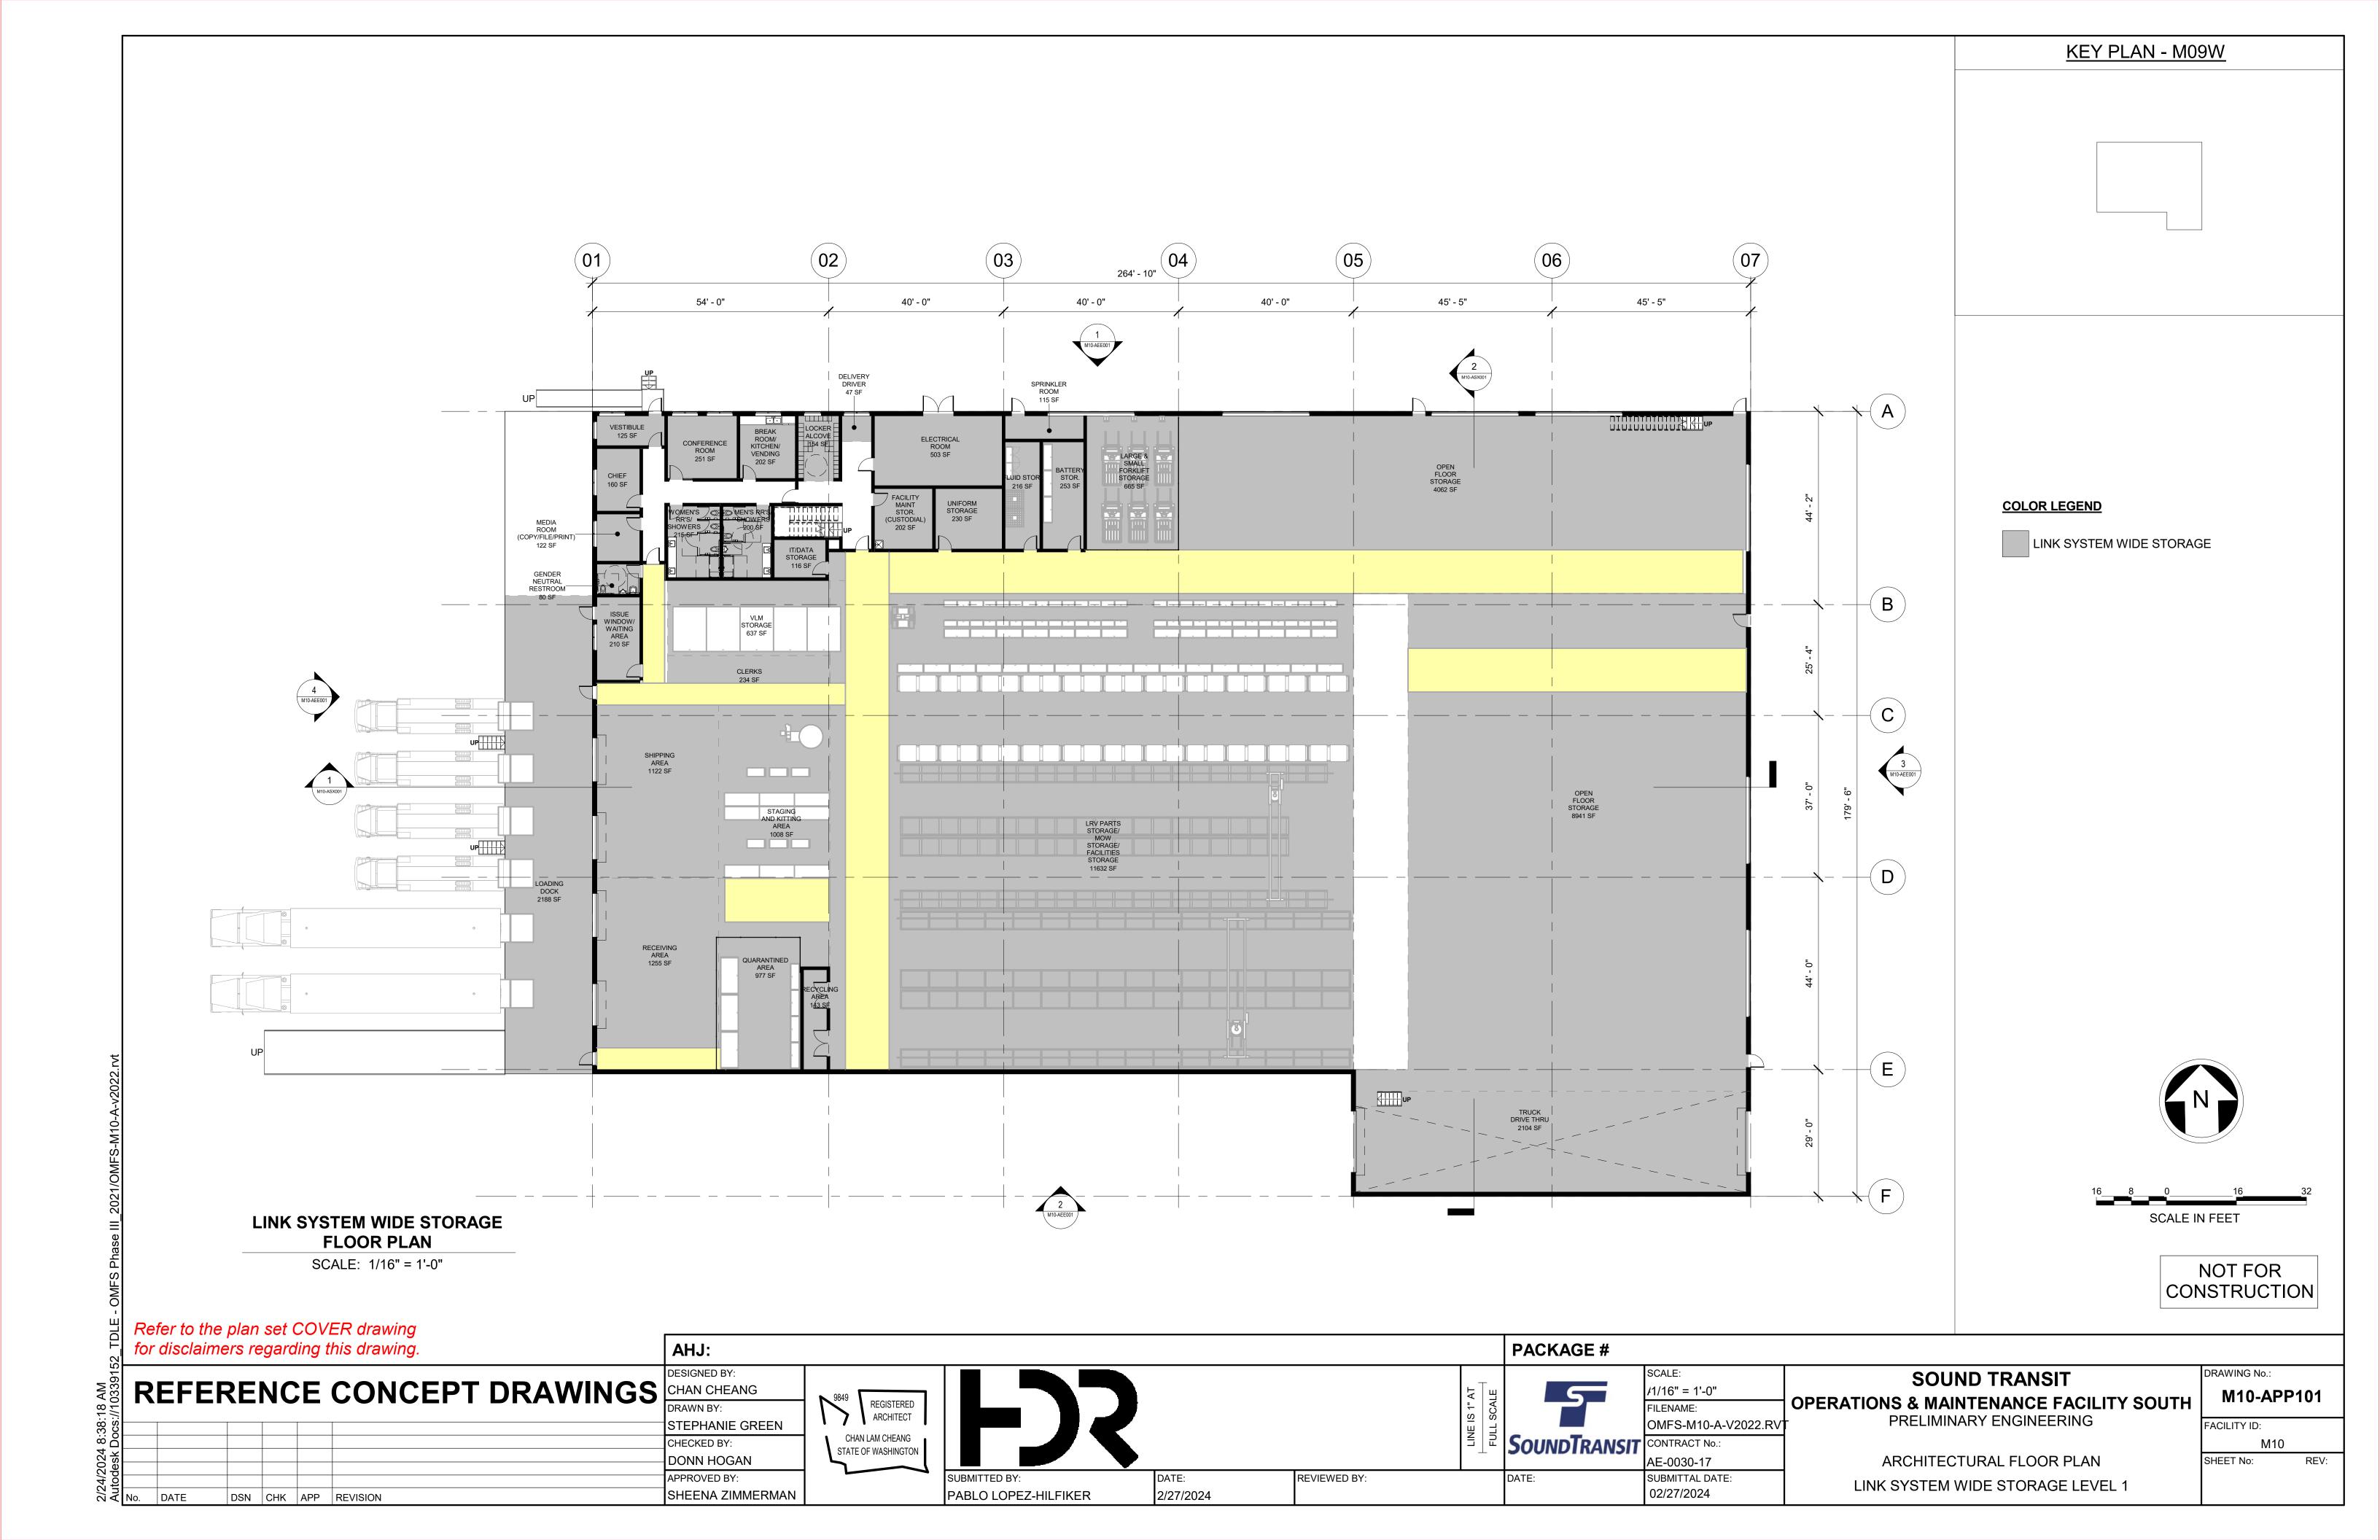


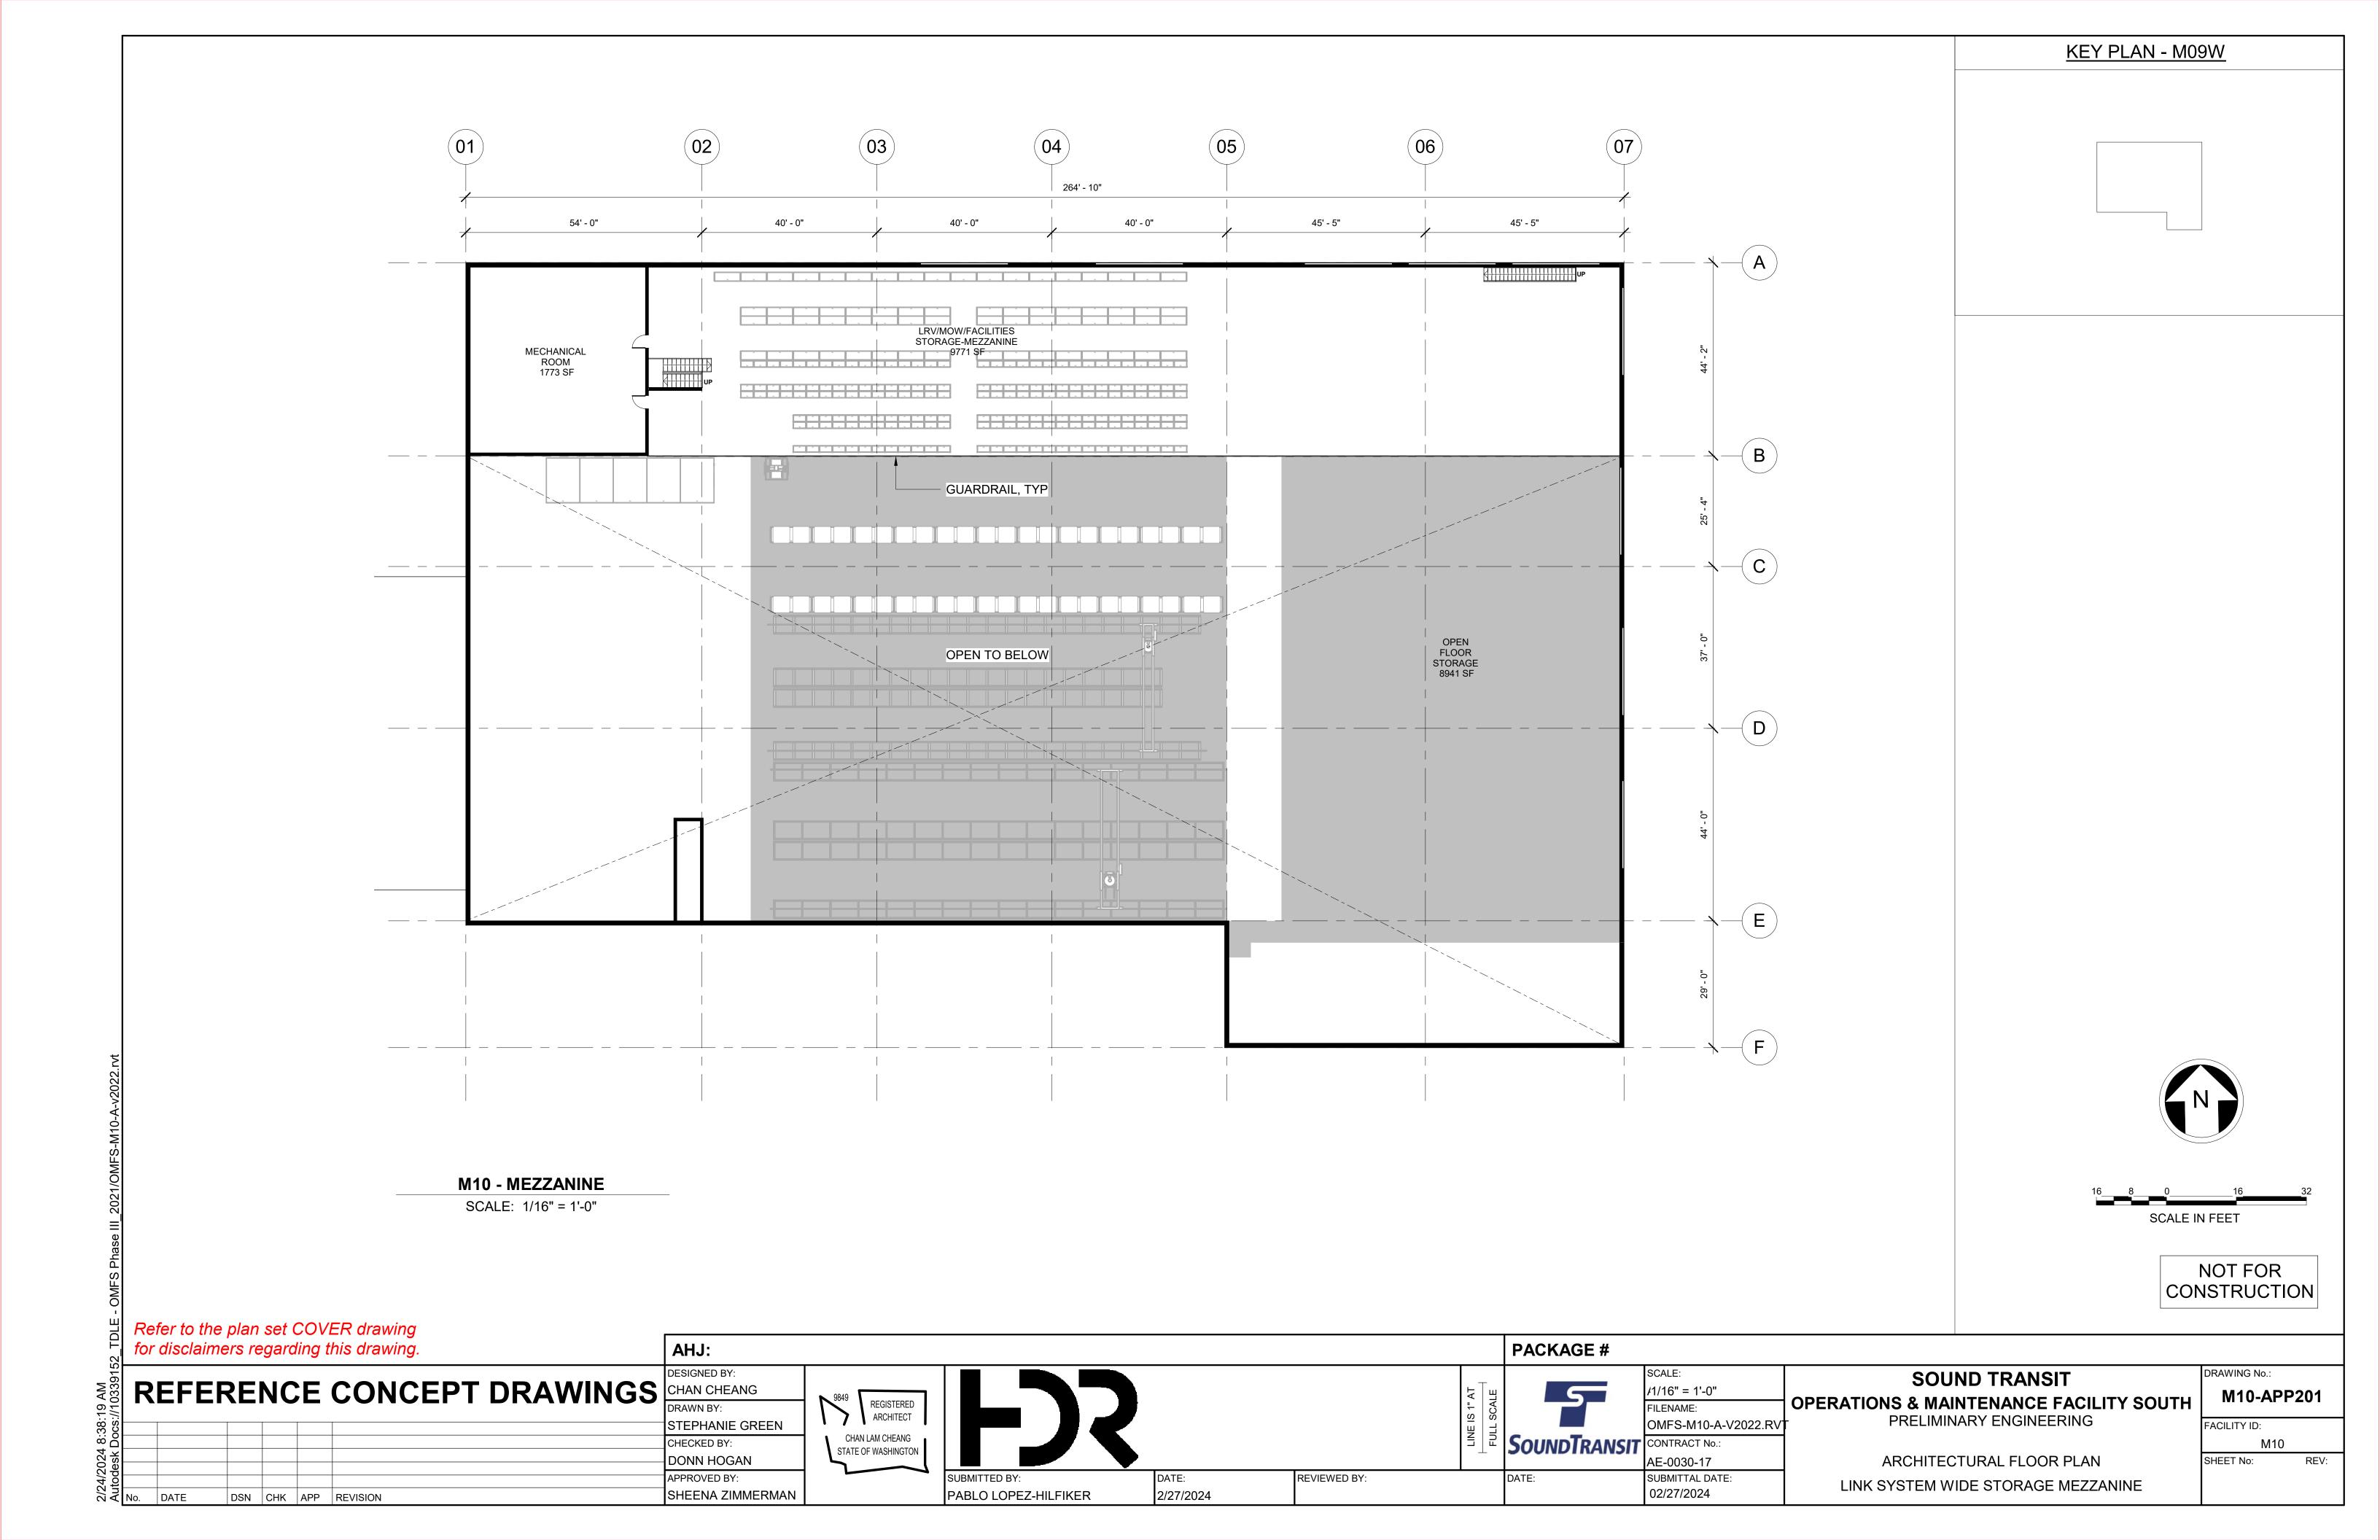

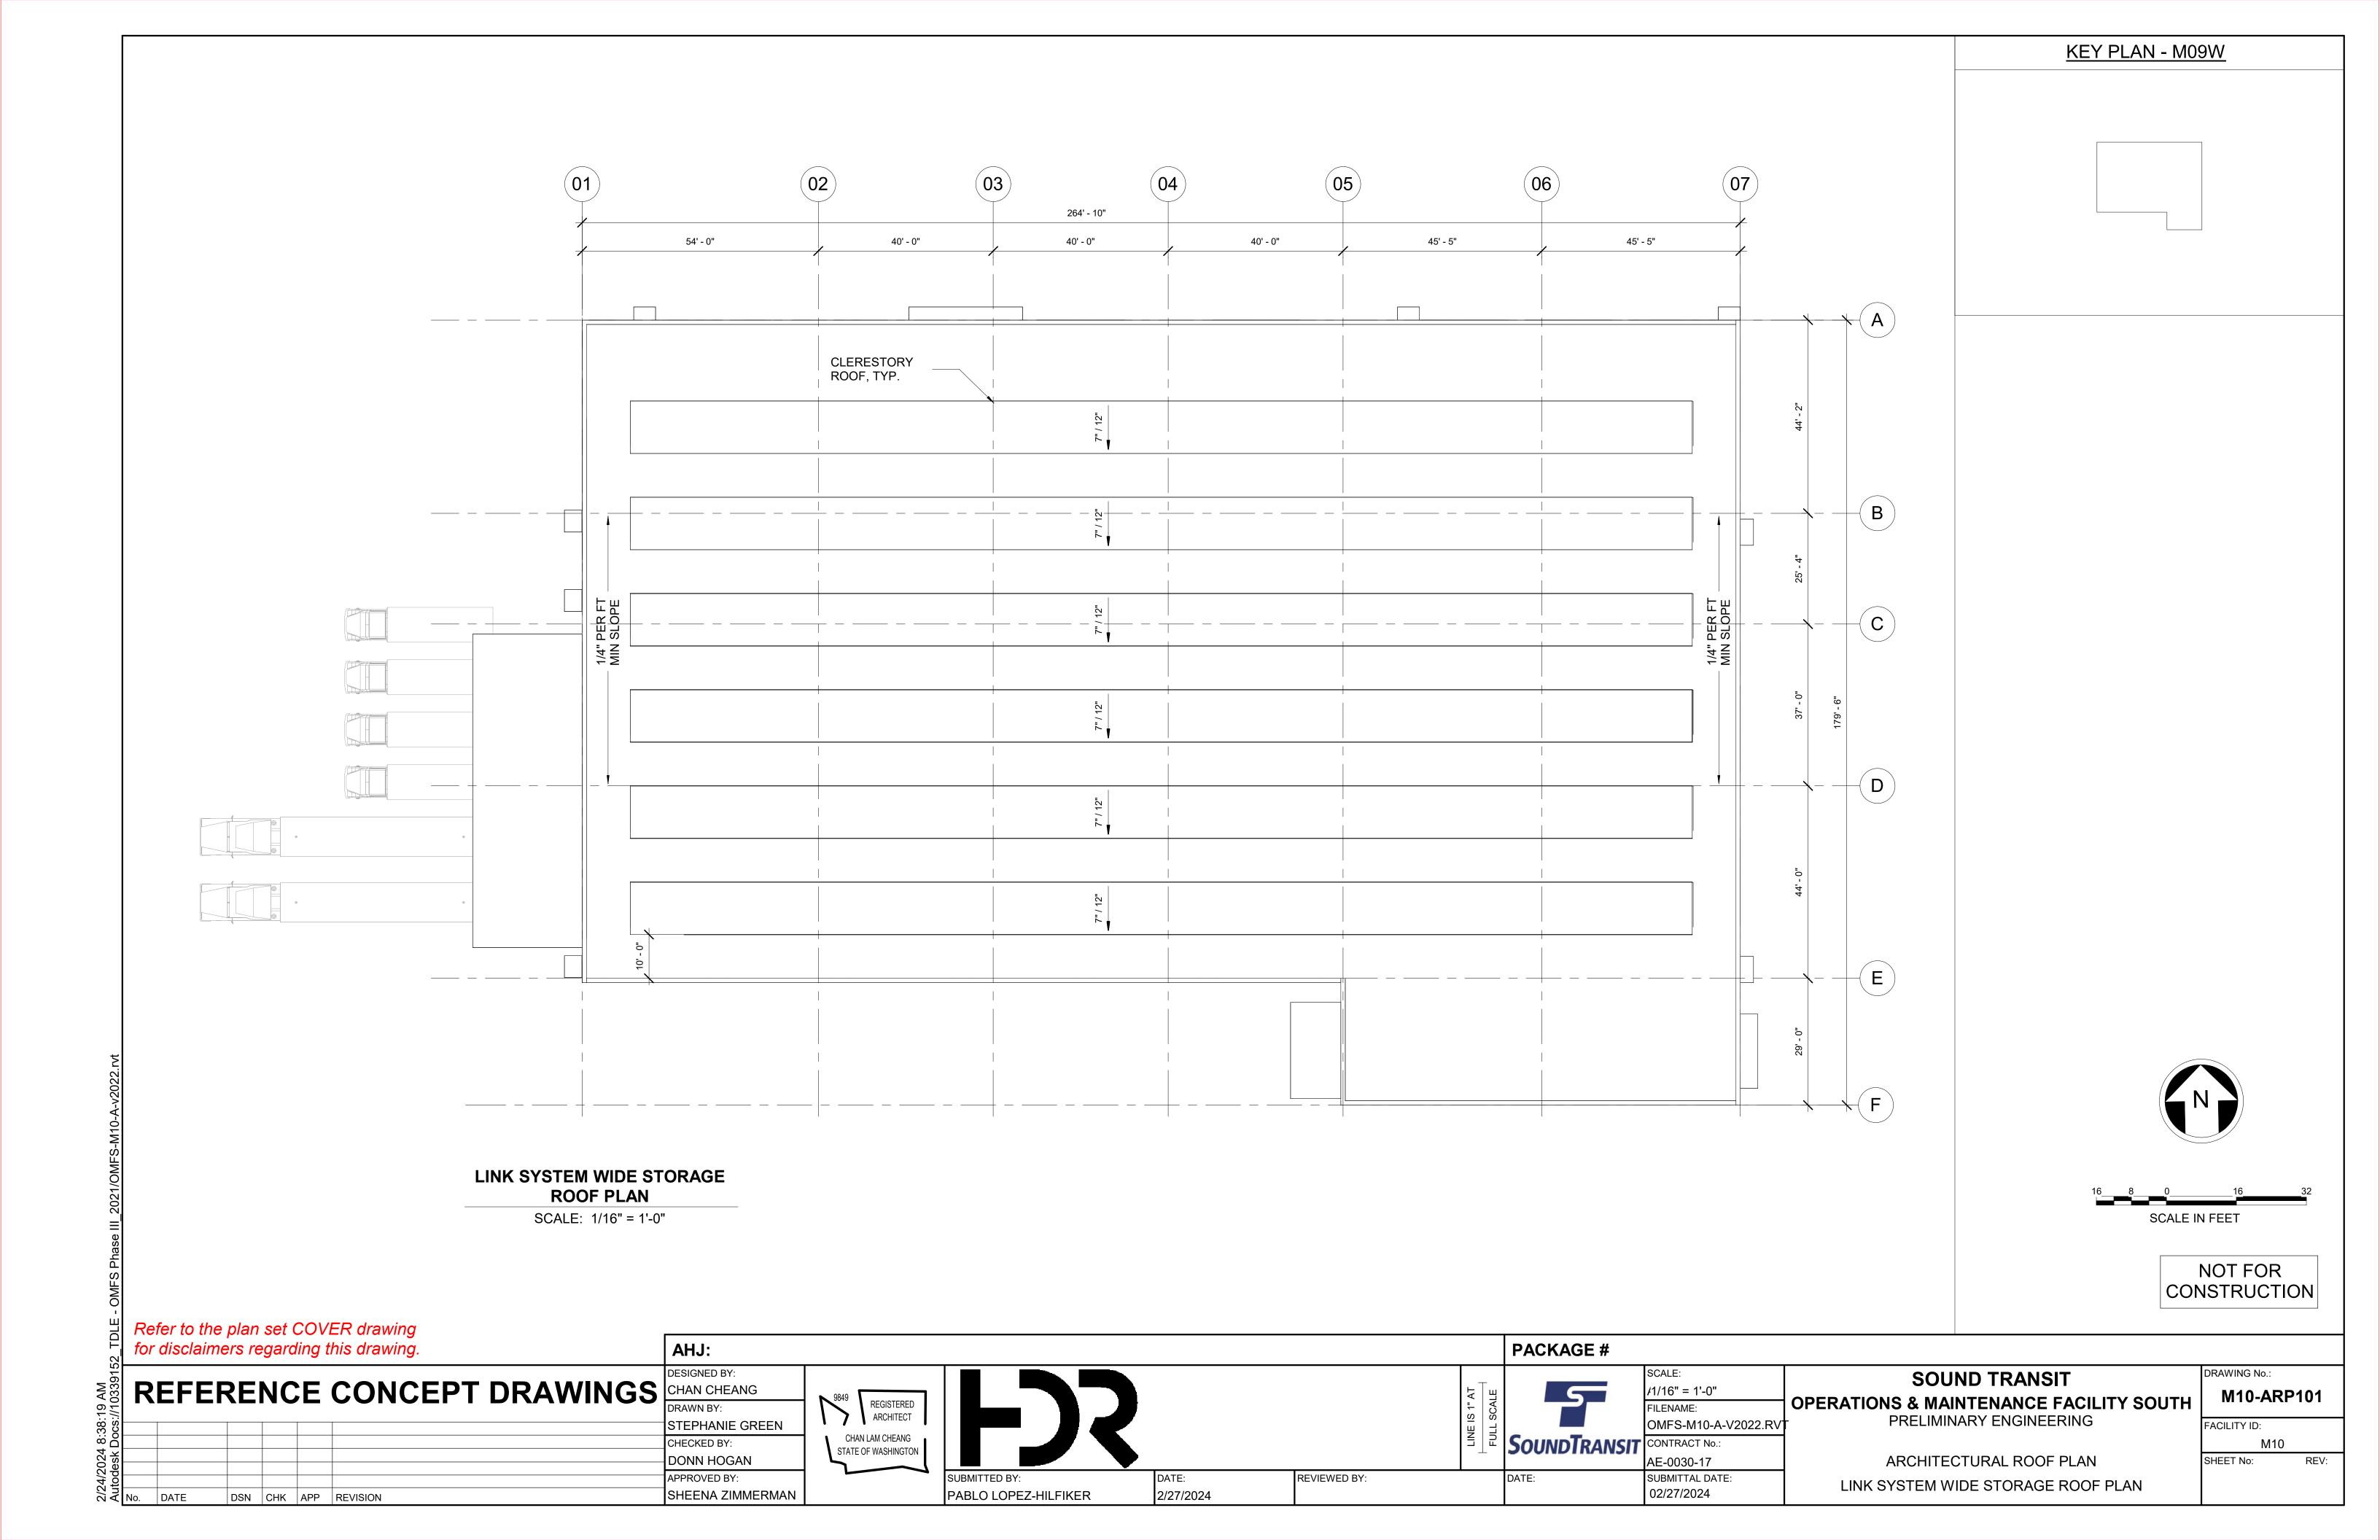

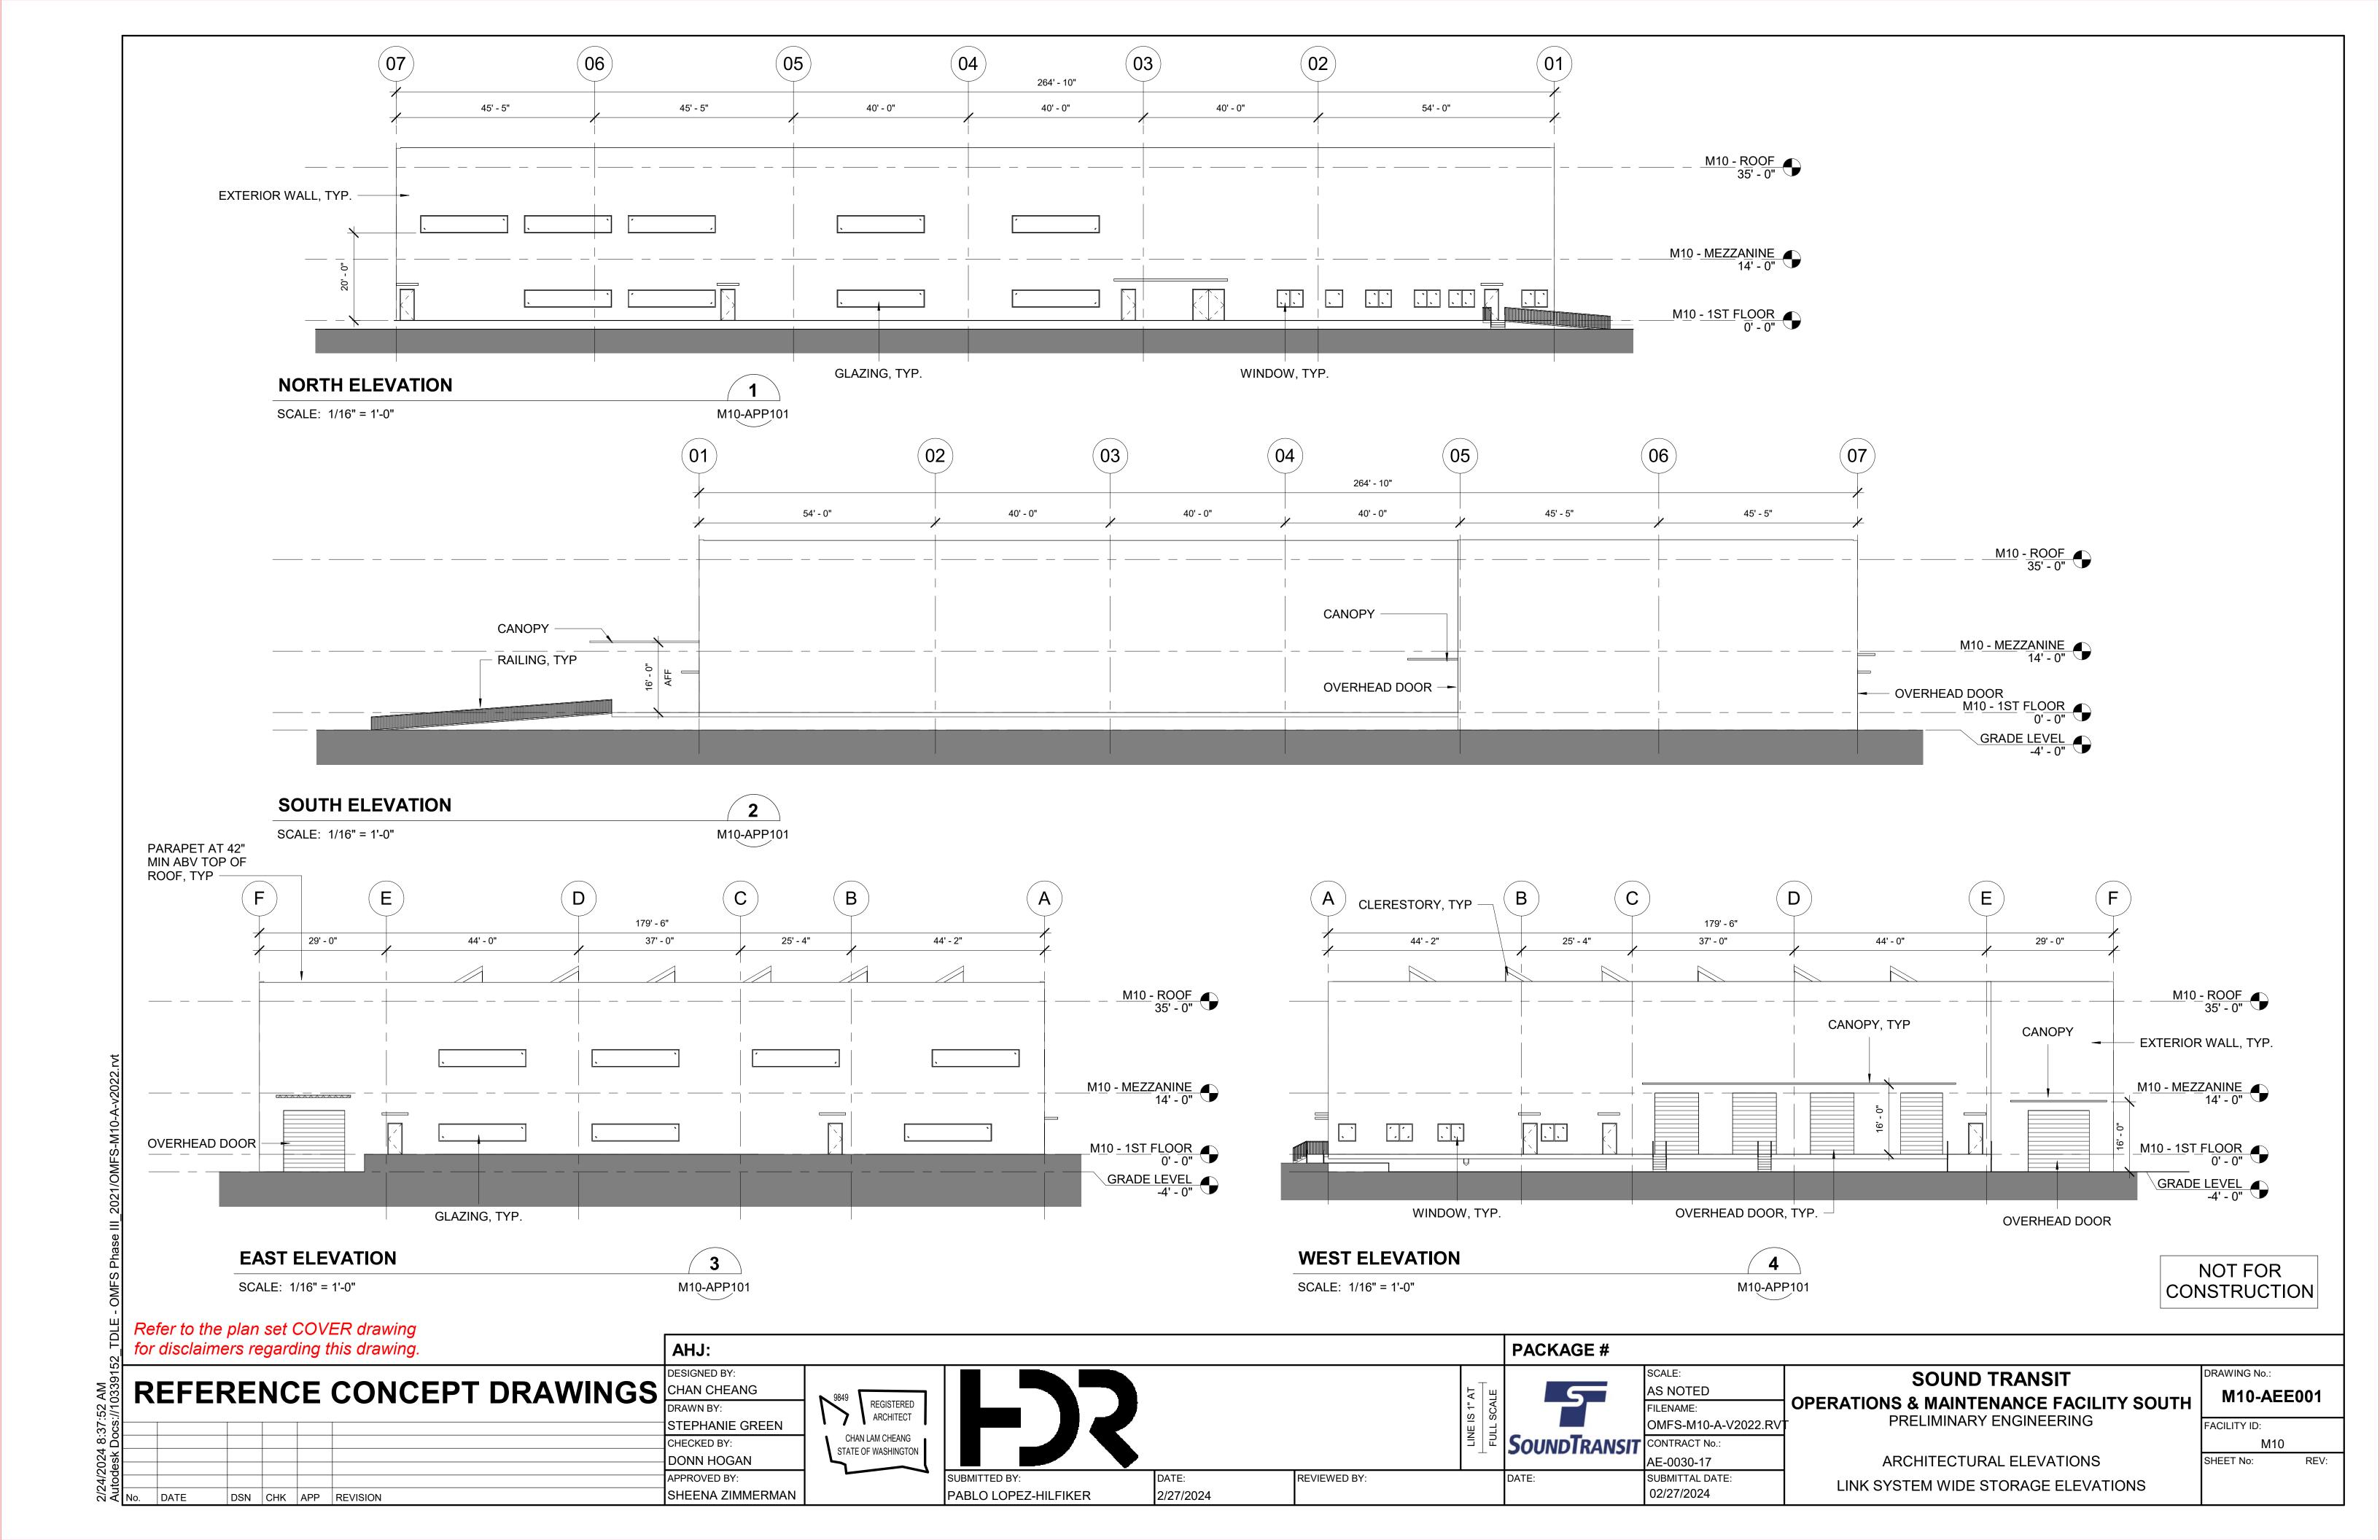


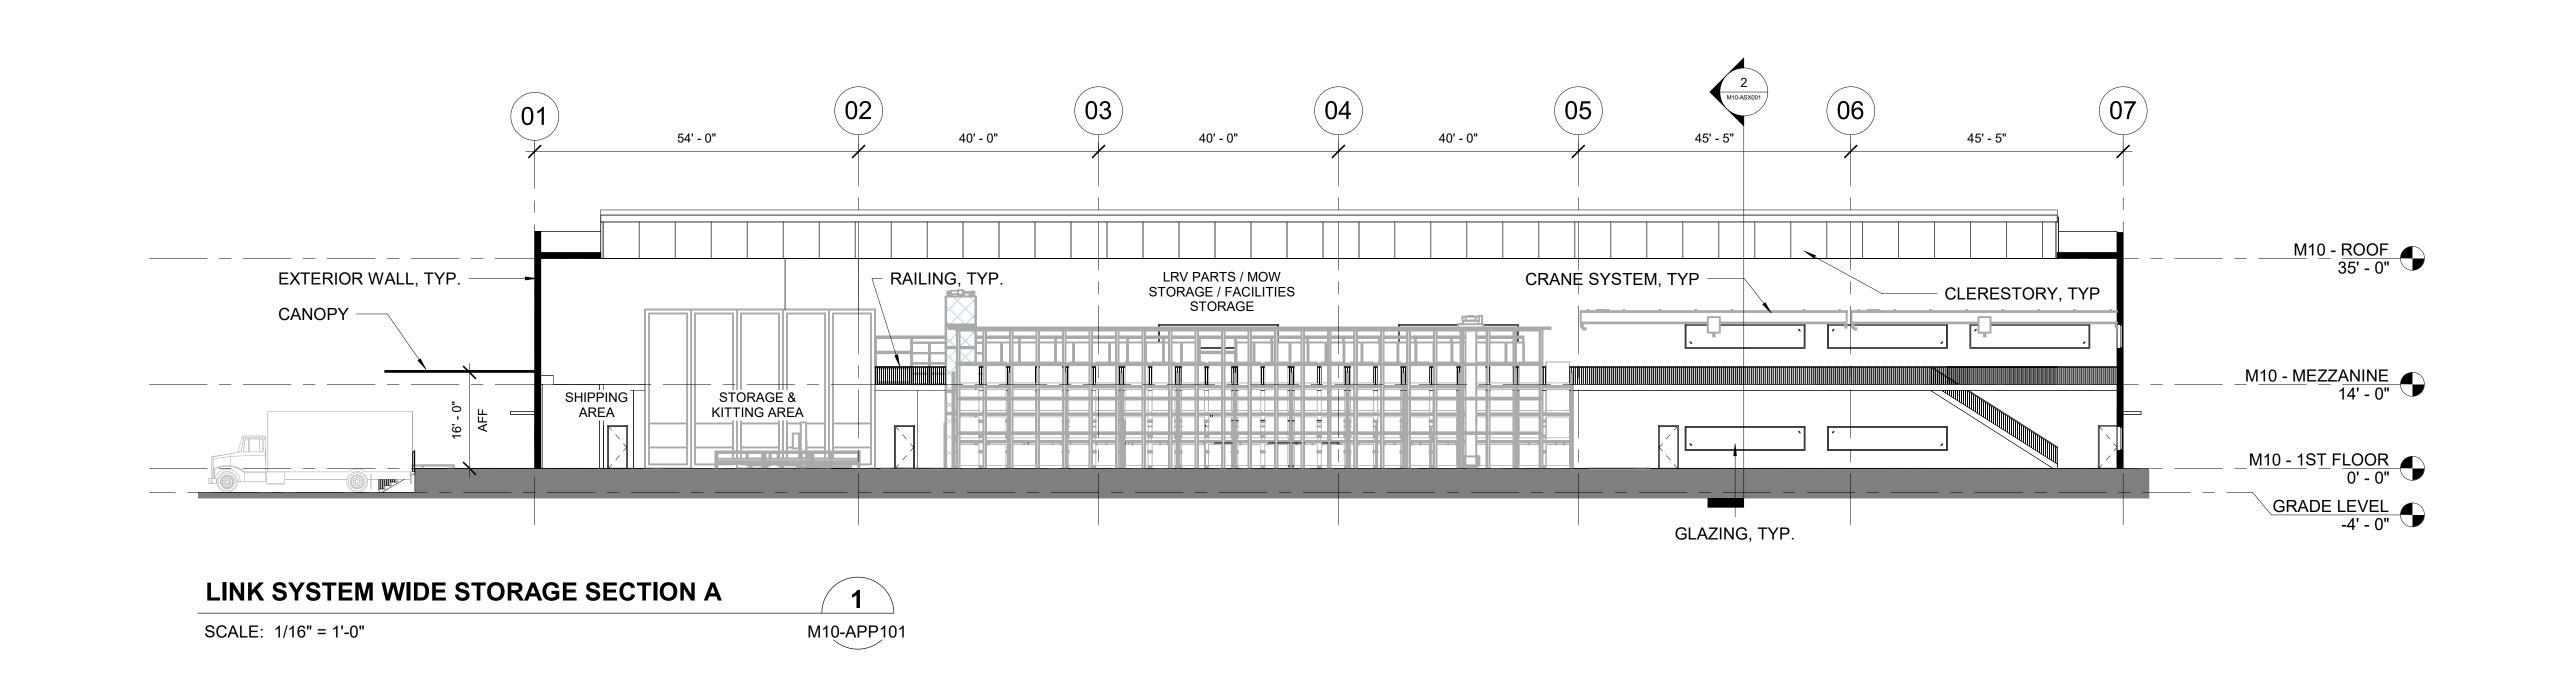

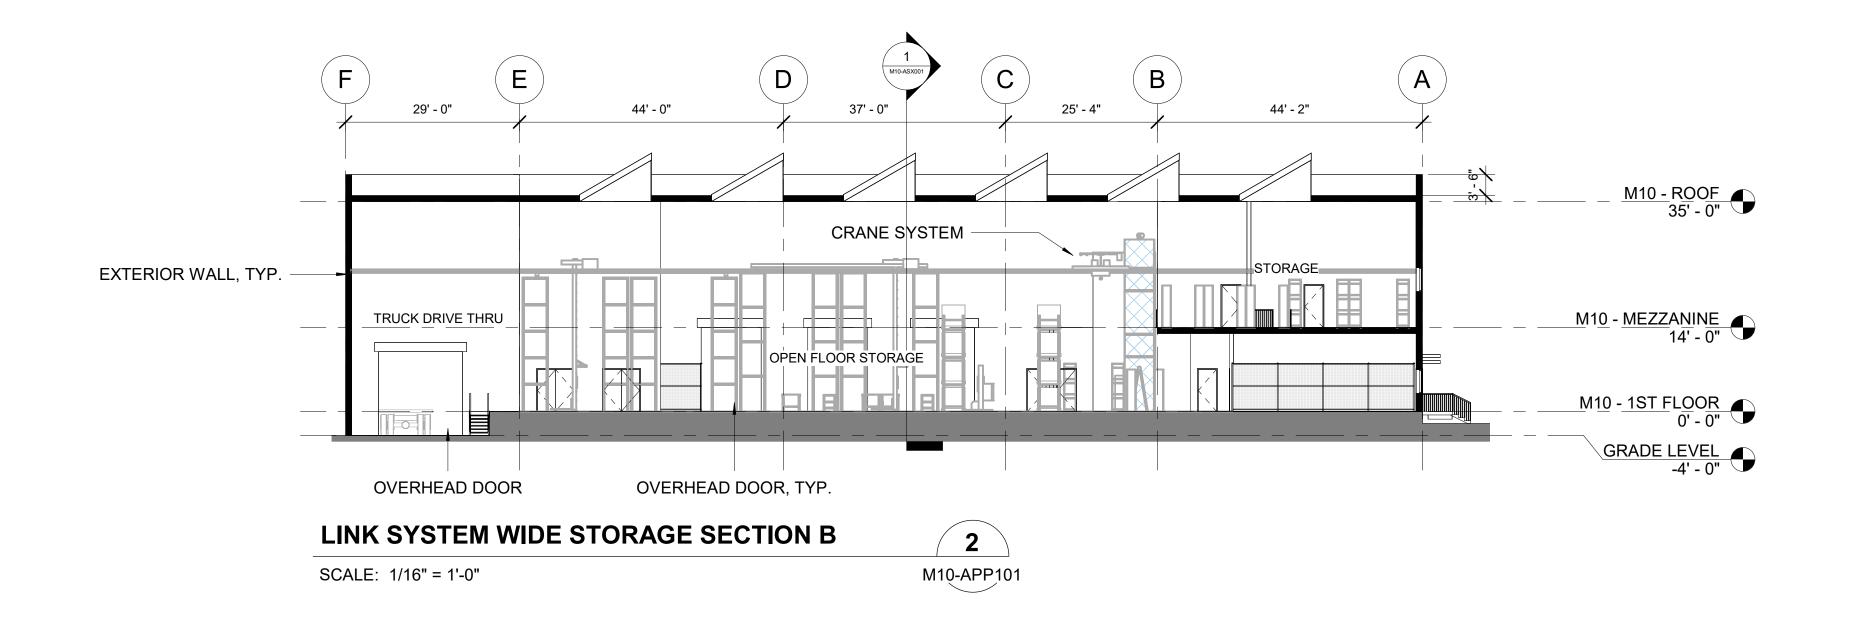

Refer to the plan set COVER drawing for disclaimers regarding this drawing. AHJ: PACKAGE # DESIGNED BY: DRAWING No.: **SOUND TRANSIT** REFERENCE CONCEPT DRAWINGS CHAN CHEANG DRAWN BY: AS NOTED M10-ASX001 9849 REGISTERED ARCHITECT **OPERATIONS & MAINTENANCE FACILITY SOUTH** FILENAME: PRELIMINARY ENGINEERING OMFS-M10-A-V2022.RV STEPHANIE GREEN FACILITY ID: CHAN LAM CHEANG STATE OF WASHINGTON SOUNDTRANSIT CONTRACT No.: CHECKED BY: M10 AE-0030-17 ARCHITECTURAL SECTIONS DONN HOGAN SHEET No: APPROVED BY: REVIEWED BY: SUBMITTAL DATE: LINK SYSTEM WIDE STORAGE SECTIONS 02/27/2024 2/27/2024 PABLO LOPEZ-HILFIKER SHEENA ZIMMERMAN DSN CHK APP REVISION

U33915Z I DLE - OMFS Phase III ZUZI/OMFS-MTU-A-VZUZZ.IVI

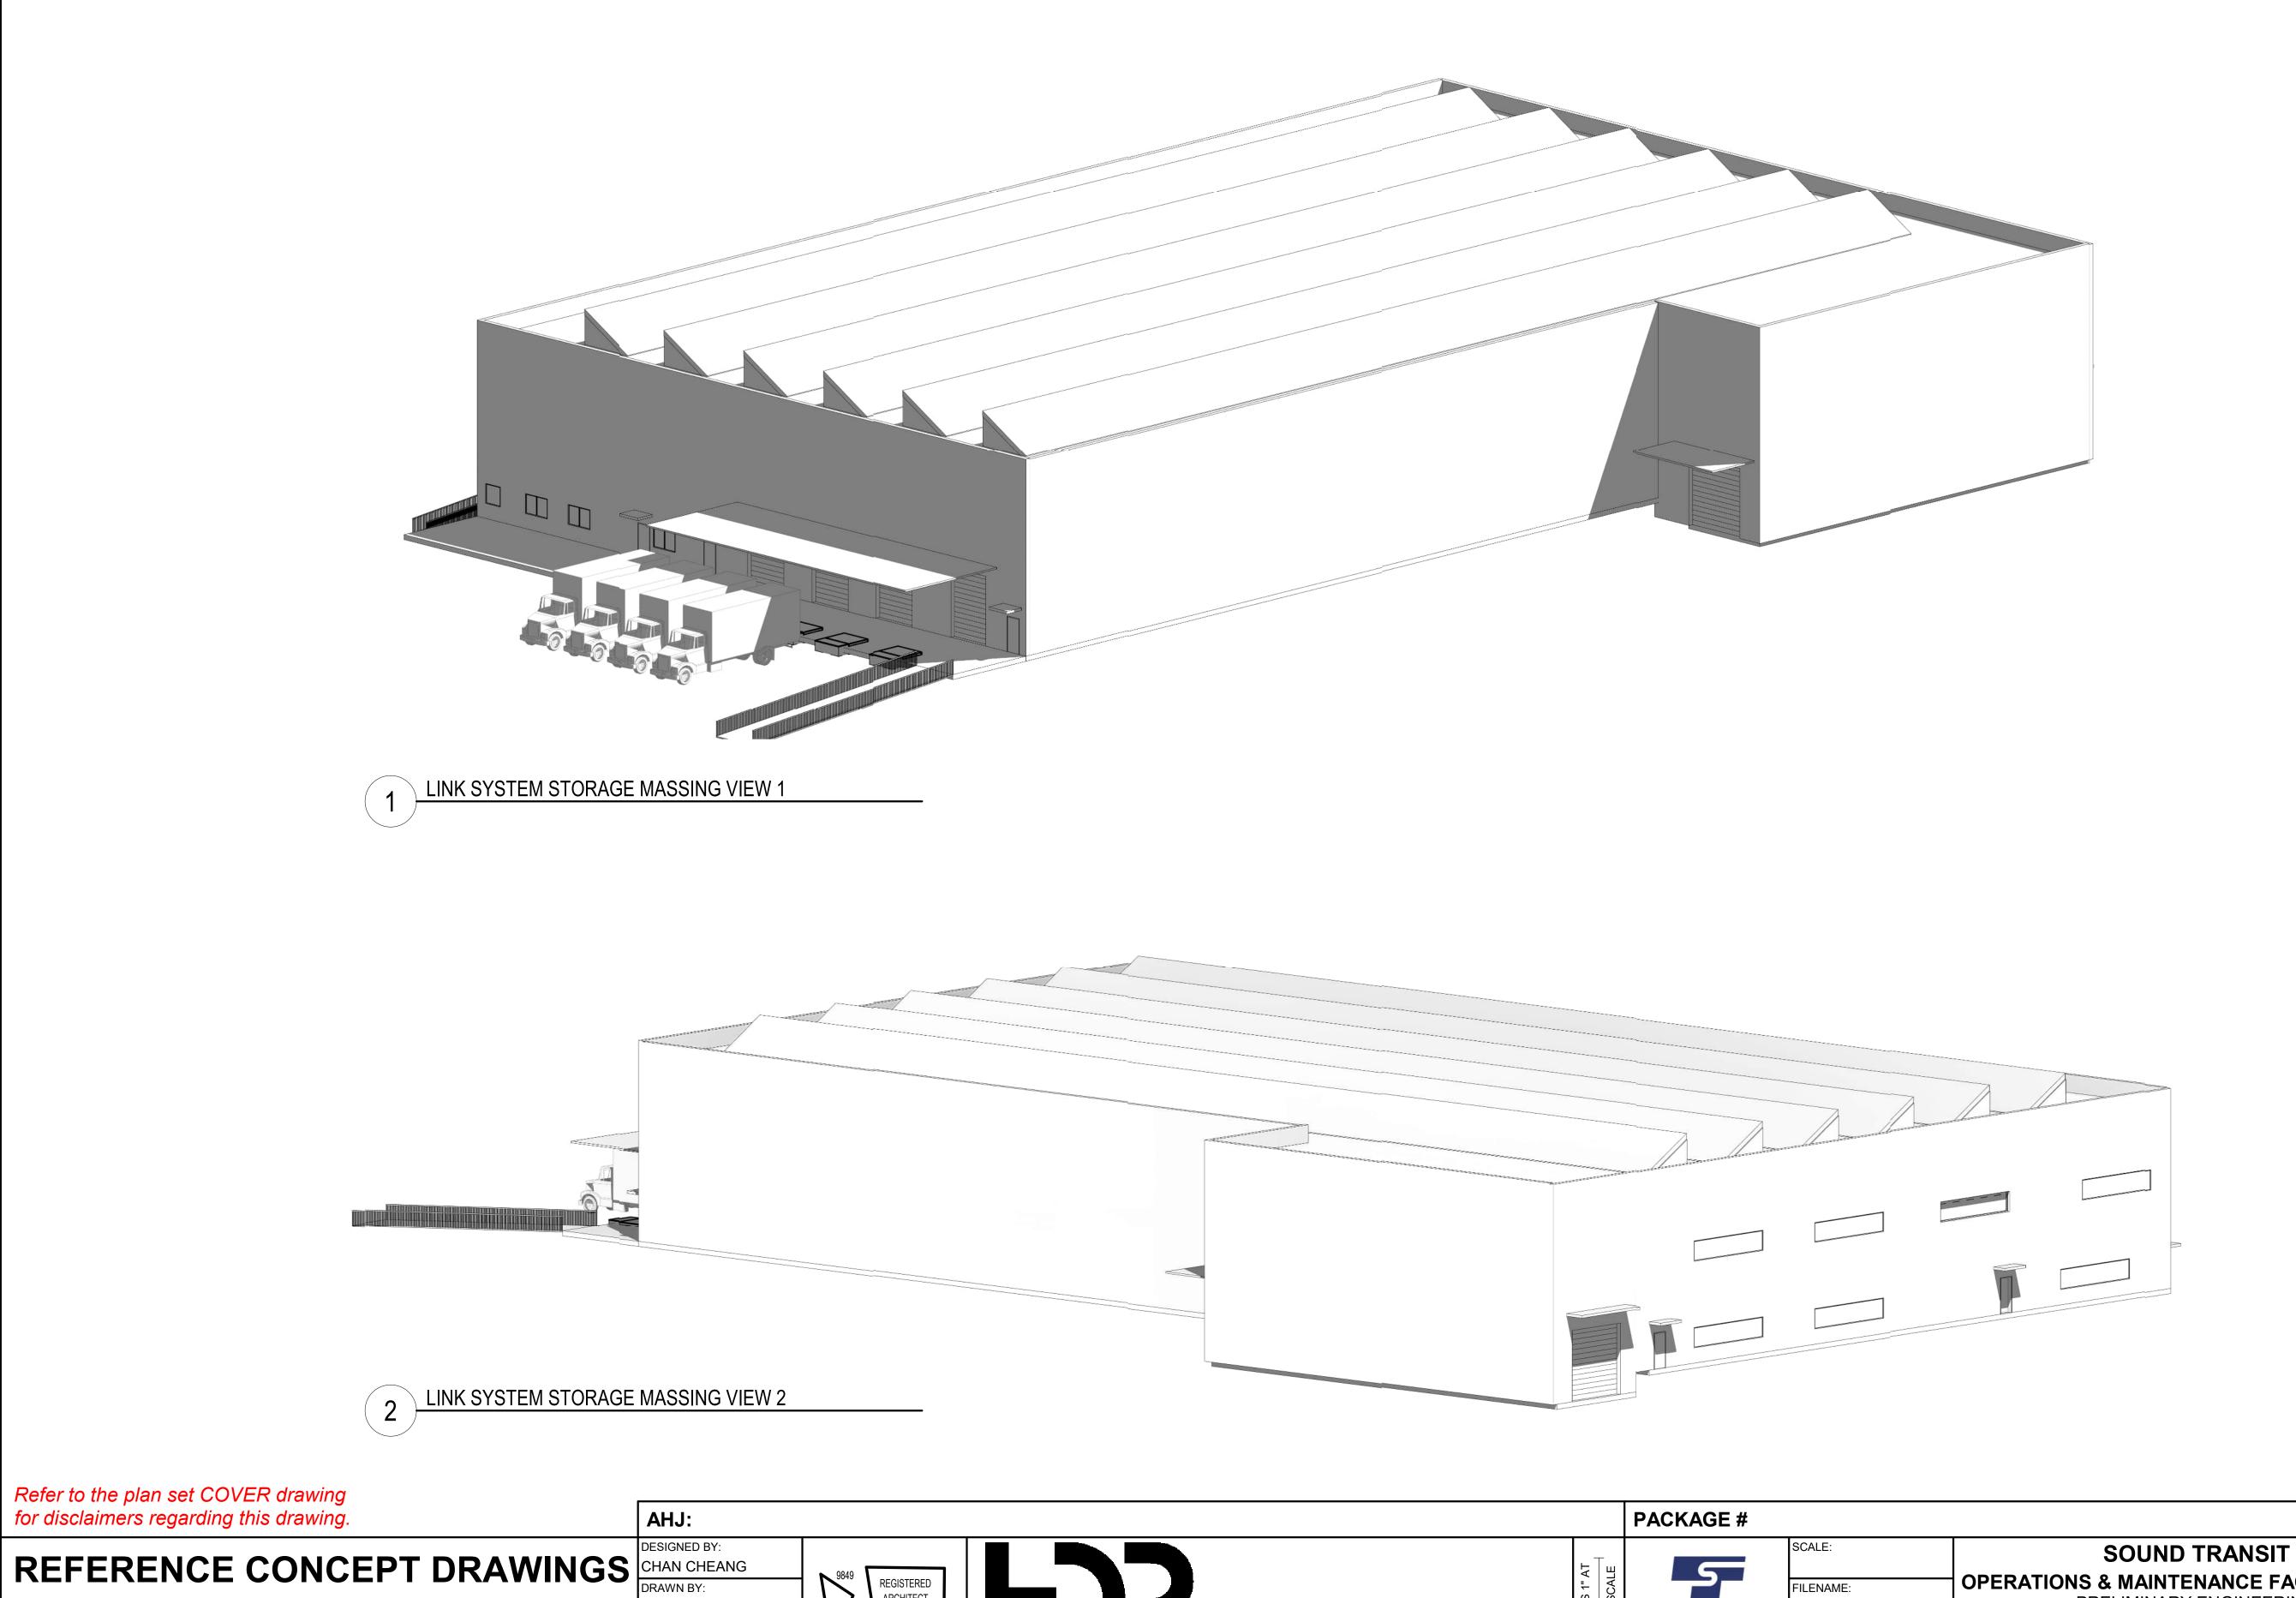

DSN CHK APP REVISION

REGISTERED ARCHITECT STEPHANIE GREEN DONN HOGAN SHEENA ZIMMERMAN

CHECKED BY:

APPROVED BY:

CHAN LAM CHEANG STATE OF WASHINGTON

PABLO LOPEZ-HILFIKER

REVIEWED BY: 2/27/2024

SOUNDTRANSIT CONTRACT No.:

OMFS-M10-A-V2022.RV AE-0030-17 SUBMITTAL DATE:

OPERATIONS & MAINTENANCE FACILITY SOUTH
PRELIMINARY ENGINEERING

ARCHITECTURAL MASSING VIEWS LINK SYSTEM WIDE STORAGE MASSING VIEWS

M10-AMP001 FACILITY ID:

NOT FOR

CONSTRUCTION

DRAWING No.:

M10 SHEET No: