



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Refer to the plan set COVER drawing
for disclaimers regarding this drawing.

REFERENCE CONCEPT DRAWINGS

No.	DATE	DSN	CHK	APP	REVISION

DESIGNED BY:	P. VIJAYASUNDARAJAN
DRAWN BY:	M. SHEPPARD
CHECKED BY:	J. HASROUNI
APPROVED BY:	J. SCHIMPF

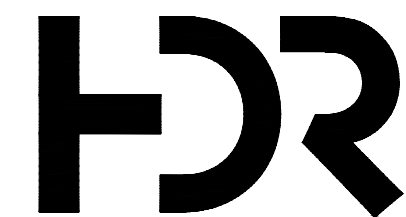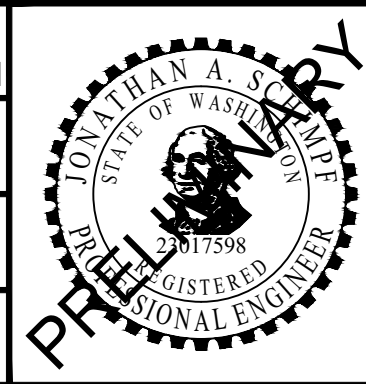


SUBMITTED BY:
PABLO LOPEZ-HILFIKER

DATE:
2/27/2024



BURNS ENGINEERING, INC. | 215.975.7700
TWO COMMERCE SQUARE, 2001 MARKET ST, SUITE 600
PHILADELPHIA, PA 19103

REVIEWED BY:

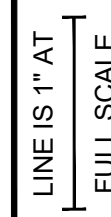

DATE:

PACKAGE

SCALE:	NTS
FILENAME:	OMFS-Y03-JTS001_002
CONTRACT No.:	AE0030-17
DATE:	

SOUND TRANSIT
PRELIMINARY ENGINEERING PLANS
OPERATIONS & MAINTENACE FACILITY SOUTH

TRACTION POWER SYSTEM
YARD TPSS METERING & RELAYING
SINGLE LINE DIAGRAM (SHEET 2 OF 2)


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FACILITY ID:	Y03
SHEET No.:	REV:
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PRELIMINARY
ENGINEERING

NOT FOR
CONSTRUCTION

FOR CONTINUATION
SEE MATCHLINE 'A' DWG Y03-JTS001

FOR CONTINUATION
SEE MATCHLINE 'B' DWG Y03-JTS001

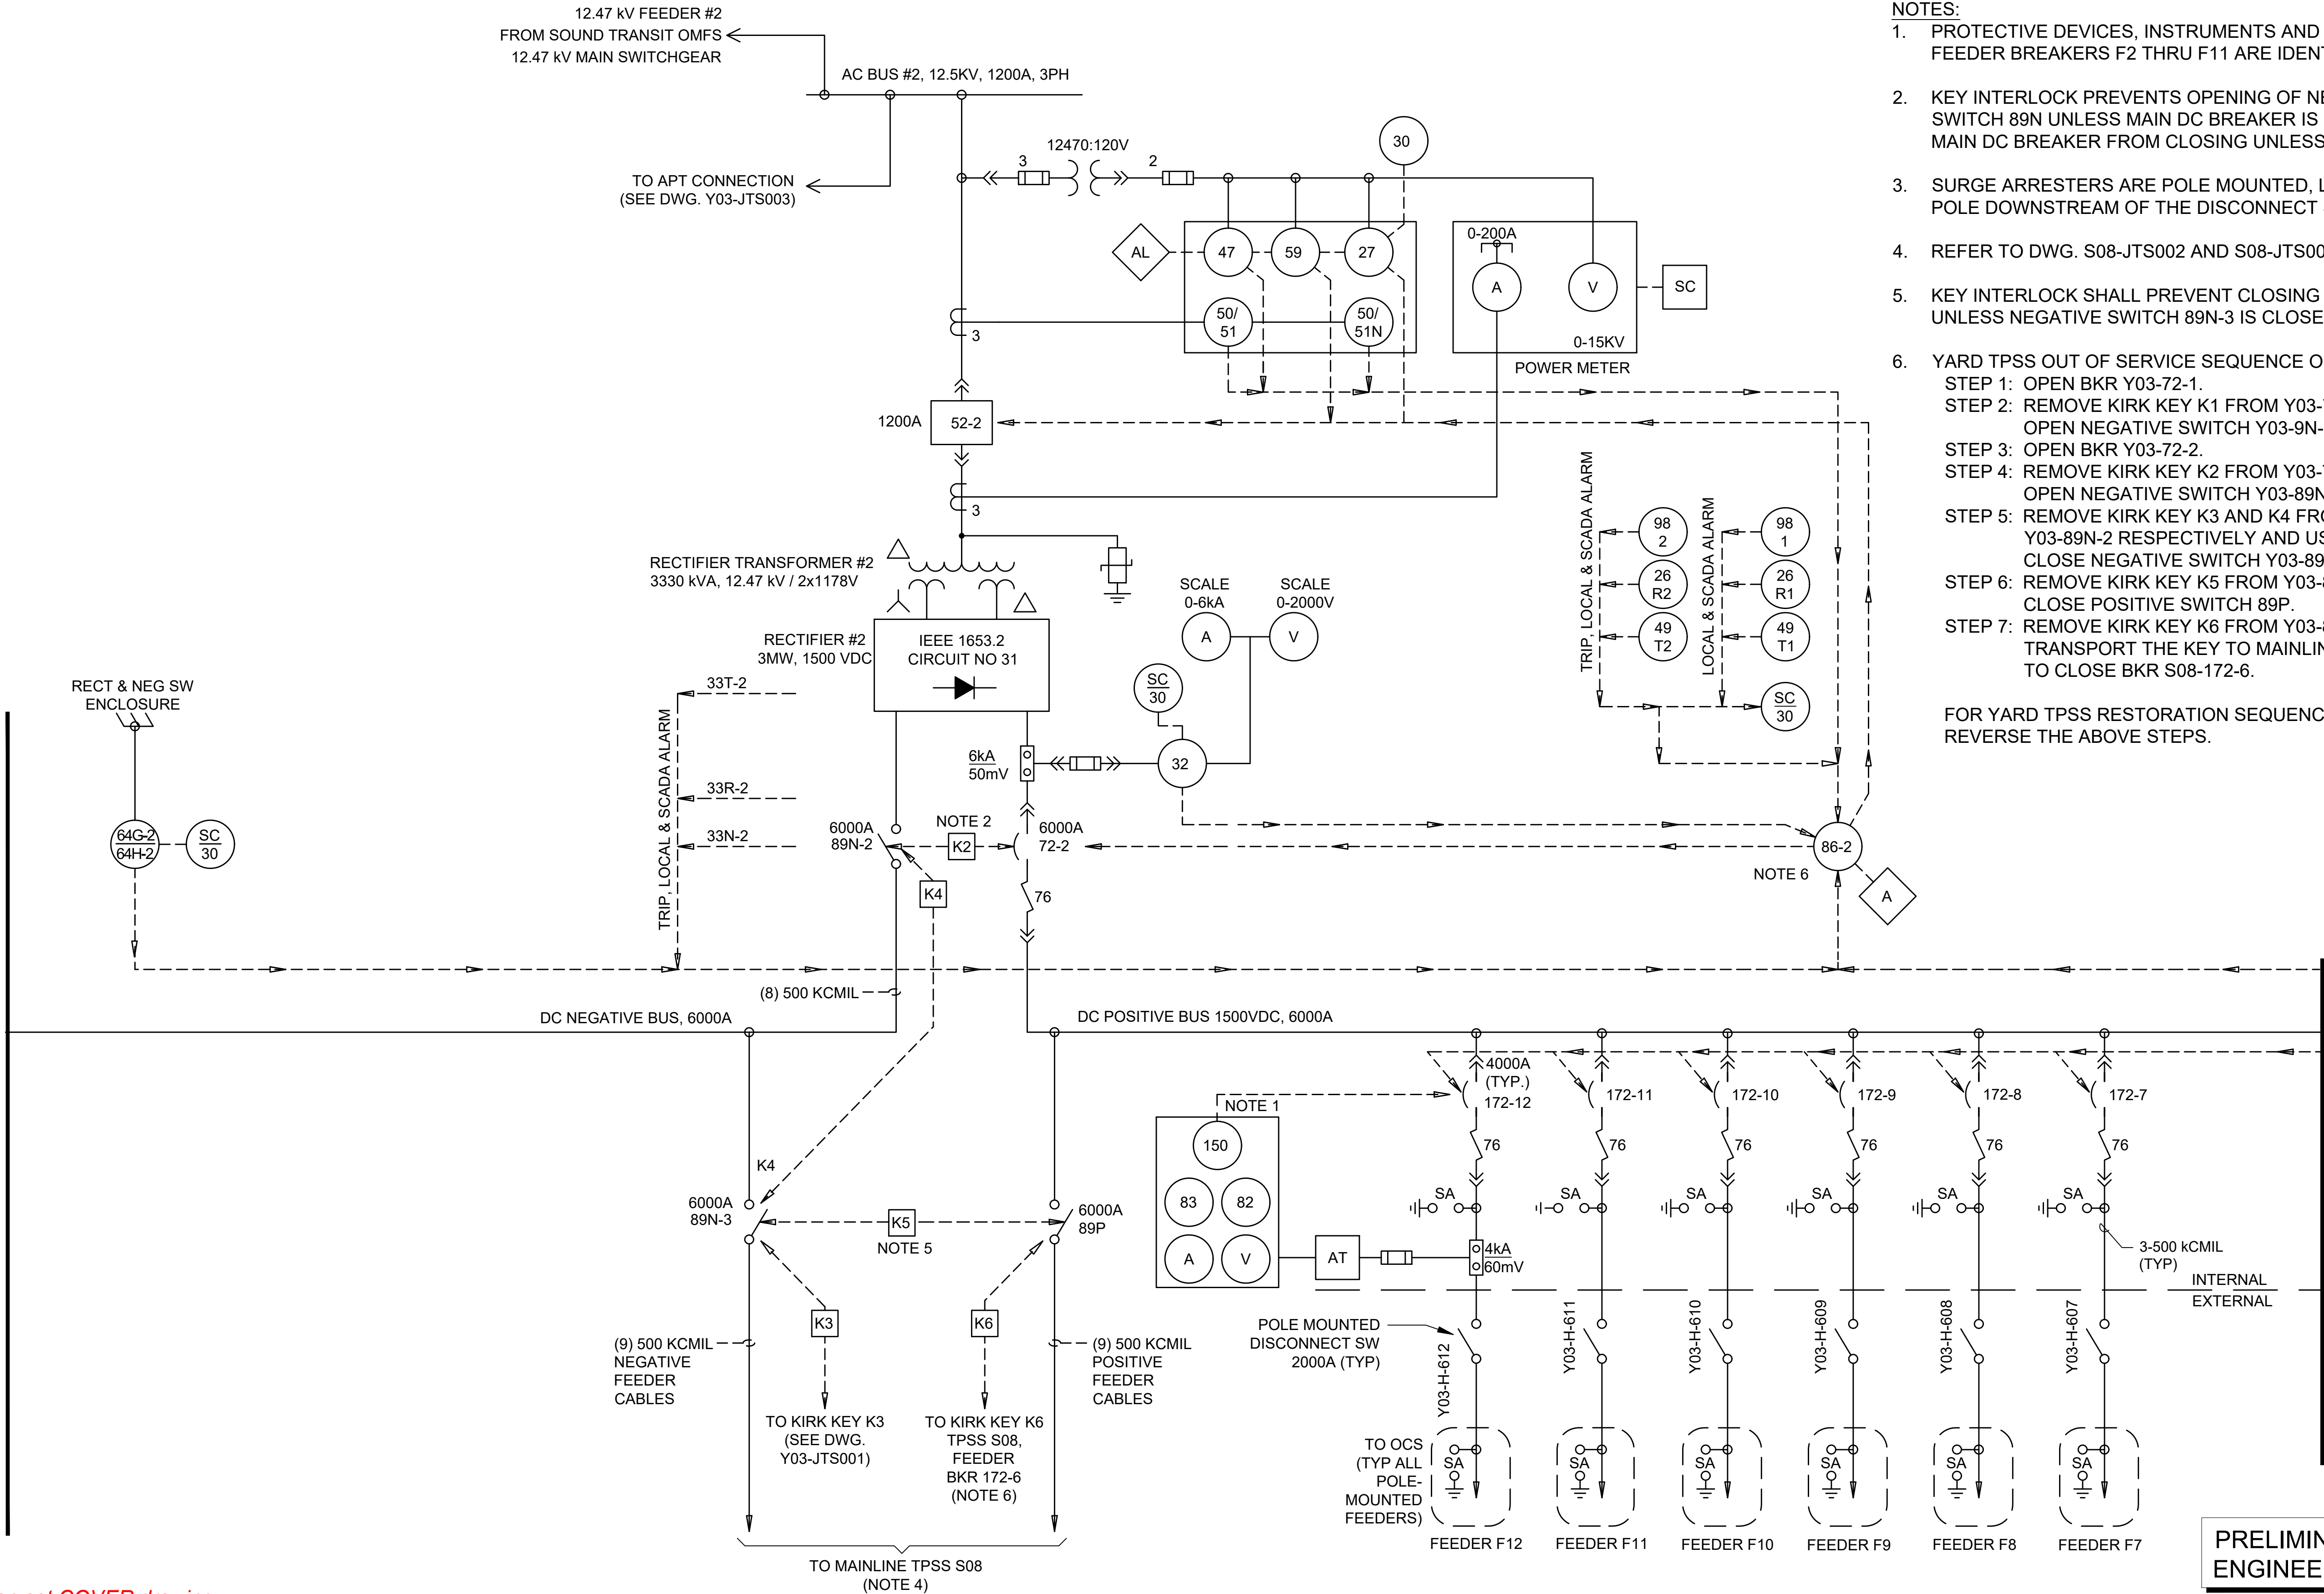


NOTES:

- PROTECTIVE DEVICES, INSTRUMENTS AND INTERLOCKS FOR FEEDER BREAKERS F2 THRU F11 ARE IDENTICAL TO FEEDER 1.
- KEY INTERLOCK PREVENTS OPENING OF NEGATIVE DISCONNECT SWITCH 89N UNLESS MAIN DC BREAKER IS OPEN AND PREVENTS MAIN DC BREAKER FROM CLOSING UNLESS 89N IS CLOSED.
- SURGE ARRESTERS ARE POLE MOUNTED, LOCATED ON THE FIRST POLE DOWNSTREAM OF THE DISCONNECT SWITCH.
- REFER TO DWG. S08-JTS002 AND S08-JTS003.
- KEY INTERLOCK SHALL PREVENT CLOSING POSITIVE SWITCH 89P UNLESS NEGATIVE SWITCH 89N-3 IS CLOSED.
- YARD TPSS OUT OF SERVICE SEQUENCE OF OPERATIONS:
STEP 1: OPEN BKR Y03-72-1.
STEP 2: REMOVE KIRK KEY K1 FROM Y03-72-1 AND USE KEY TO OPEN NEGATIVE SWITCH Y03-9N-1.
STEP 3: OPEN BKR Y03-72-2.
STEP 4: REMOVE KIRK KEY K2 FROM Y03-72-2 AND USE KEY TO OPEN NEGATIVE SWITCH Y03-89N-2.
STEP 5: REMOVE KIRK KEY K3 AND K4 FROM Y03-89N-1 AND Y03-89N-2 RESPECTIVELY AND USE BOTH KEYS TO CLOSE NEGATIVE SWITCH Y03-89N-3.
STEP 6: REMOVE KIRK KEY K5 FROM Y03-89N-3 AND USE KEY TO CLOSE POSITIVE SWITCH 89P.
STEP 7: REMOVE KIRK KEY K6 FROM Y03-89P AND PHYSICALLY TRANSPORT THE KEY TO MAINLINE TPSS S08 AND USE IT TO CLOSE BKR S08-172-6.

FOR YARD TPSS RESTORATION SEQUENCE OF OPERATIONS,
REVERSE THE ABOVE STEPS.

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NOTES:
1. REFER TO SPECIFICATION 34 21 16 21 FOR TPSS CONTROL POWER REQUIREMENTS.

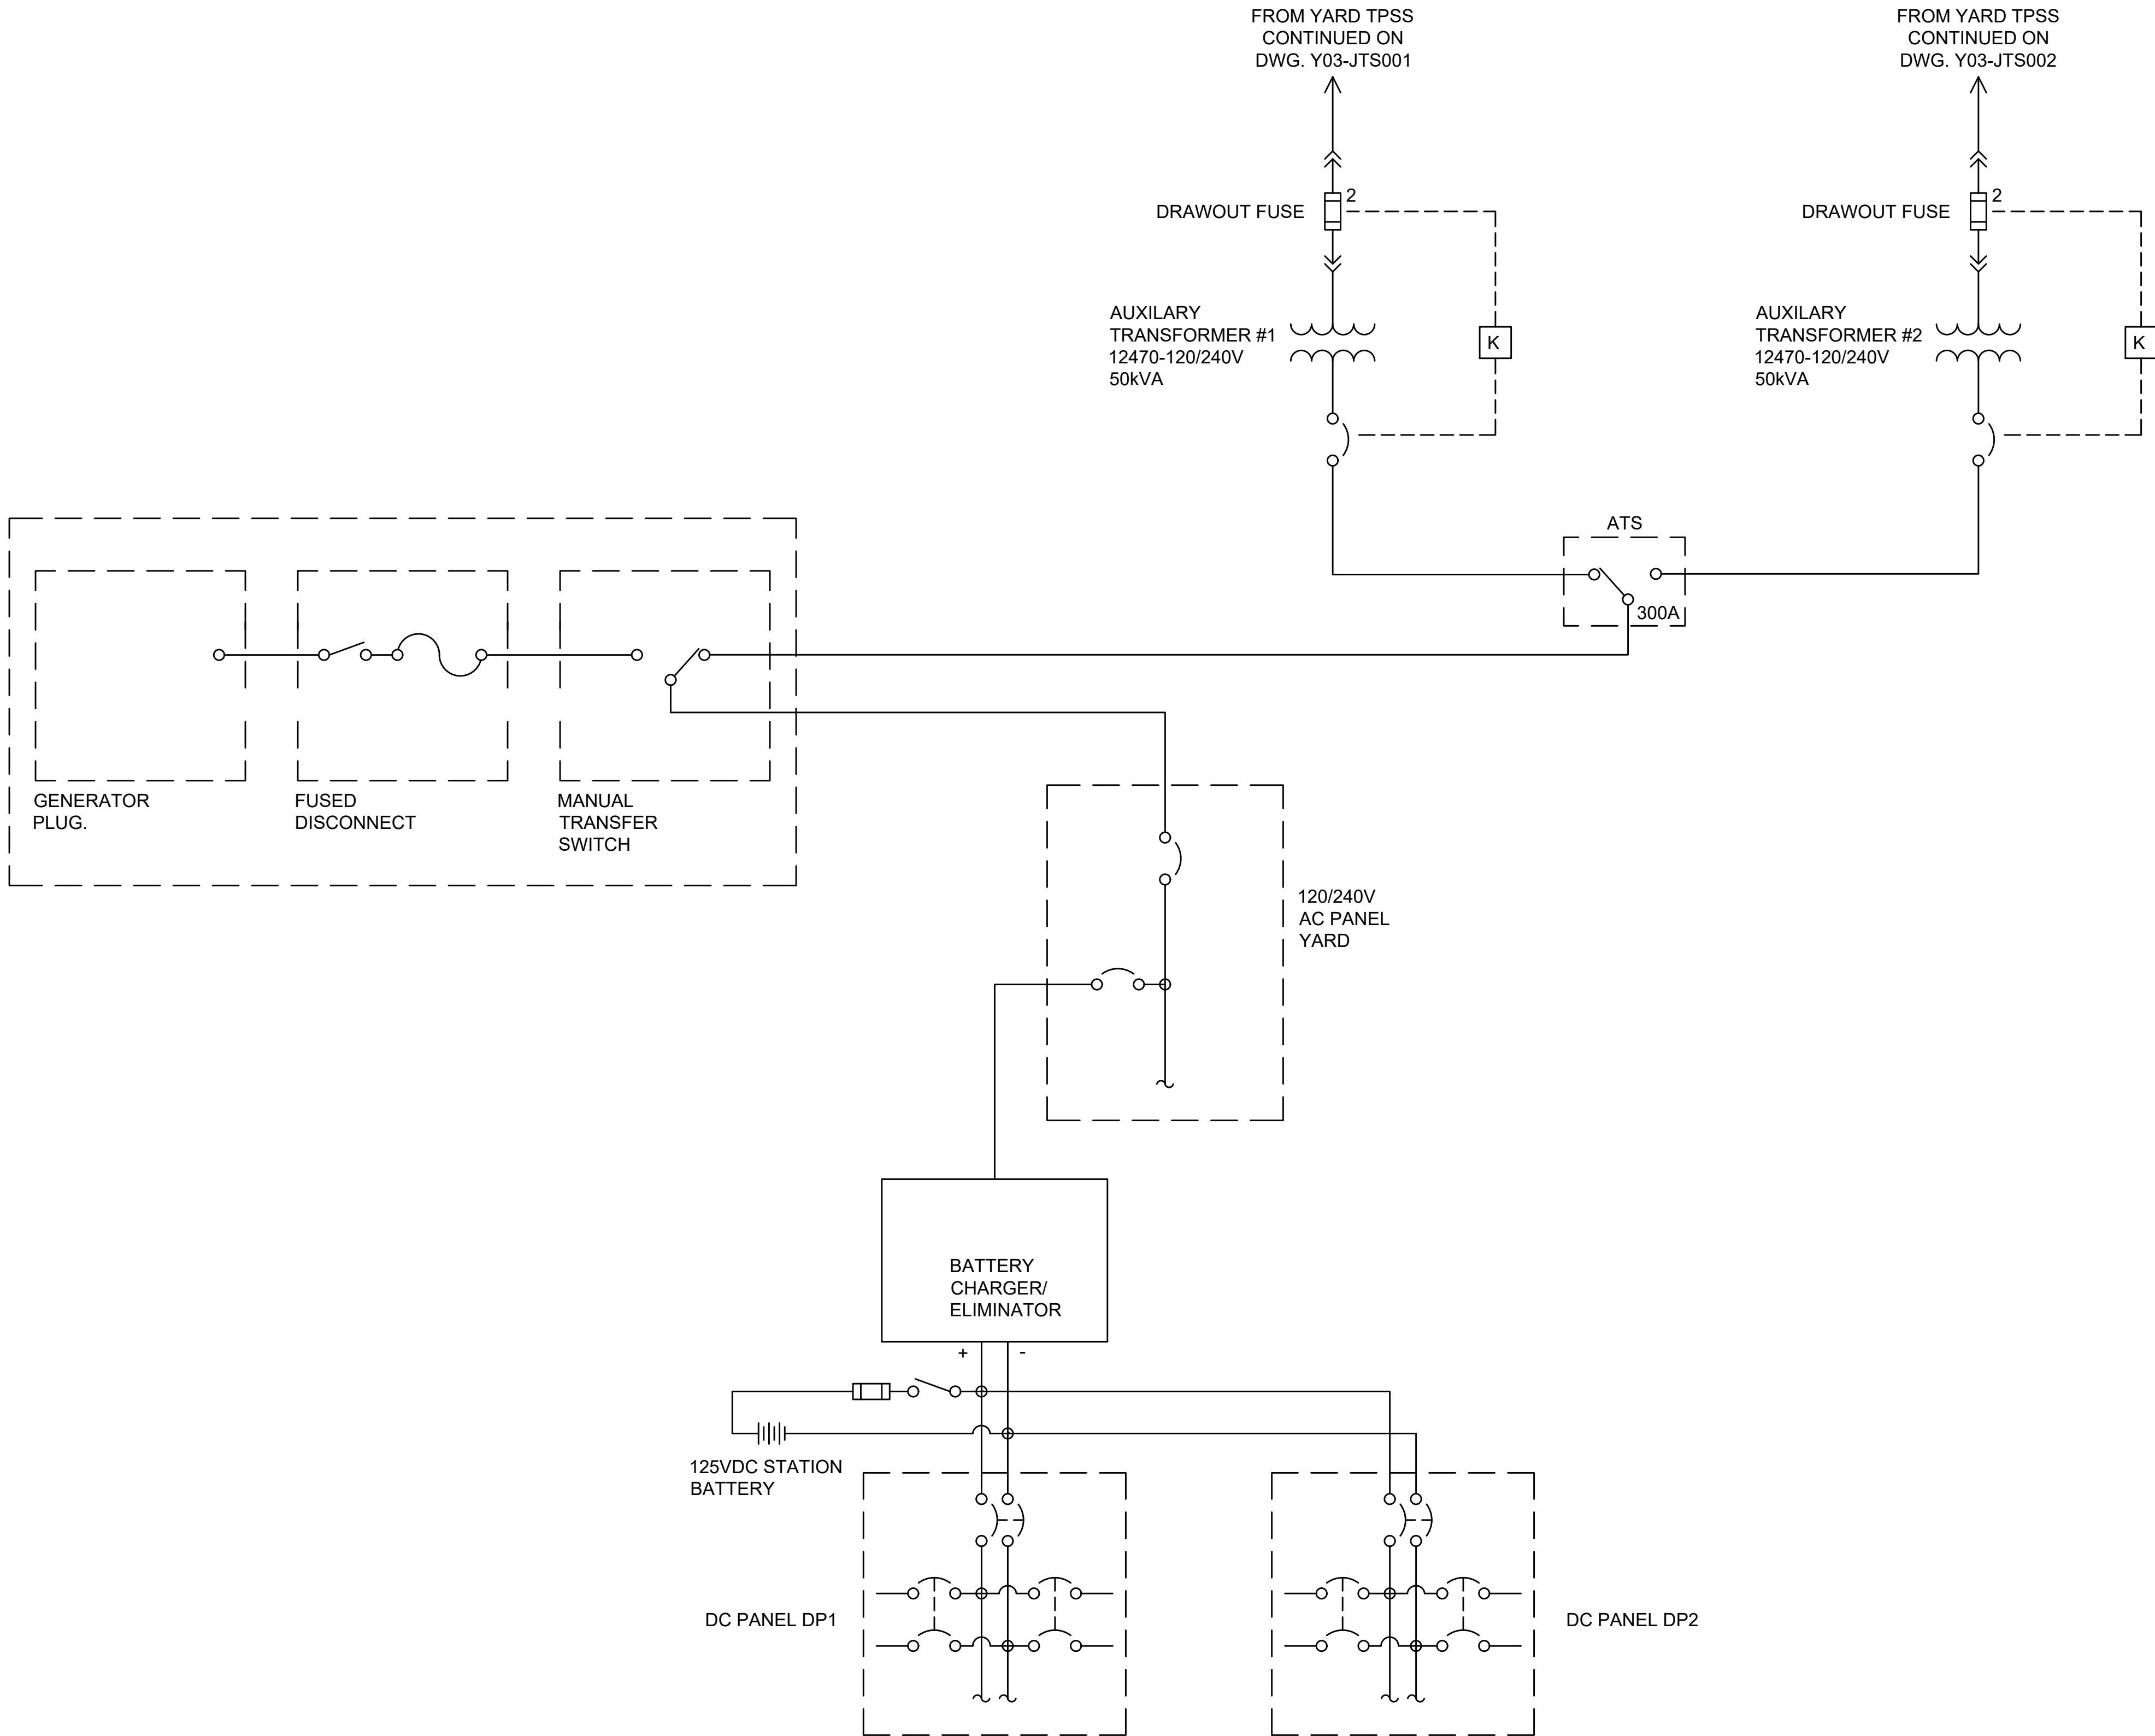**TPSS SERVICE CONTROL POWER
SCHEMATIC**

PRELIMINARY
ENGINEERING



NOT FOR
CONSTRUCTION

Refer to the plan set COVER drawing
for disclaimers regarding this drawing.

REFERENCE CONCEPT DRAWINGS

No.	DATE	DSN	CHK	APP	REVISION

DESIGNED BY:
P. VIJAYASUNDARARAJAN
DRAWN BY:
M. SHEPPARD
CHECKED BY:
J. HASROUNI
APPROVED BY:
J. SCHIMPF

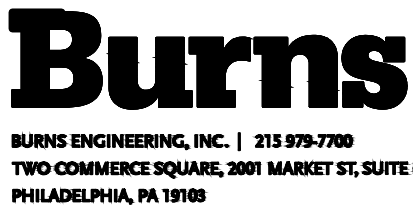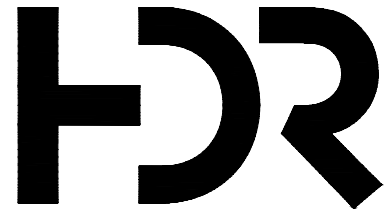

LINE IS 1" AT
FULL SCALE



SUBMITTED BY: PABLO LOPEZ-HILFIKER
DATE: 2/27/2024
REVIEWED BY:
DATE:

PACKAGE #

SCALE:
NTS
FILENAME:
OMFS-Y03-JTS003
CONTRACT No.:
AE0030-17
DATE:

**SOUND TRANSIT
PRELIMINARY ENGINEERING PLANS**
OPERATIONS & MAINTENANCE FACILITY SOUTH
TRACTION POWER SYSTEM
YARD TPSS AUXILARY POWER SCHEMATIC

DRAWING No.:
Y03-JTS003
FACILITY ID:
Y03
SHEET No.: REV:
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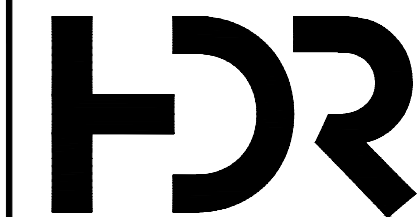
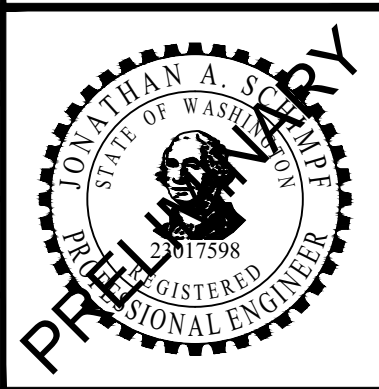
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Refer to the plan set COVER drawing
for disclaimers regarding this drawing.

REFERENCE CONCEPT DRAWINGS

No.	DATE	DSN	CHK	APP	REVISION

DESIGNED BY:	P. VIJAYASUNDARARAJAN
DRAWN BY:	M. SHEPPARD
CHECKED BY:	J. HASROUNI
APPROVED BY:	J. SCHIMPF



SUBMITTED BY:
PABLO LOPEZ-HILFIKER

DATE:
2/27/2024



BURNS ENGINEERING, INC. | 215 978-7780
TWO COMMERCE SQUARE, 2001 MARKET ST, SUITE 600
PHILADELPHIA, PA 19103

REVIEWED BY:

LINE IS 1" AT
FULL SCALE



DATE:


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CONTRACT No.:	AE0030-17
DATE:	

SOUND TRANSIT
PRELIMINARY ENGINEERING PLANS
OPERATIONS & MAINTENANCE FACILITY SOUTH

TRACTION POWER SYSTEM
SHOP TPSS METERING & RELAYING
SINGLE LINE DIAGRAM

DRAWING No.:	Y03-JTS004
FACILITY ID:	Y03
SHEET No.:	REV:
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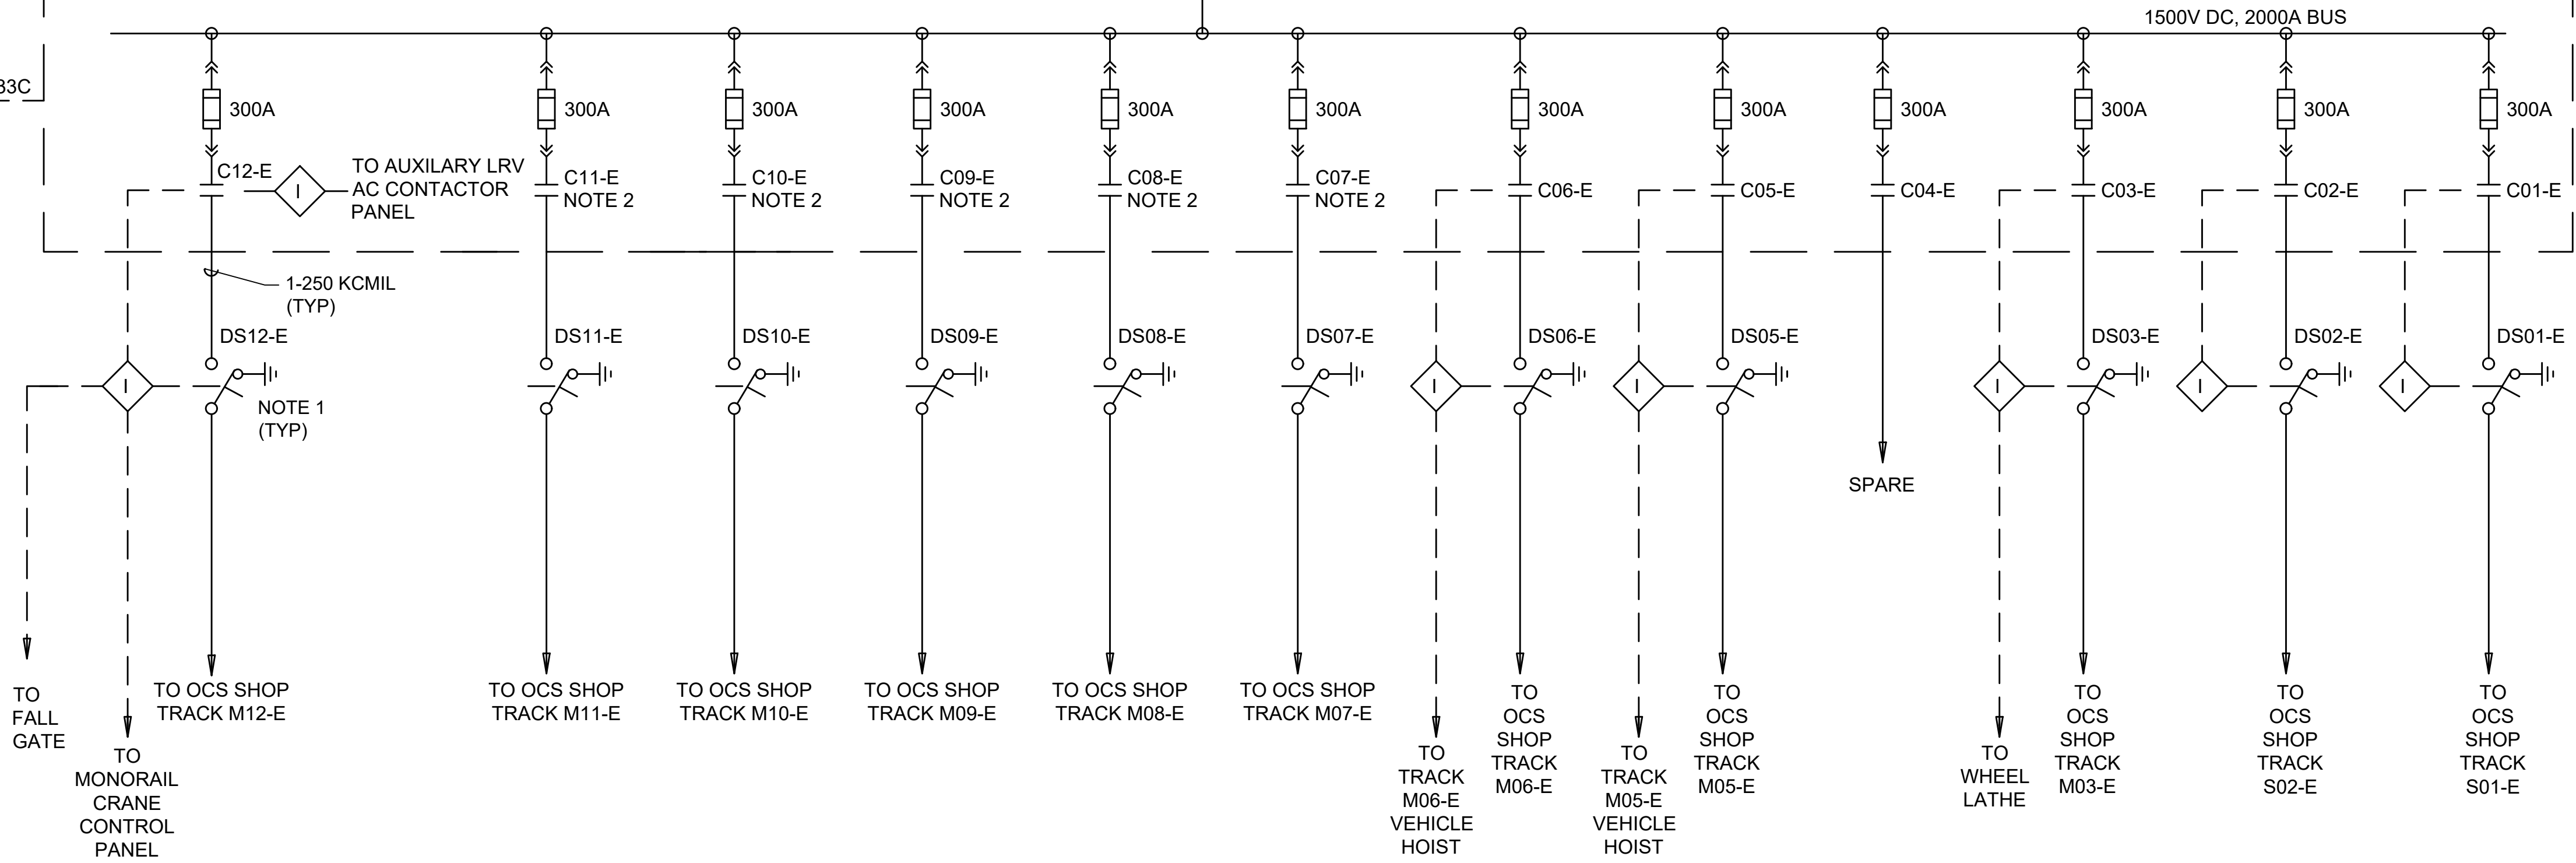
NOTES:

- 89P HAS A DOUBLE KIRK KEY INTERLOCK TO PREVENT THE SWITCH FROM BEING OPERATED UNDER LOAD. ONE KEY, K2, IS INTERLOCKED WITH THE AC BREAKER. 89P CAN NOT BE OPENED UNLESS THE AC BREAKER IS OPEN. THE SECOND KEY, K3, IS INTERLOCKED WITH 89N. 89N CAN NOT BE OPENED UNLESS BOTH THE AC BREAKER AND 89P ARE OPEN.
- DC CONTACTOR PANEL DOOR SWITCH 33C WILL TRIP ONLY THE CORRESPONDING DC FEEDER BREAKER.
- THERE ARE (2) ETS PUSHBUTTONS. ONE IS LOCATED IN THE SHOP TPSS BUILDING. THE OTHER IS LOCATED ON THE SHOP BUILDING FLOOR.

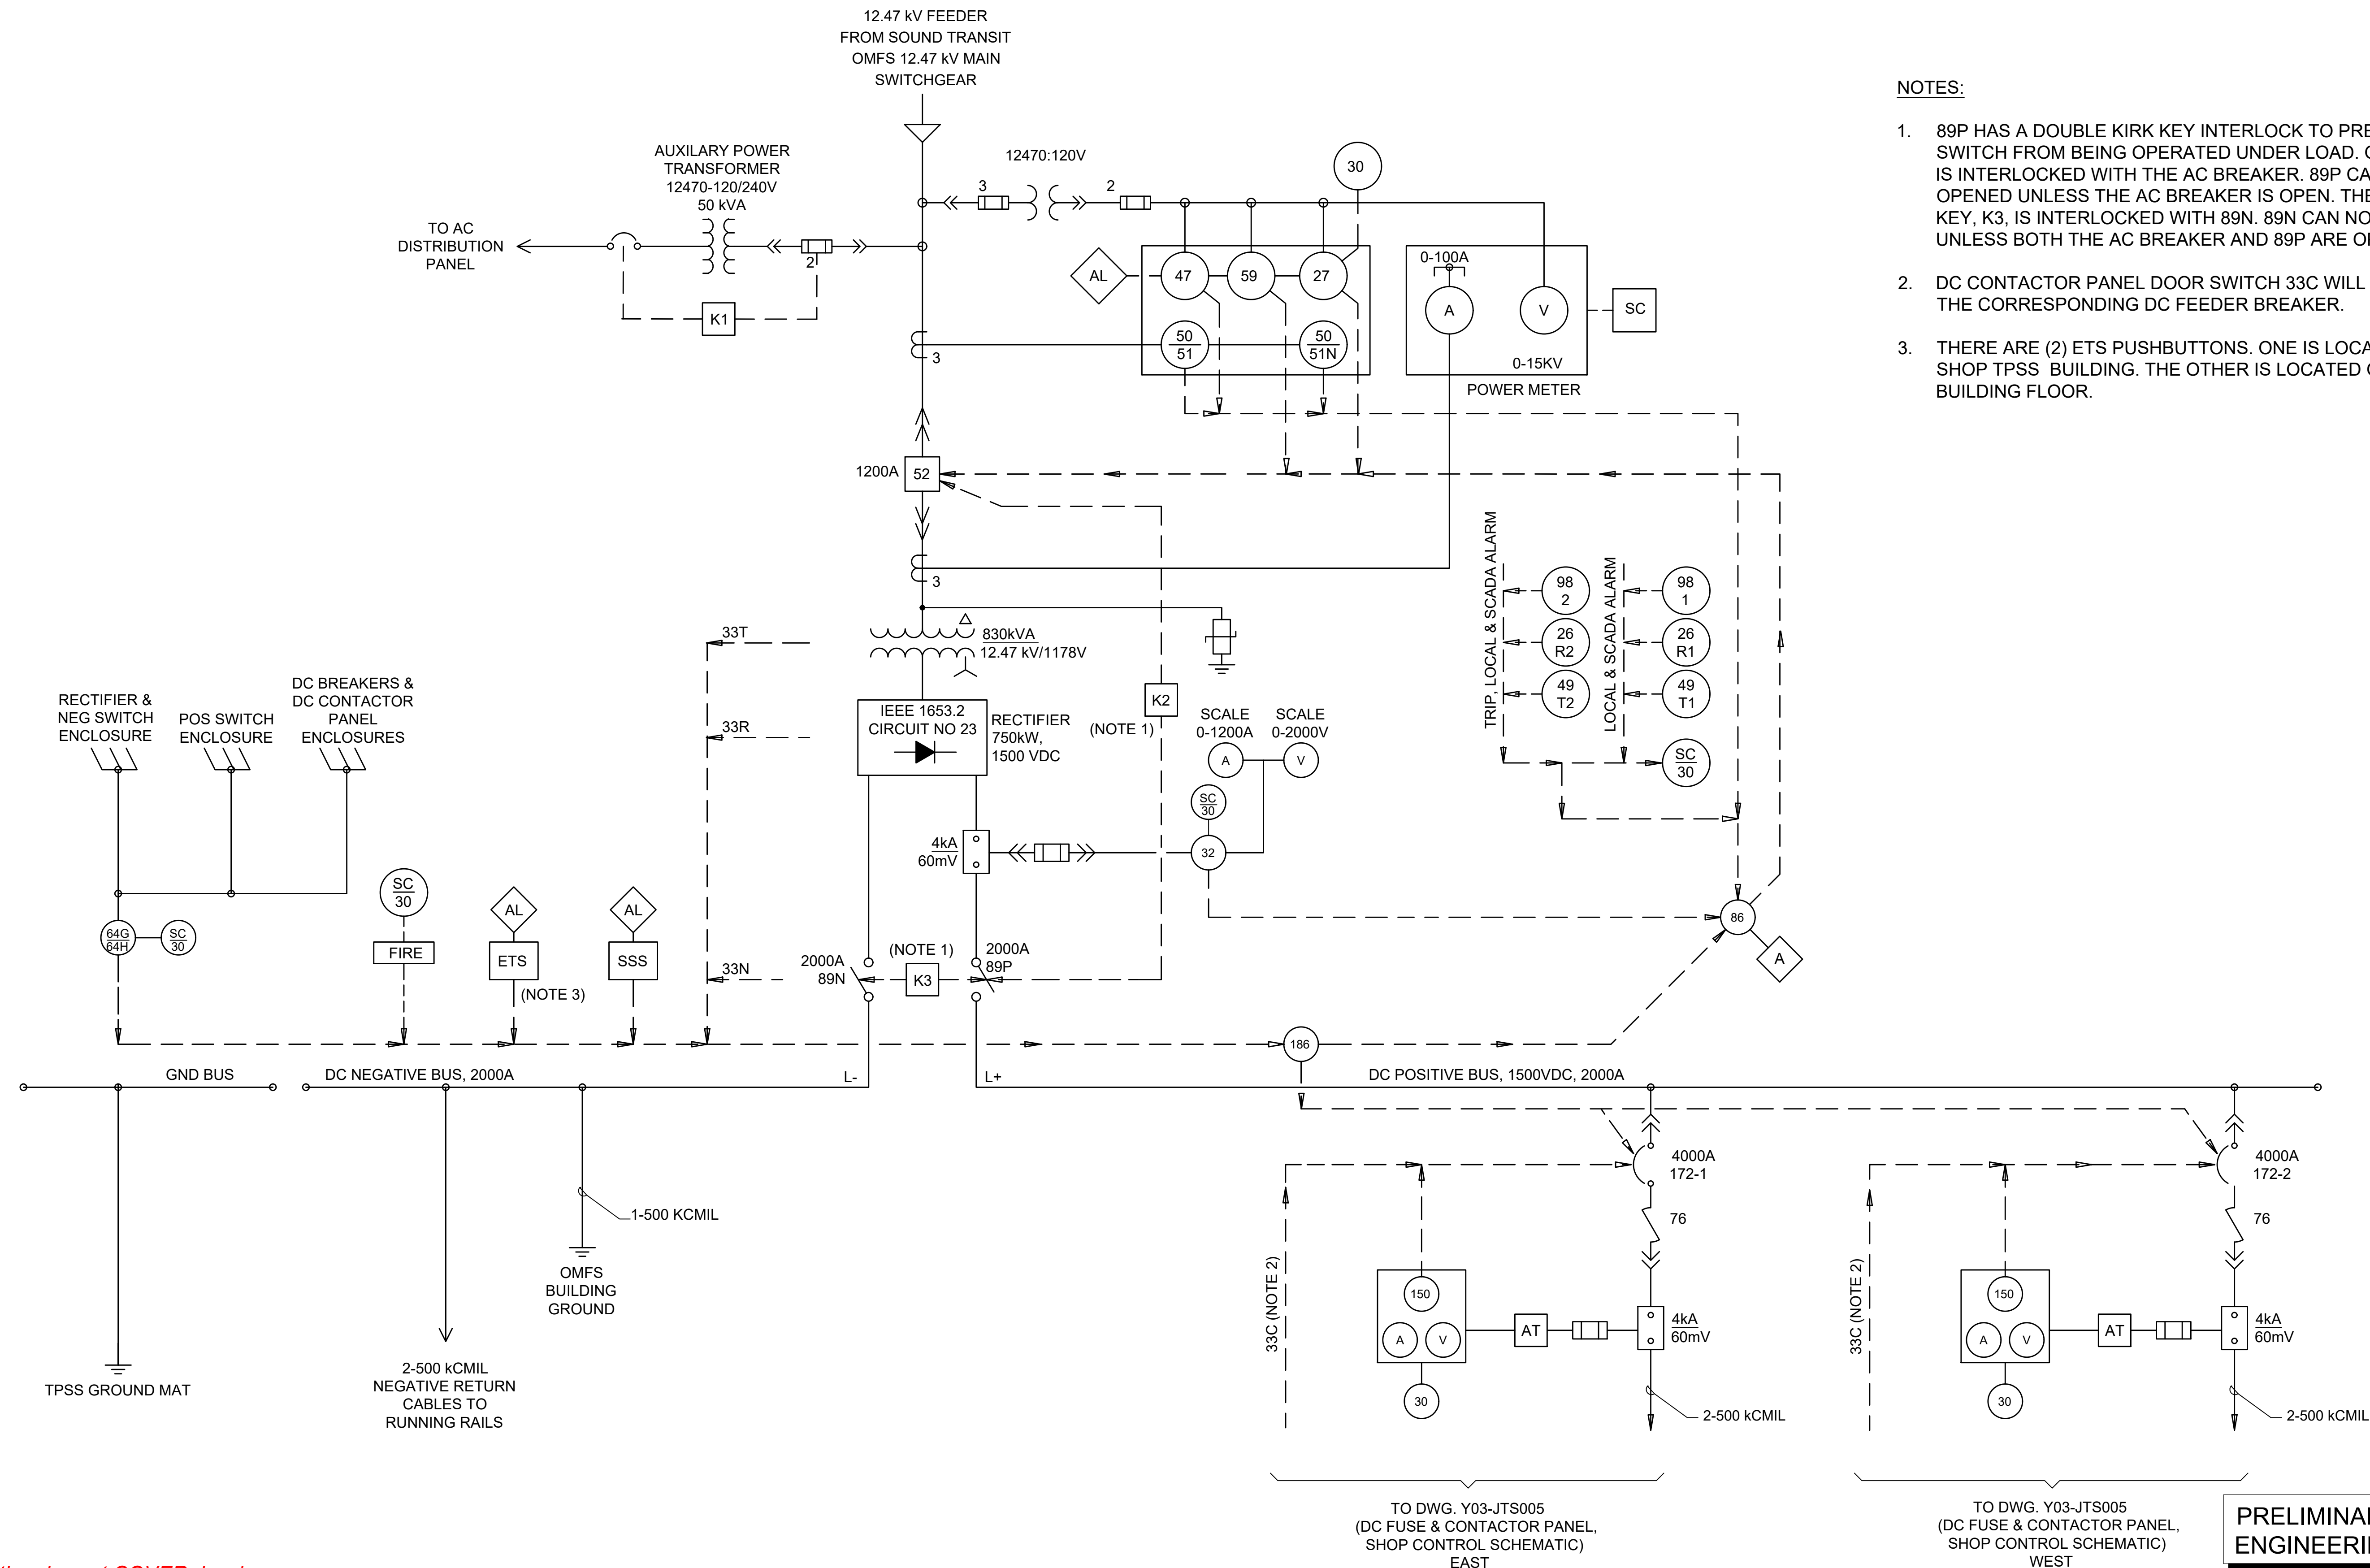
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FOR CONTINUATION,
REFER TO DWG. Y03-JTS004

DC FUSE & CONTACTOR PANEL (EAST)



DC FUSE & CONTACTOR PANEL (WEST)

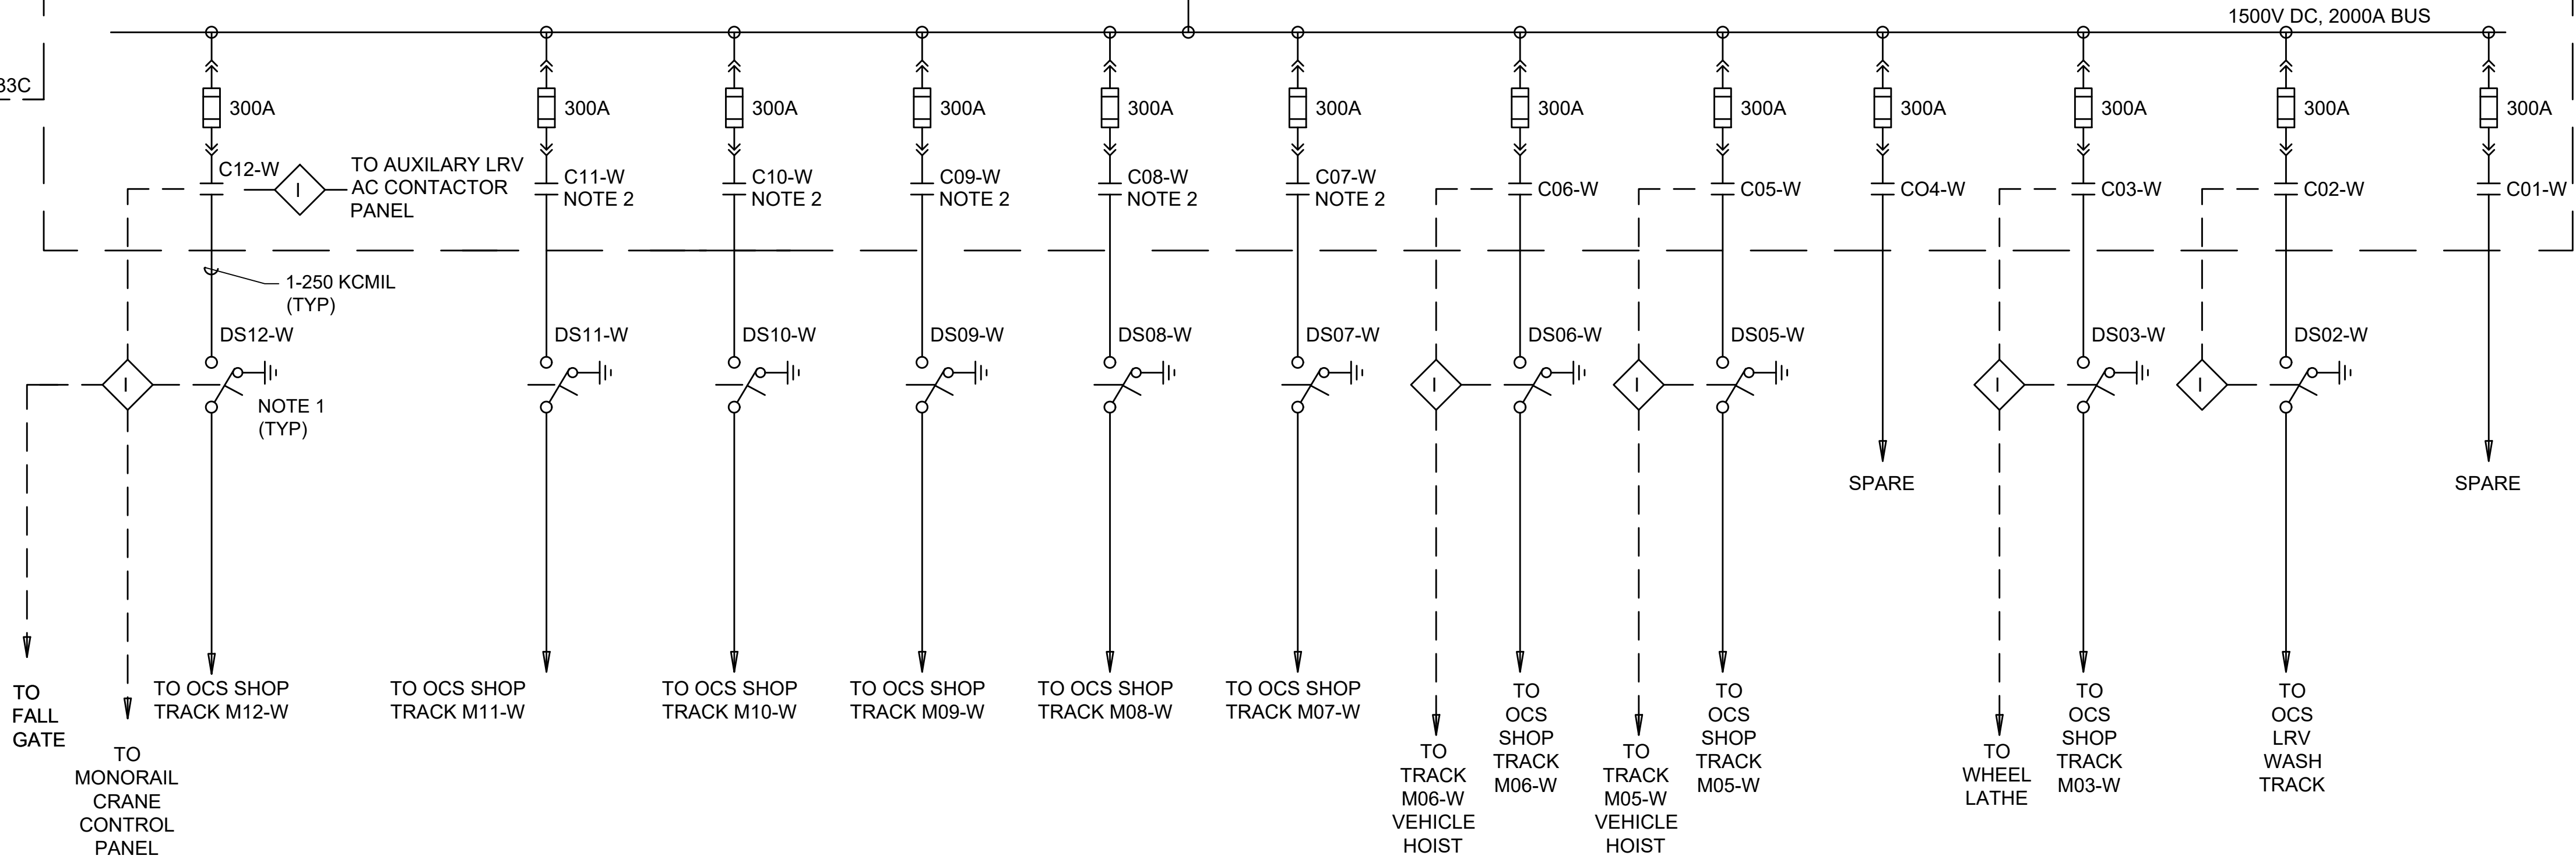

- NOTE:
- 2000 AMP DISCONNECT SWITCH GROUNDED WHEN OPEN TYPE IS MOUNTED ON SHOP COLUMNS.
 - INTERLOKS FOR CONTACTORS C07-E THROUGH C11-E AND C07-W THROUGH C11-W ARE IDENTICAL TO THOSE FOR CONTACTORS C12-E AND C12-W RESPECTIVELY.

Refer to the plan set COVER drawing
for disclaimers regarding this drawing.



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ENGINEERING

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CONSTRUCTION

REFERENCE CONCEPT DRAWINGS


No.	DATE	DSN	CHK	APP	REVISION

DESIGNED BY:
P. VIJAYASUNDARARAJAN
DRAWN BY:
M. SHEPPARD
CHECKED BY:
J. HASROUNI
APPROVED BY:
J. SCHIMPF

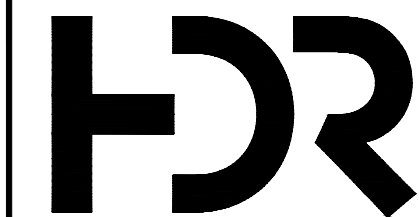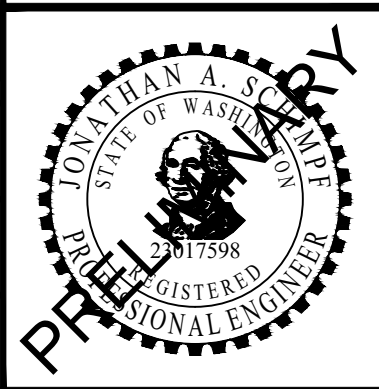

SUBMITTED BY:
PABLO LOPEZ-HILFIKER

DATE:
2/27/2024

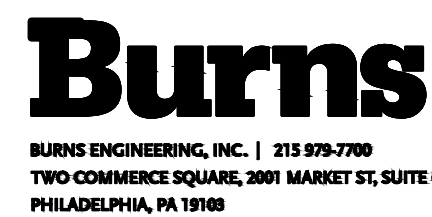

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TWO COMMERCE SQUARE, 2001 MARKET ST, SUITE 600
PHILADELPHIA, PA 19103

REVIEWED BY:

LINE IS 1" AT
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SCALE:
NTS
FILENAME:
OMFS-Y03-JTS005
CONTRACT No.:
AE0030-17
DATE:

SOUND TRANSIT
PRELIMINARY ENGINEERING PLANS
OPERATIONS & MAINTENANCE FACILITY SOUTH


TRACTION POWER SYSTEM
SHOP TPSS 1500VDC FUSE & CONTACTOR PANEL
CONTROL SINGLE LINE DIAGRAM

DRAWING No.:
Y03-JTS005
FACILITY ID:
Y03
SHEET No.:
REV:
0

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NOTES:

- CONTRACTOR SHALL COORDINATE CONDUIT FLOOR PENETRATION LOCATIONS WITH SUBSTATION BUILDING AND FOUNDATION PLANS.
- STAIRS AND LANDING SHALL BE PROVIDED. CONTRACTOR SHALL COORDINATE WITH THE FINAL SITE ELEVATION REQUIREMENTS.
- HATCH COVER SHALL BE RATED TO HANDLE MAXIMUM EQUIPMENT WEIGHT.
- PROVIDE ELECTRICAL INSULATION ON ALL WALLS AND FLOOR IN AREAS SHOWN. IF 6' MINIMUM CANNOT BE ACHIEVED, LINE DOORS, FRAMS AND HARDWARE WITH INSULATION. FLOOR INSULATION TO EXTEND TO ALL WALLS.
- PROVIDE GLASTIC BARRIER BETWEEN TRACTION POWER TRANSFORMER AND RECTIFIER. ENSURE BARRIER CAN PROVIDE AT LEAST 2'-6" CLEARANCE.
- COORDINATE BUILDING DIMENSIONS AND EQUIPMENT LOADINGS WITH STRUCTURAL ENGINEER.

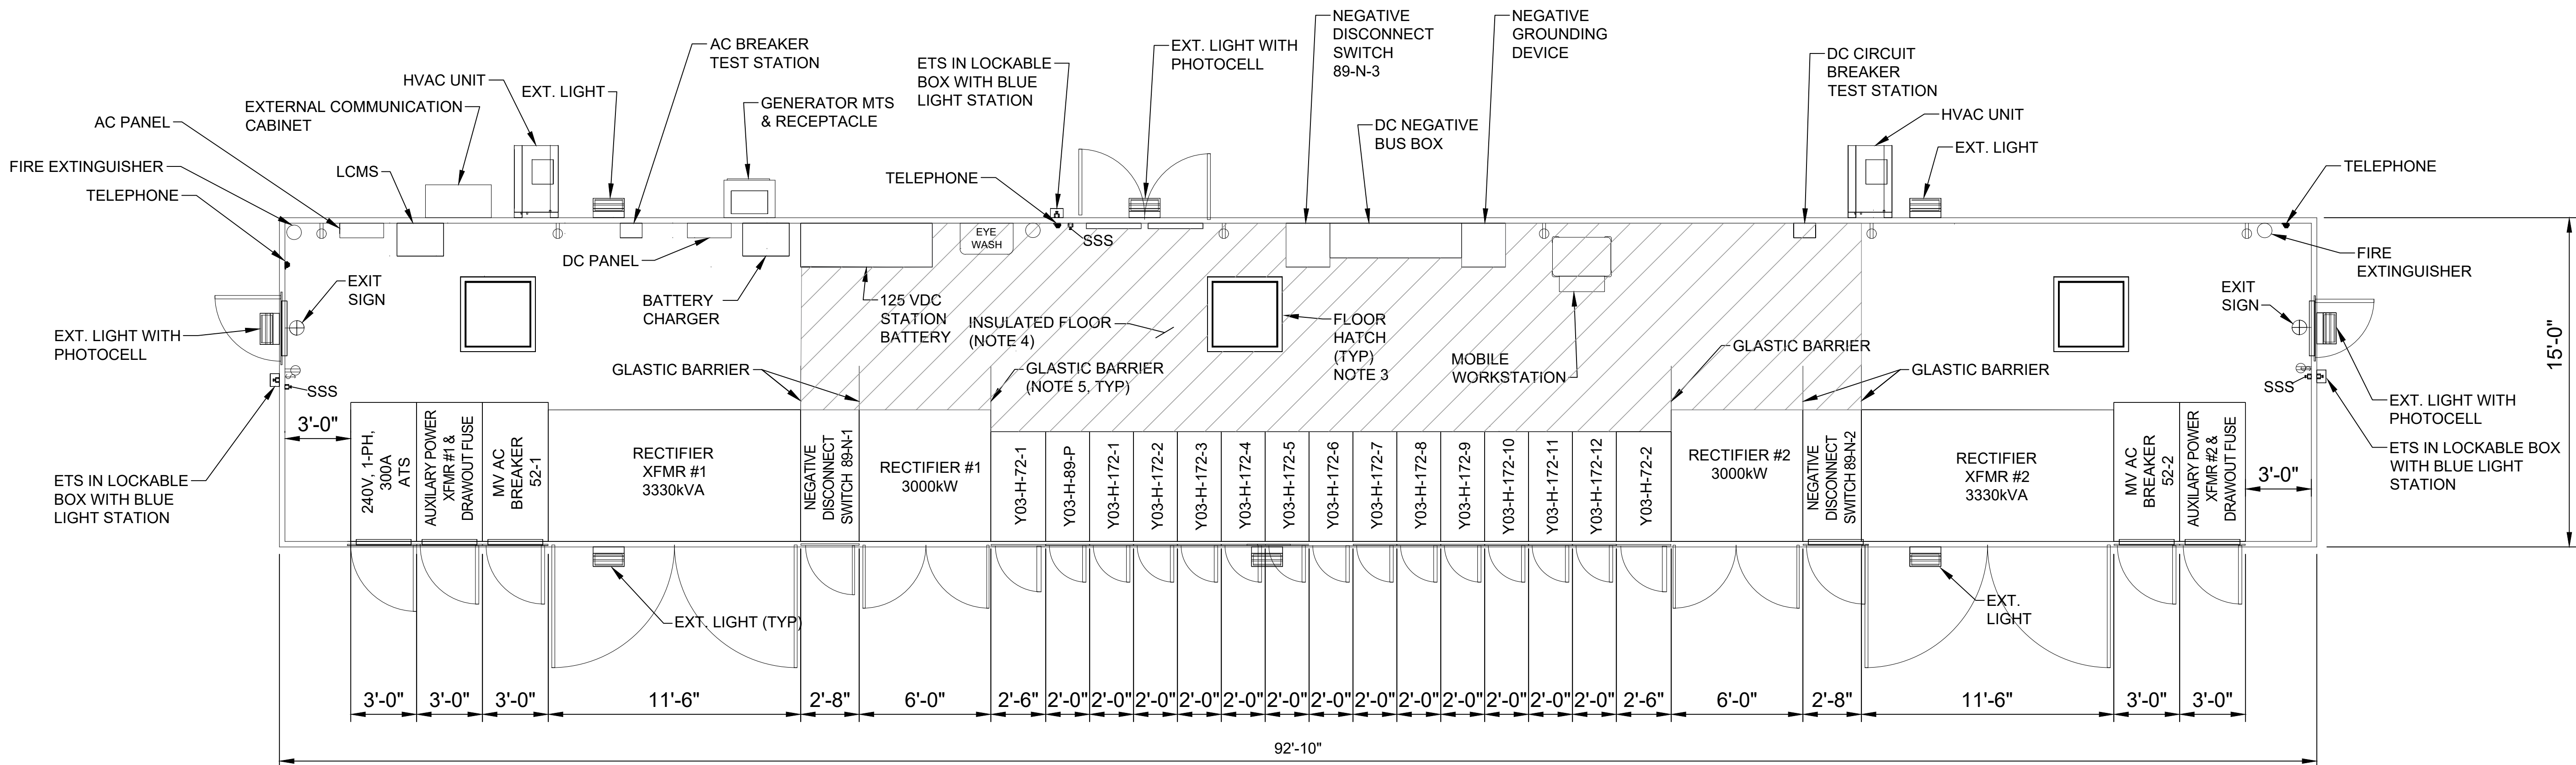

YARD TPSS EQUIPMENT LAYOUT - PLAN

PRELIMINARY
ENGINEERING




NOT FOR
CONSTRUCTION

Refer to the plan set COVER drawing
for disclaimers regarding this drawing.

REFERENCE CONCEPT DRAWINGS

No.	DATE	DSN	CHK	APP	REVISION

DESIGNED BY:
P. VIJAYASUNDARARAJAN
DRAWN BY:
M. SHEPPARD
CHECKED BY:
J. HASROUNI
APPROVED BY:
J. SCHIMPF

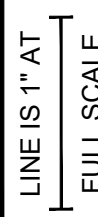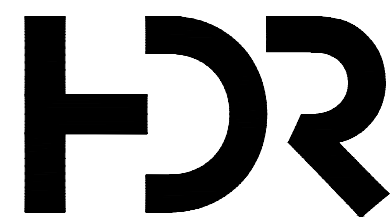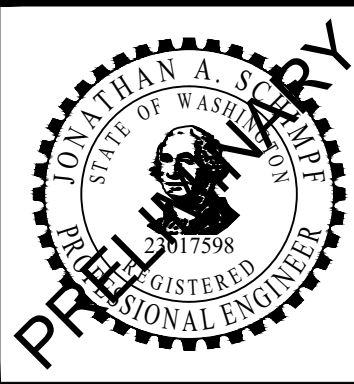

SUBMITTED BY: PABLO LOPEZ-HILFIKER
DATE: 2/27/24
REVIEWED BY:
DATE:

PACKAGE #

SCALE:
3/8" = 1'-0"
FILENAME:
OMFS-Y03-JTP101
CONTRACT No.:
AE0030-17
DATE:

SOUND TRANSIT
PRELIMINARY ENGINEERING PLANS
OPERATIONS & MAINTENACE FACILITY SOUTH
TRACTION POWER SYSTEM
YARD TPSS EQUIPMENT LAYOUT PLAN

DRAWING No.:
Y03-JTP101
FACILITY ID:
Y03
SHEET No.:
REV:
0

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NOTES:

1. PROVIDE REMOVABLE TRANSOM AND WALL PANEL ABOVE DOOR.

2. COMM TO DETERMINE FINAL LOCATION AND SIZE.

3. MOUNT CAMERAS AND CASES TO TPSS FOR WATER TEST AND REMOVE FOR SHIPMENT. REINSTALL AT SITE.

4. COORDINATE BUILDING DIMENSIONS AND EQUIPMENT LOADINGS WITH STRUCTURAL ENGINEER.

5. PROVIDE ELECTRICAL INSULATION ON ALL WALLS AND FLOOR IN AREAS SHOWN. IF 6' MINIMUM CANNOT BE ACHIEVED, LINE DOORS, FRAMS AND HARDWARE WITH INSULATION. FLOOR INSULATION TO EXTEND TO ALL 3 WALLS.

6. PROVIDE GLASTIC BARRIER BETWEEN RECTIFIER TRANSFORMER AND RECTIFIER. EXTEND GLASTIC 2'-6" BEYOND RECTIFIER TRANSFORMER. AS SHOWN. PROVIDE AN INSULATED FINISHED EDGE ON EXPOSED GLASTIC EDGE.
7. PROVIDE GLASTIC BARRIER INSIDE REAR DOOR TO COMPLETE WALL INSULATION WHEN DOOR IS CLOSED.

8. HVAC UNIT LAYOUT IS FOR REFERENCE ONLY.

9. HATCH COVER SHALL BE RATED TO HANDLE MAXIMUM EQUIPMENT WEIGHT.


10. PROVIDE STAIRS AND LANDINGS.

11. PROVIDE CONTINUOUS GROUND BUS AROUND ENTIRE TPSS.

12. LOCATE AND SIZE PULLBOX TO SUIT SITE CONDITIONS.

13. DC CONTACTOR PANEL CONSISTS OF 24 CONTACTORS ARRANGED IN TOP AND BOTTOM ROWS.

14. SIZE AND LOCATION OF FLOOR CUTOUTS FOR DC CABLE ENTRANCES TO BE DETERMINED BY THE CONTRACTOR.

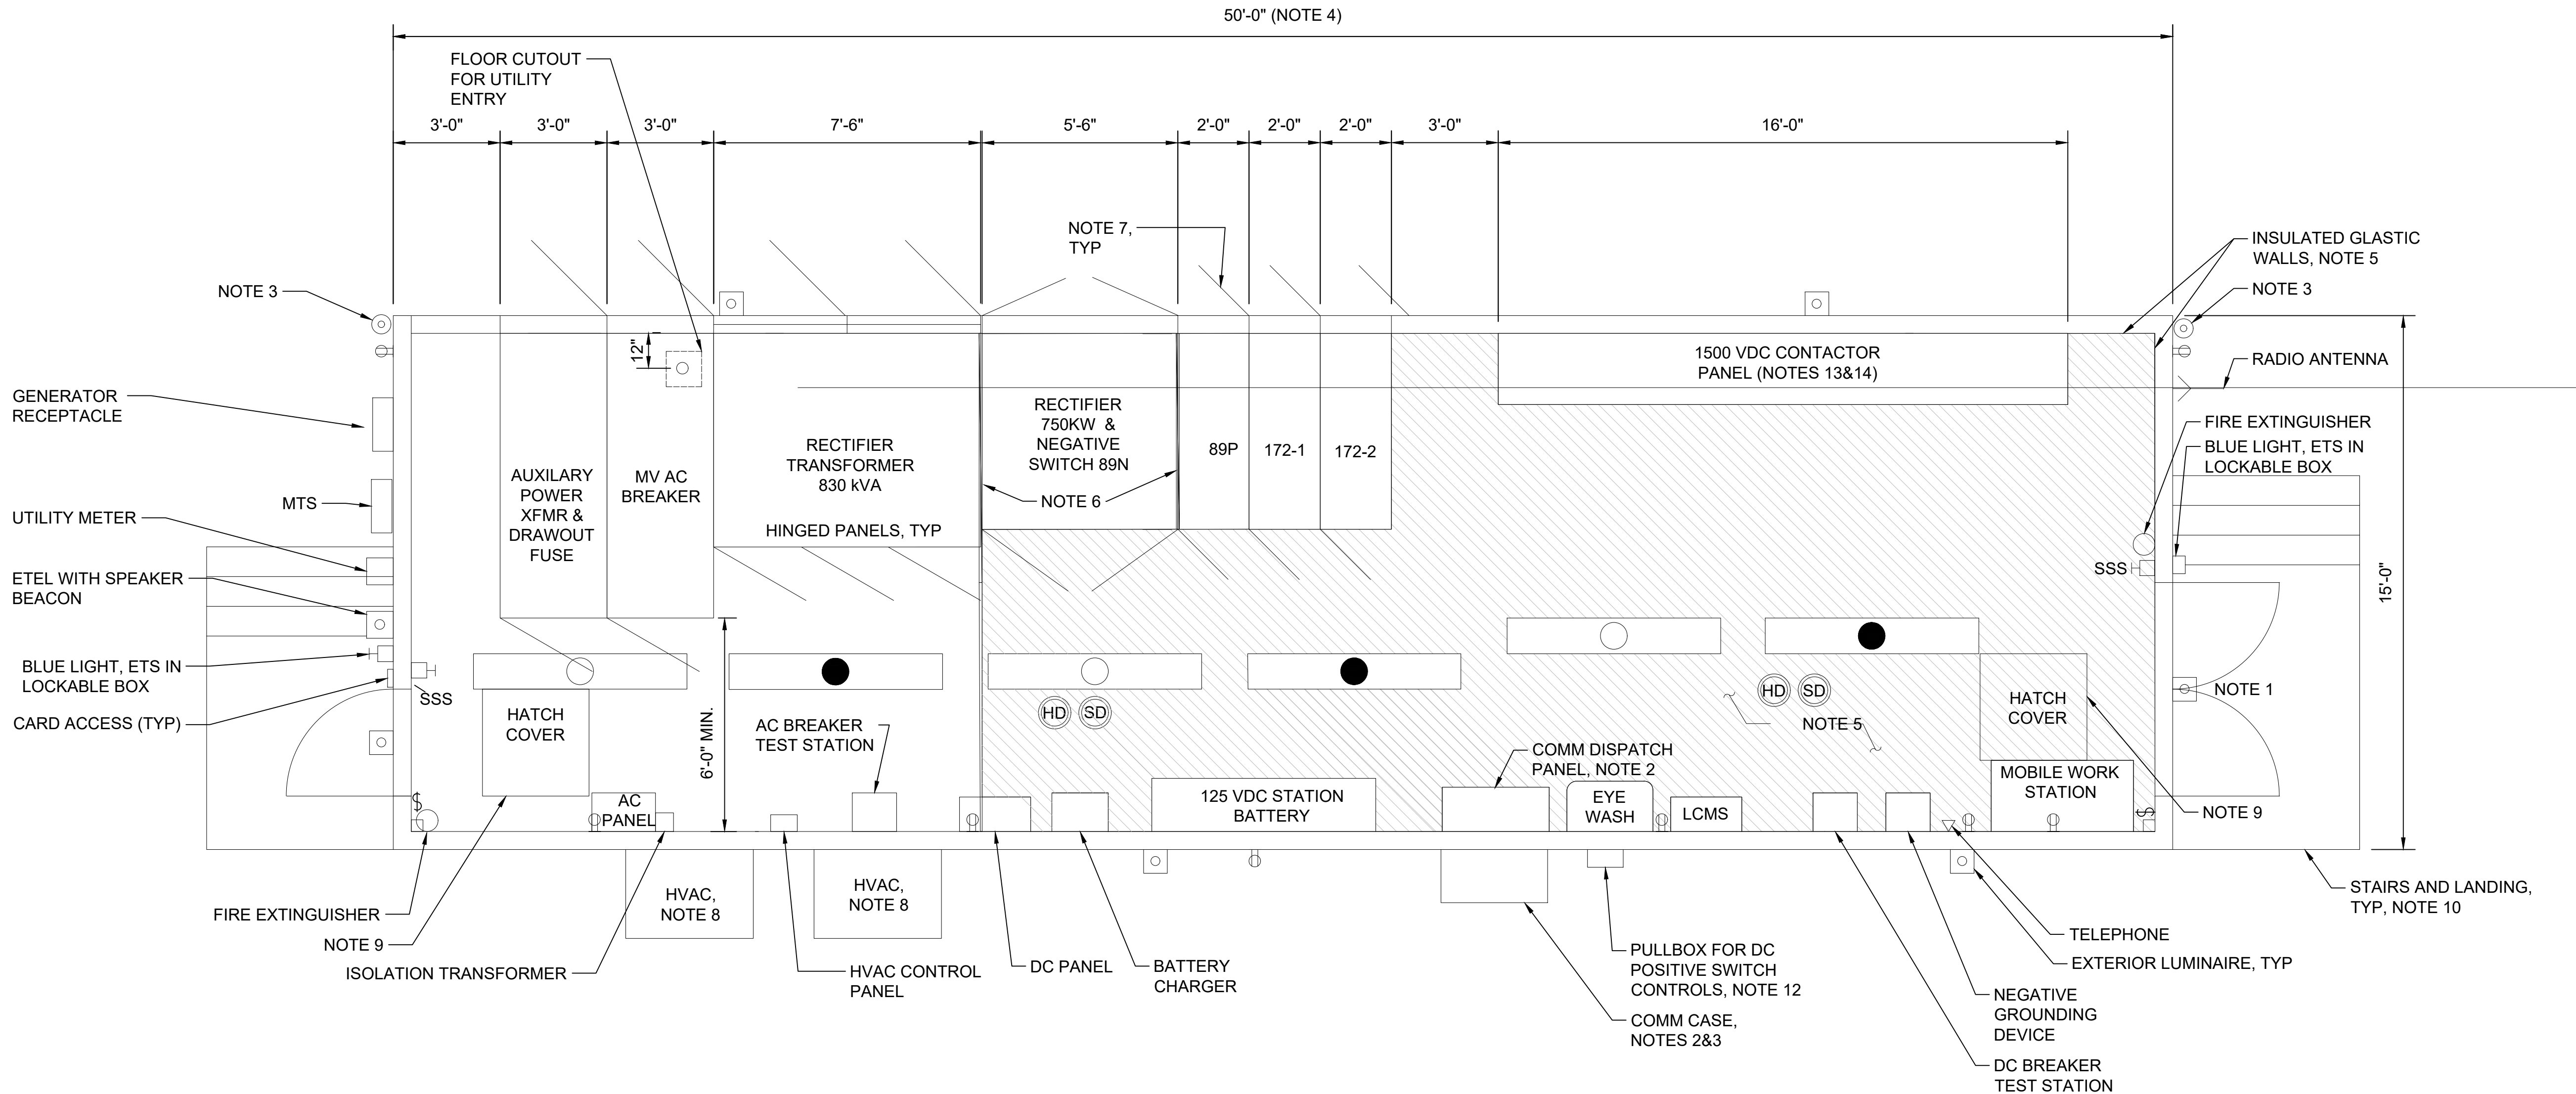

SHOP TPSS EQUIPMENT LAYOUT - PLAN

PRELIMINARY
ENGINEERING



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Refer to the plan set COVER drawing
for disclaimers regarding this drawing.

REFERENCE CONCEPT DRAWINGS

No.	DATE	DSN	CHK	APP	REVISION



DESIGNED BY:	P. VIJAYASUNDARAJAN
DRAWN BY:	M. SHEPPARD
CHECKED BY:	J. HASROUNI
APPROVED BY:	J. SCHIMPF

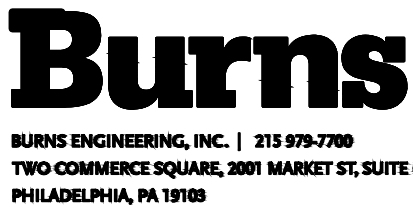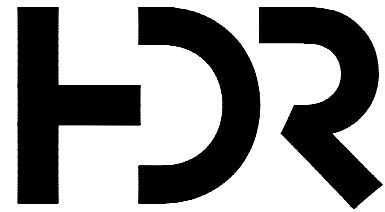

SUBMITTED BY:	DATE:	REVIEWED BY:	DATE:
PABLO LOPEZ-HILFIKER	2/27/24		





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FILENAME:	OMFS-Y03-JTP102			FACILITY ID: Y03	
CONTRACT No.:	AE0030-17			SHEET No.:	
DATE:				REV: 0	

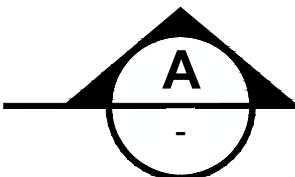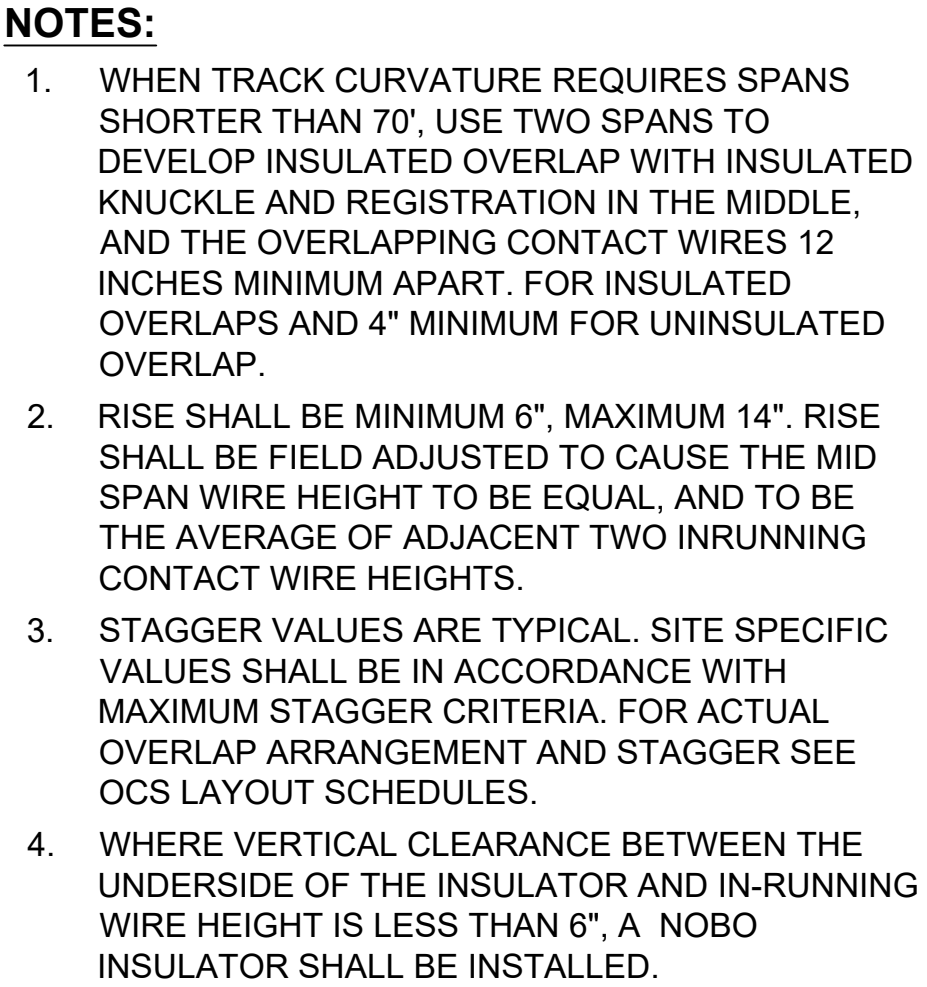

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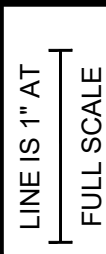
REFERENCE CONCEPT DRAWINGS

DESIGNED BY:
M. RAMOS
DRAWN BY:
M. CLEMENT
CHECKED BY:
R. DEMERS
APPROVED BY:
M. RAMOS

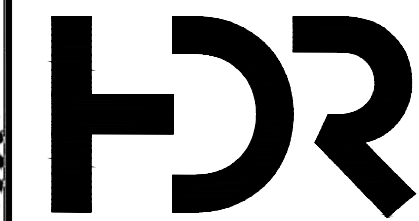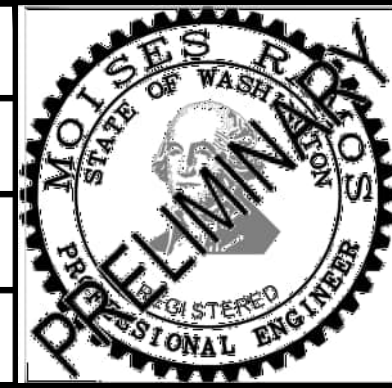

DATE:
2/27/2024

REVIEWED BY:




DATE:	DATE: 2/27/2024
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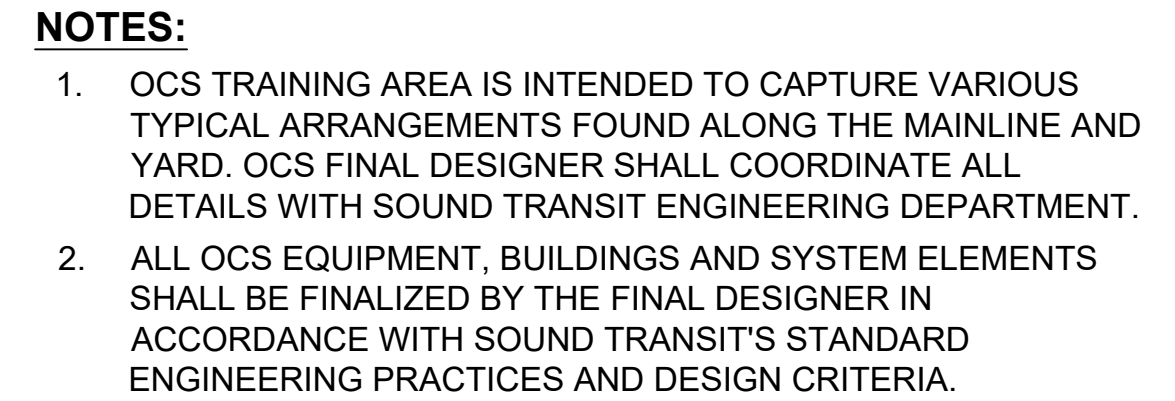
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CONTRACT No.:	AE-0030-17
DATE:	2/27/2024

SOUND TRANSIT
PRELIMINARY ENGINEERING PLANS
OPERATIONS & MAINTENANCE FACILITY SOUTH
OVERHEAD CONTACT SYSTEMS
SINGLE CROSSOVER - YARD




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FACILITY ID:
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SHEET No.: REV
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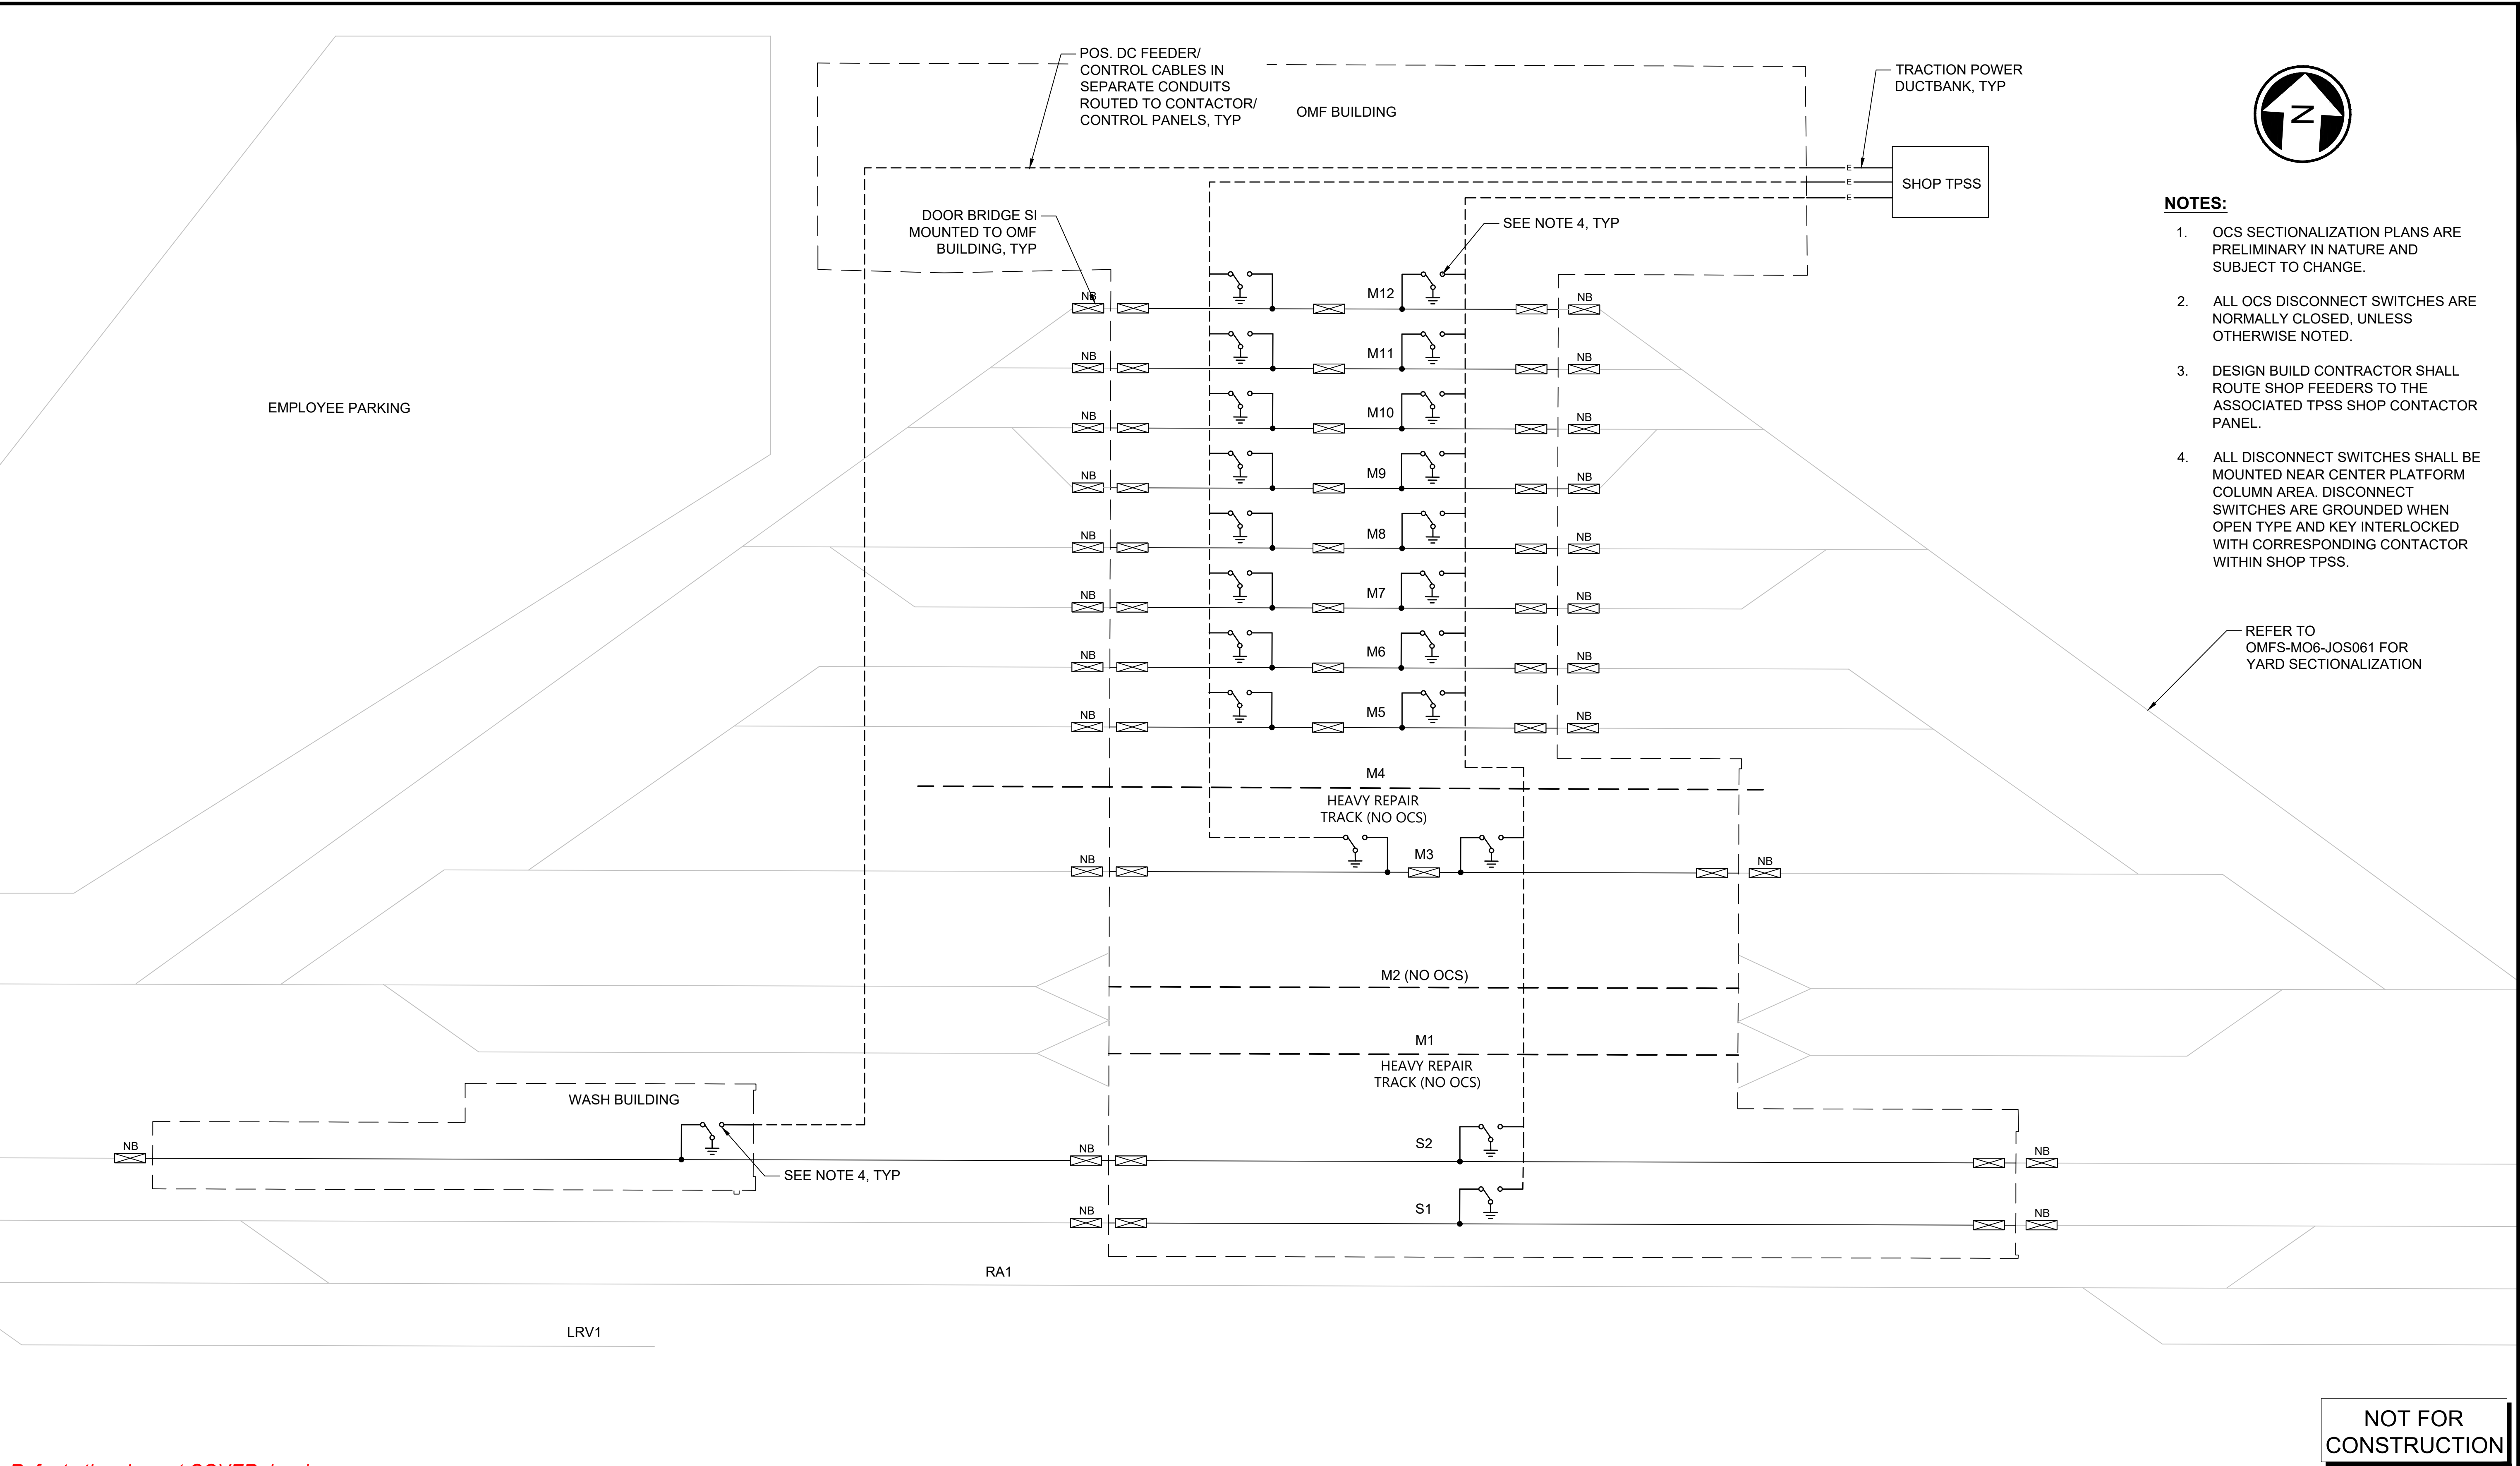
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*Refer to the plan set COVER drawing
for disclaimers regarding this drawing*

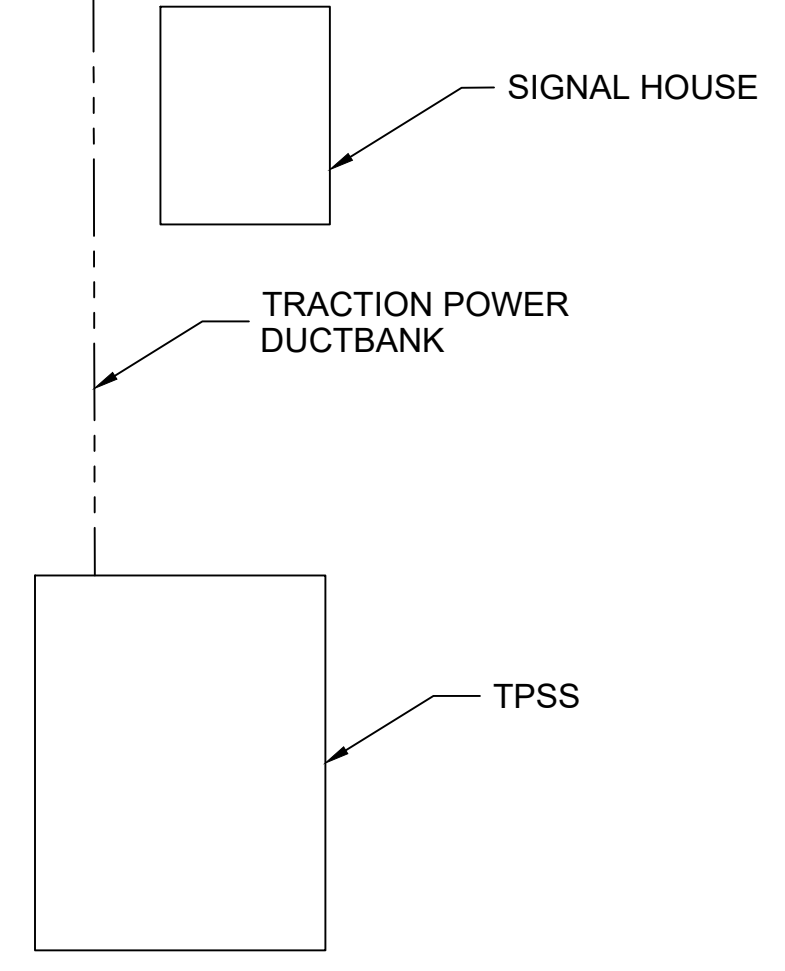Refer to the plan set COVER drawing for disclaimers regarding this drawing.										AHJ:										PACKAGE #																																							
REFERENCE CONCEPT DRAWINGS										DESIGNED BY: M. RAMOS										<div><div></div><div></div><div><div>LINE IS 1" AT FULL SCALE</div><div></div></div></div>										SCALE: NTS										<div><div>SOUND TRANSIT</div><div>PRELIMINARY ENGINEERING PLANS</div><div>OPERATIONS & MAINTENANCE FACILITY SOUTH</div><div>OVERHEAD CONTACT SYSTEMS</div><div>GENERAL ARRANGEMENT</div><div>TRAINING TRACK - YARD</div></div>										DRAWING No.: M08-JOY024									
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										APPROVED BY:																				DATE:																				DATE:									
										M. RAMOS																				PABLO LOPEZ-HILFIKER																				2/27/2024									
No.	DATE	DSN	CHK	APP	REVISION																																																						

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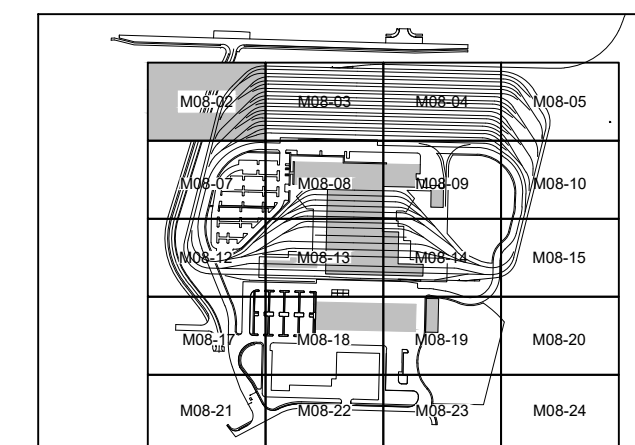


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for disclaimers regarding this drawing.

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No.	DATE	DSN	CHK	APP	REVISION		DESIGNED BY:	M. RAMOS	SCALE:	NTS	DRAWING No.: M08-JOS062		
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							SUBMITTED BY:		DATE:				
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							REVIEWED BY:		DATE:				
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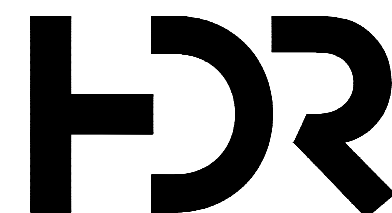
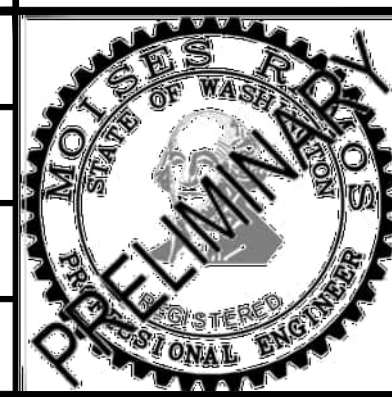
18 PLS EXTENSION




NOT FOR
CONSTRUCTION

REFERENCE CONCEPT DRAWINGS

DESIGNED BY:	M. RAMOS
DRAWN BY:	M. CLEMENT
CHECKED BY:	R. DEMERS
APPROVED BY:	M. RAMOS



SUBMITTED BY:	DATE:	REVIEWED BY:
PABLO LOPEZ-HILFIKER	2/27/2024	

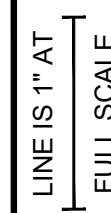


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FILENAME:	OMFS-M08-JOP200-21
CONTRACT No.:	AE-0030-17
DATE:	2/27/2024

SOUND TRANSIT
PRELIMINARY ENGINEERING PLANS
OPERATIONS & MAINTENANCE FACILITY SOUTH
OVERHEAD CONTACT SYSTEMS
YARD LAYOUT
1 OF 13

DRAWING No.:	
M08-JOP201	
FACILITY ID:	
M08	
SHEET No.:	REV:
	0



SEE DWG M08-JOP204

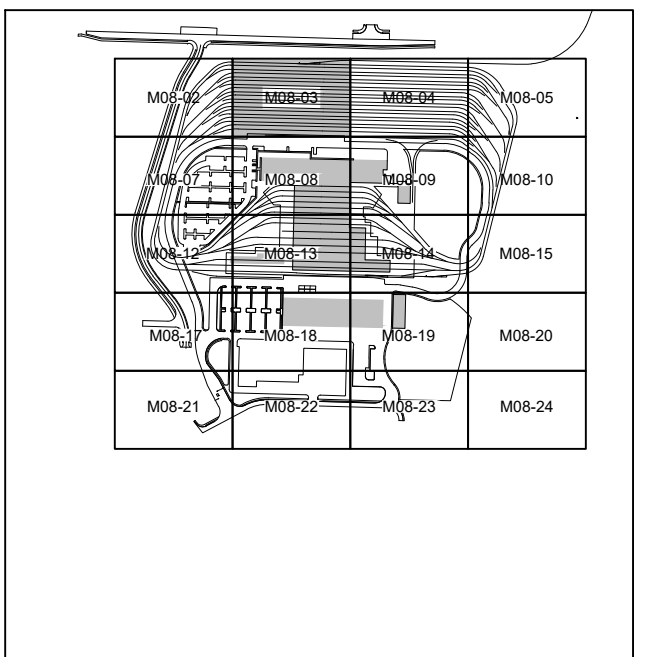


NOT FOR
CONSTRUCTION

SEE DWG M08-JOP208

DESIGNED BY:	M. RAMOS
DRAWN BY:	M. CLEMENT
CHECKED BY:	R. DEMERS
APPROVED BY:	M. RAMOS




REVIEWED BY:

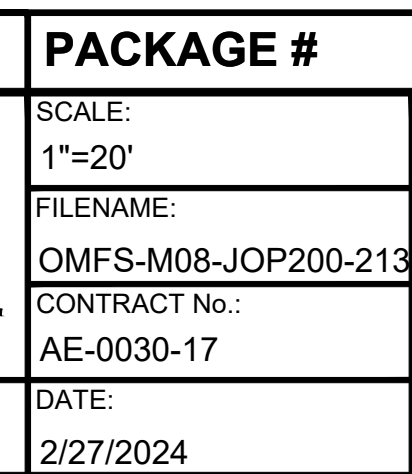

DRAWING No.:	
M08-JOP202	
FACILITY ID:	
M08	
SHEET No.:	REV:
	0



SEE DWG M08-JOP205

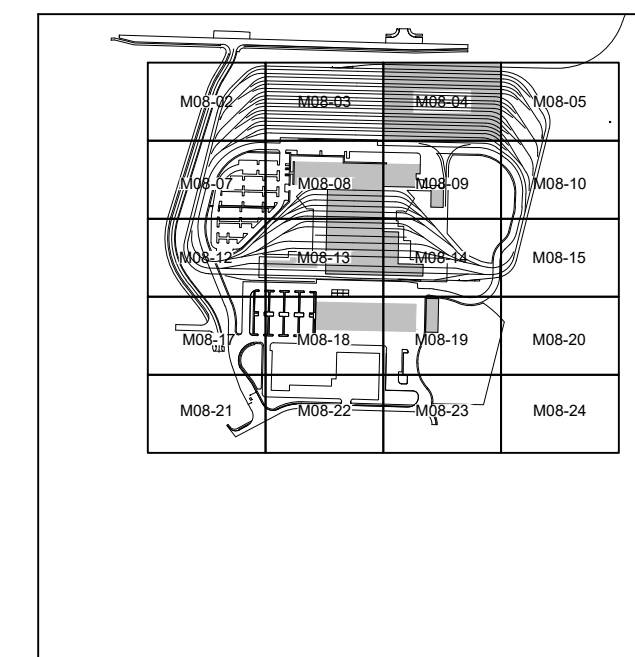


PRELIMINARY
ENGINEERING

NOT FOR
CONSTRUCTION

*Refer to the plan set COVER drawing
for disclaimers regarding this drawing.*


SEE DWG M08-JOP209

AHJ:

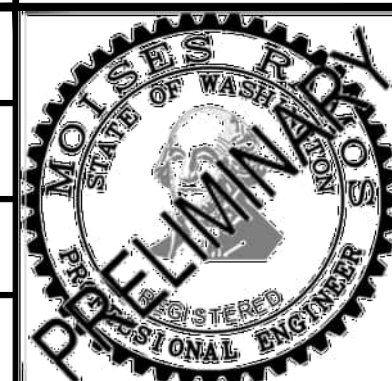SUBMITTED BY:
PABLO LOPEZ-HILFIKER

DATE:
2/27/2024

REVIEWED BY:

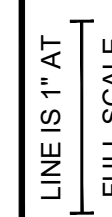




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PACKAGE #

SCALE:	1"=20'
FILENAME:	OMFS-M08-JOP200-213
CONTRACT No.:	AE-0030-17
DATE:	2/27/2024

SOUND TRANSIT
PRELIMINARY ENGINEERING PLANS
OPERATIONS & MAINTENANCE FACILITY SOUTH
OVERHEAD CONTACT SYSTEMS
YARD LAYOUT
3 OF 13

DRAWING No.:	
M08-JOP203	
FACILITY ID:	
M08	
SHEET No.:	REV:
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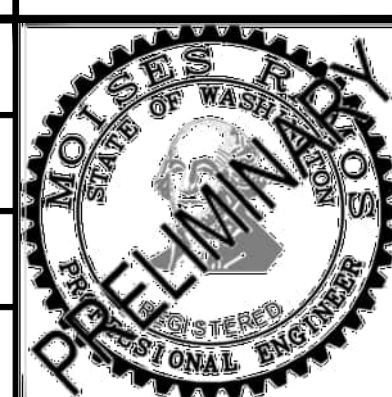
PRELIMINARY
ENGINEERING

NOT FOR
CONSTRUCTION

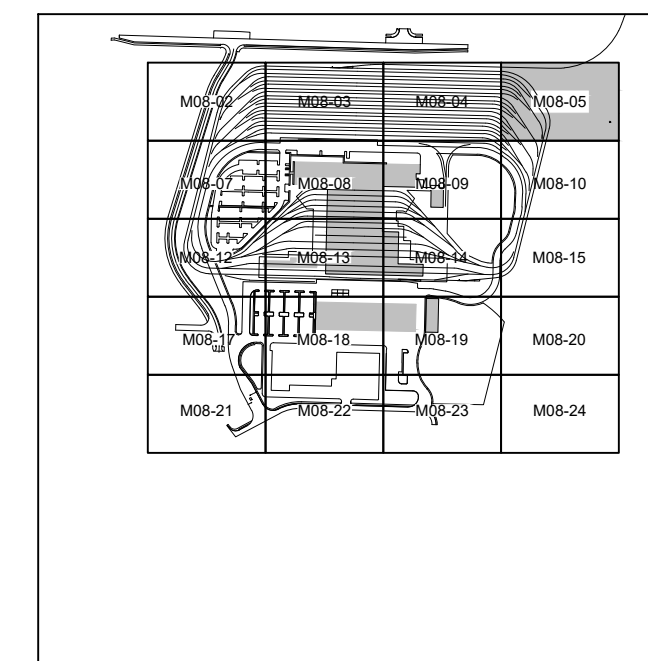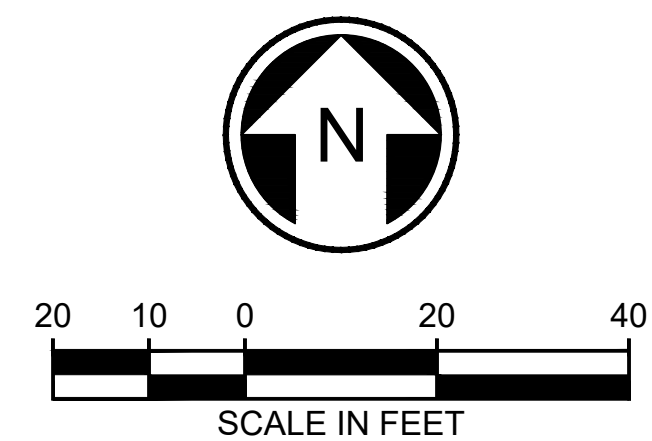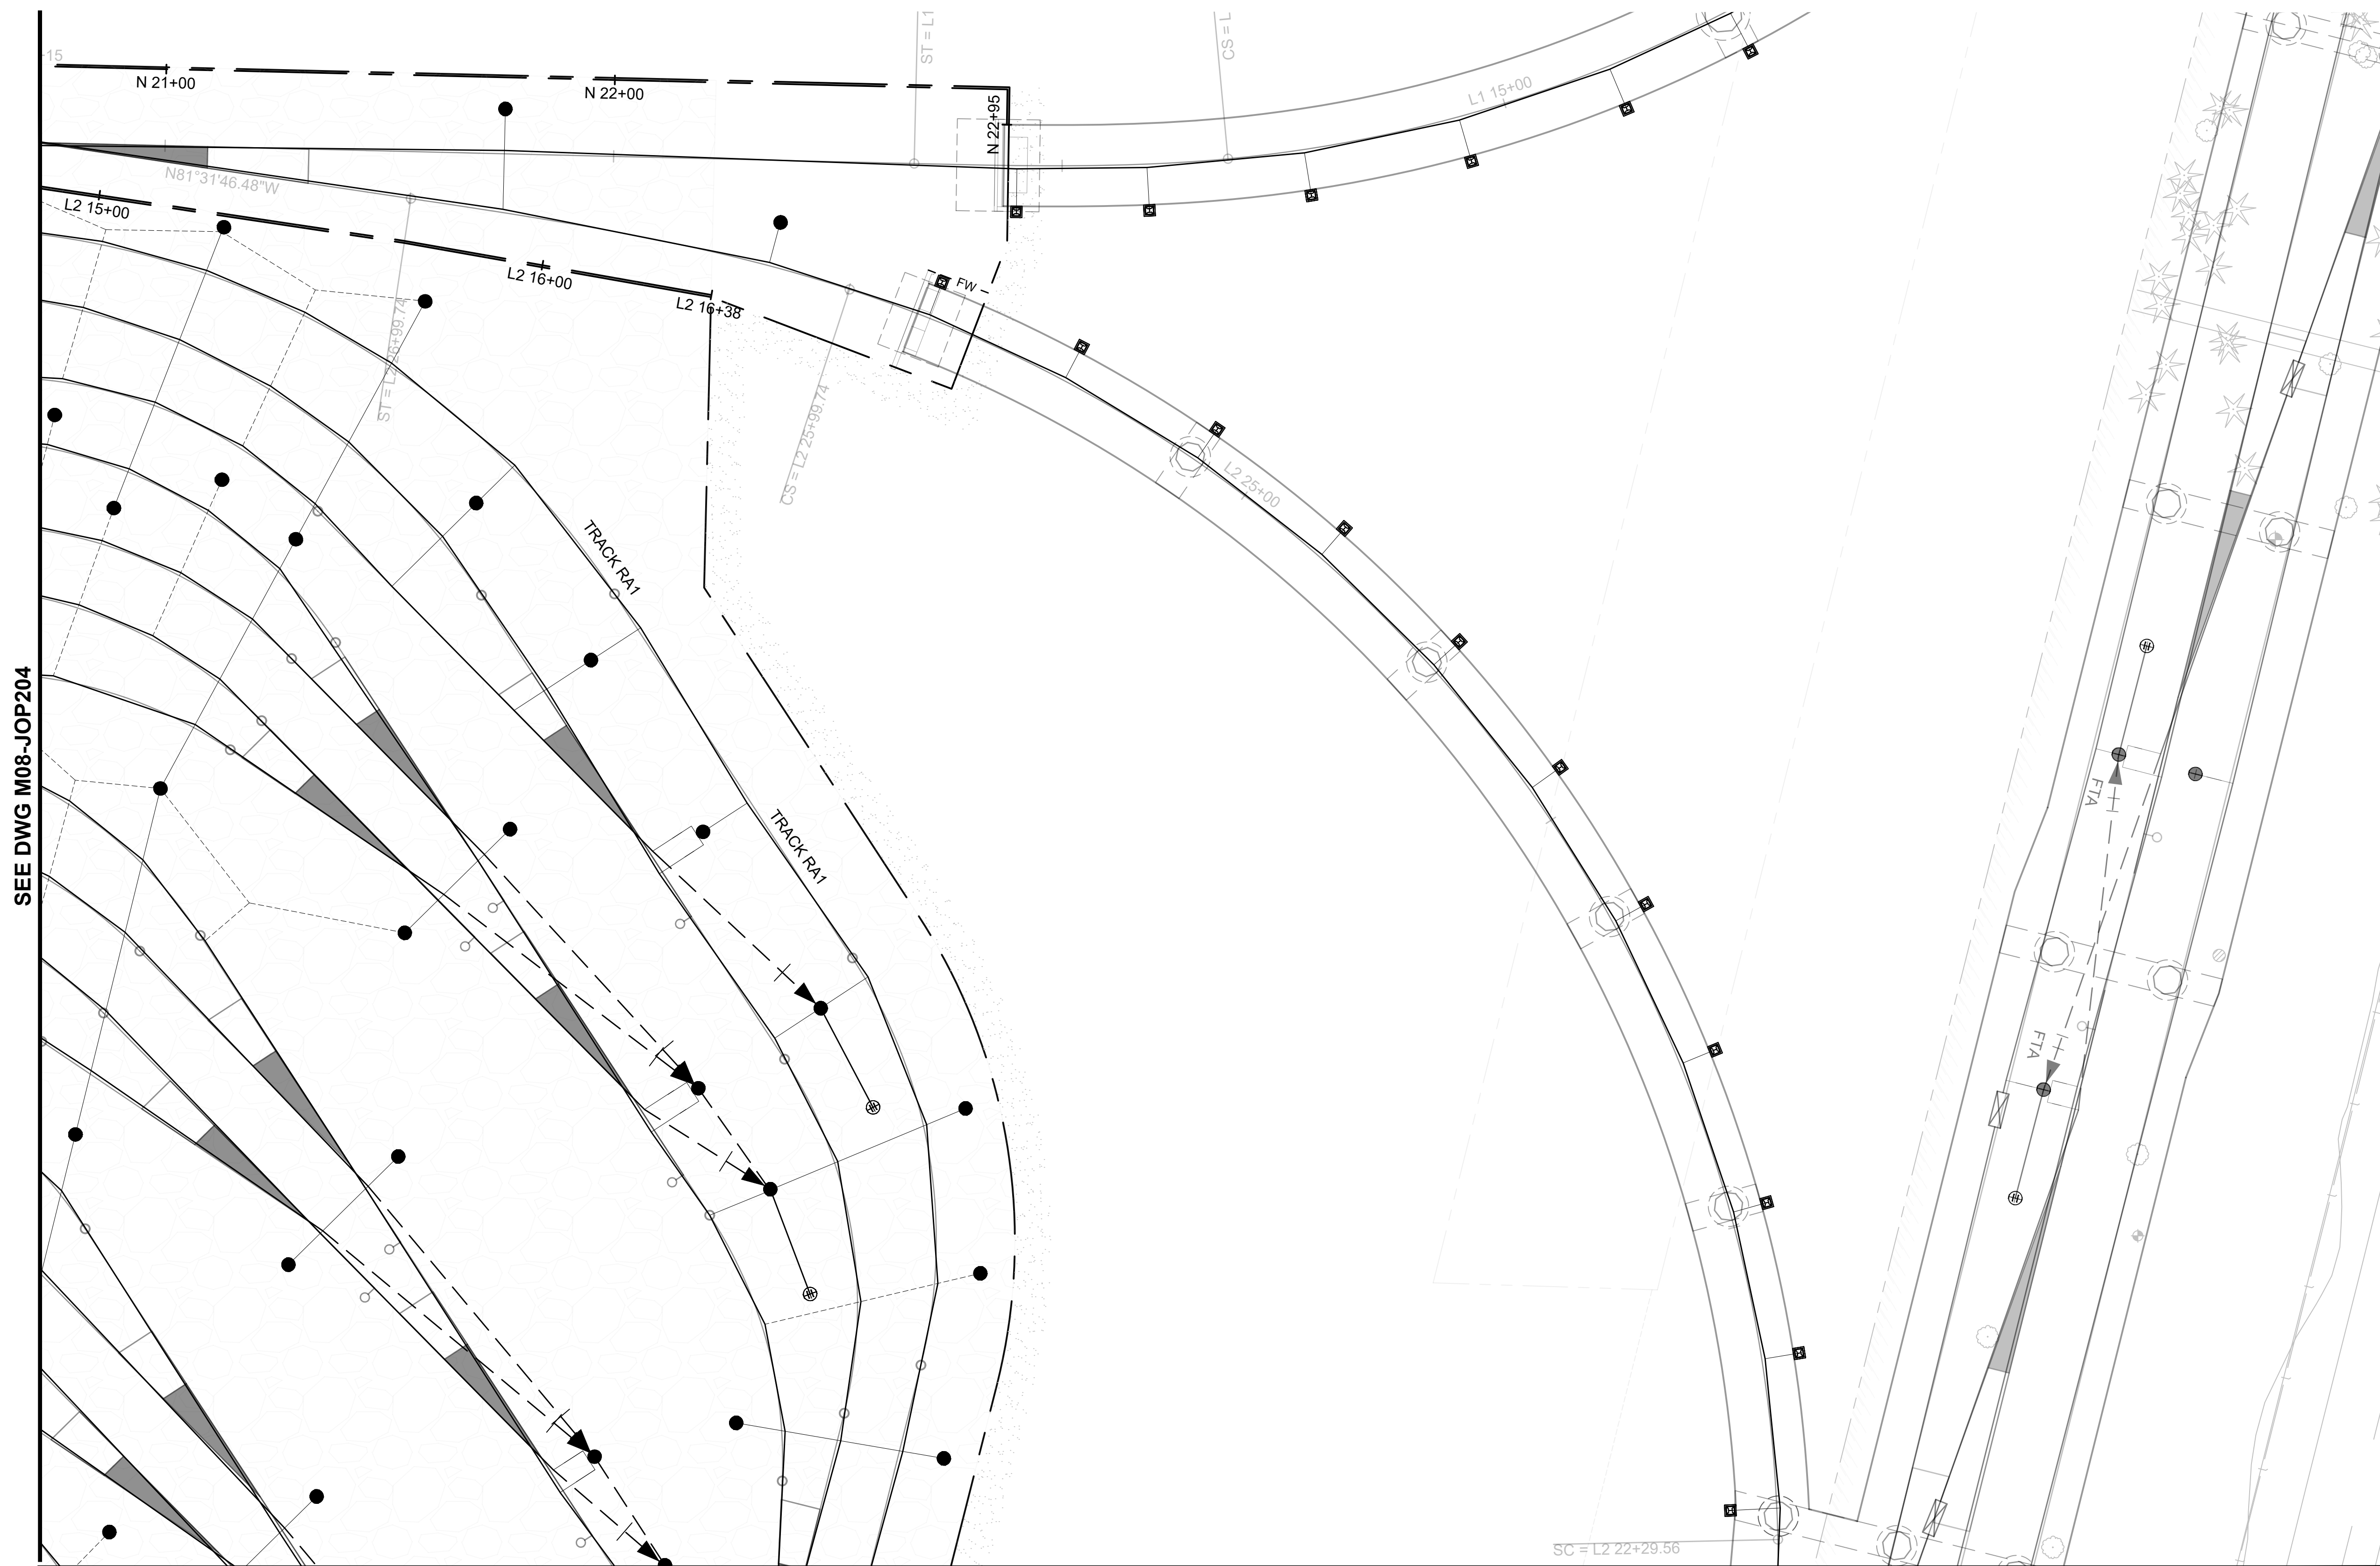*Refer to the plan set COVER drawing
for disclaimers regarding this drawing.*

REFERENCE CONCEPT DRAWINGS					
No.	DATE	DSN	CHK	APP	REVISION

DESIGNED BY:	M. RAMOS
DRAWN BY:	M. CLEMENT
CHECKED BY:	R. DEMERS
APPROVED BY:	M. RAMOS



SUBMITTED BY:	DATE:	REVIEWED BY:
PABLO LOPEZ-HILFIKER	2/27/2024	



SCALE:	1"=20'
FILENAME:	OMFS-M08-JOP200-21
CONTRACT No.:	AE-0030-17
DATE:	2/27/2024

SOUND TRANSIT
PRELIMINARY ENGINEERING PLANS
OPERATIONS & MAINTENANCE FACILITY SOUTH
OVERHEAD CONTACT SYSTEMS
YARD LAYOUT
4 OF 13

DRAWING No.:	
M08-JOP204	
FACILITY ID:	
M08	
SHEET No.:	REV:
	0

18 PL S EXTENSION

TRACK RA1

TRACK RA1

SEE DWG M08-JOP208




*Refer to the plan set COVER drawing
for disclaimers regarding this drawing.*

03/04/24 | 1:15 PM | MACLEMENT
C:\PWWWOR\KING\WEST01\ID2772713\OMFS-M08-JOP200-213.DWG

Technical drawing of a railway track layout. The drawing shows a series of tracks labeled TRACK M7, TRACK M8, TRACK M9, TRACK M10, TRACK M11, and TRACK M12, all running horizontally. To the left of these tracks is a complex arrangement of lines and points, likely representing a station or a junction. A dashed line with a cross-tick symbol is visible at the top left. The drawing is a black and white line drawing with some shaded areas.

SEE DWG M08-JOP209

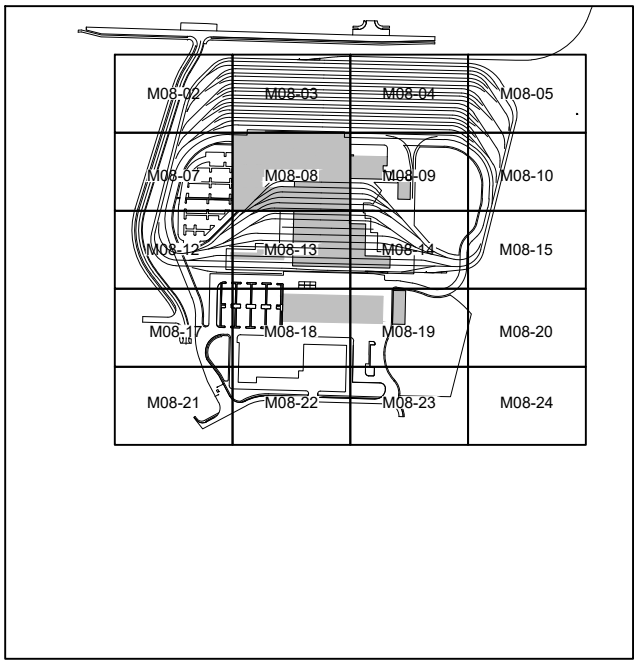



NOT FOR
CONSTRUCTION

SEE DWG M08-JOP213

03/04/24 | 1:15 PM | MACLEMENT
C:\P\WORKING\WEST01\2727273\OMFS-M08-JOP200-213.DWG

SEE DWG M08-JOP208

SEE DWG M08-JOP210

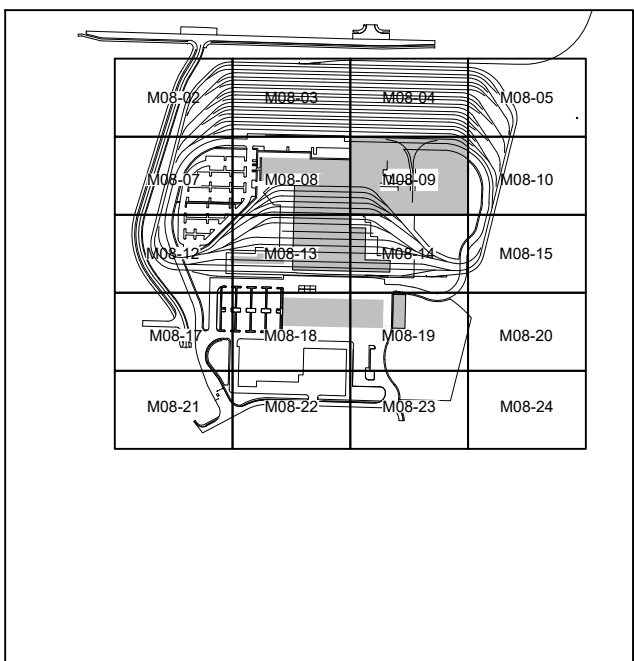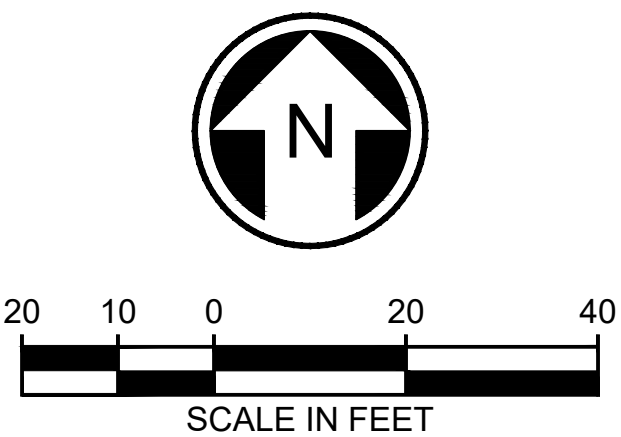


PRELIMINARY ENGINEERING

NOT FOR
CONSTRUCTION

*Refer to the plan set COVER drawing
for disclaimers regarding this drawing.*

REFERENCE CONCEPT DRAWINGS					
No.	DATE	DSN	CHK	APP	REVISION

DESIGNED BY:	M. RAMOS
DRAWN BY:	M. CLEMENT
CHECKED BY:	R. DEMERS
APPROVED BY:	M. RAMOS

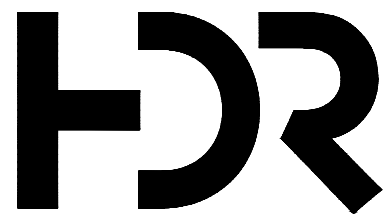

SUBMITTED BY:
PABLO LOPEZ-HILFIKER

DATE:
2/27/2024

REVIEWED BY:

LINE IS 1" AT
FILL SCALE



DATE:

PACKAGE #


SCALE:	1"=20'
FILENAME:	OMFS-M08-JOP200-213
CONTRACT No.:	AE-0030-17
DATE:	2/27/2024

SOUND TRANSIT
PRELIMINARY ENGINEERING PLANS
OPERATIONS & MAINTENANCE FACILITY SOUTH
OVERHEAD CONTACT SYSTEMS
YARD LAYOUT
7 OF 13

DRAWING No.:	
M08-JOP207	
FACILITY ID:	
M08	
SHEET No.:	REV
	0

SEE DWG M08-JOP209

A north arrow pointing upwards, enclosed in a circle, with the letter 'N' in the center. Below it is a scale bar with markings at 20, 10, 0, 20, and 40, labeled 'SCALE IN FEET'.

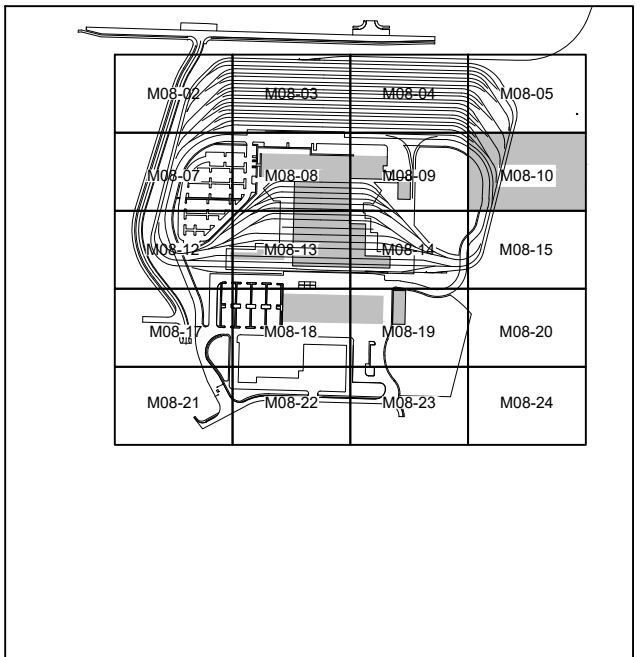



PRELIMINARY ENGINEERING

NOT FOR
CONSTRUCTION

*Refer to the plan set COVER drawing
for disclaimers regarding this drawing.*

REFERENCE CONCEPT DRAWINGS					
No.	DATE	DSN	CHK	APP	REVISION


DESIGNED BY:	M. RAMOS
DRAWN BY:	M. CLEMENT
CHECKED BY:	R. DEMERS
APPROVED BY:	M. RAMOS

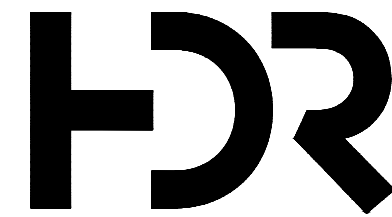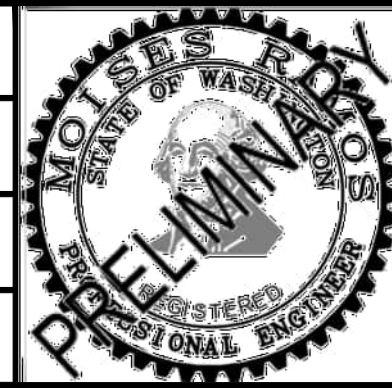

SUBMITTED BY:
PABLO LOPEZ-HILFIKER

DATE:	2/27/2024
-------	-----------

REVIEWED BY:

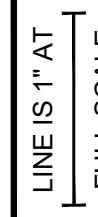

DATE:


PACKAGE #

SCALE:	1"=20'
FILENAME:	OMFS-M08-JOP200-213
CONTRACT No.:	AE-0030-17
DATE:	2/27/2024

SOUND TRANSIT
PRELIMINARY ENGINEERING PLANS
OPERATIONS & MAINTENANCE FACILITY SOUTH
OVERHEAD CONTACT SYSTEMS
YARD LAYOUT
8 OF 13

DRAWING No.:
M08-JOP208
FACILITY ID:
M08
SHEET No.: REV:
0



This is a technical architectural site plan. The drawing features a prominent curved path or boundary line that sweeps from the upper left towards the lower right. Along this curve, there are several black dots, likely representing trees or specific site markers. To the right of the main curve, there are several rectangular structures, some of which are shaded in light gray, possibly representing buildings or paved areas. Dashed lines are used throughout the plan to indicate boundaries, paths, or structural elements. A large, light gray rectangular area is visible on the right side, possibly representing a building or a large paved area. The drawing is oriented horizontally, with the curved path running from the top left towards the bottom right.

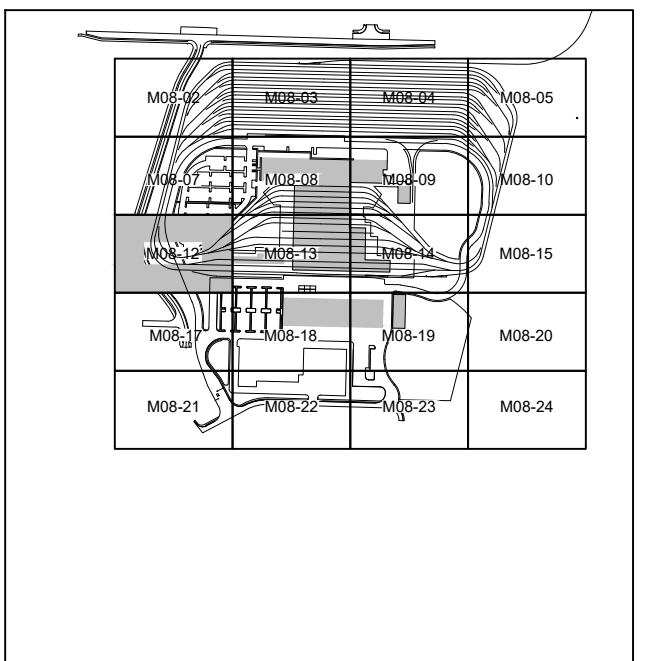

NOT FOR
CONSTRUCTION

SEE DWG M08-JOP217

DESIGNED BY:	M. RAMOS
DRAWN BY:	M. CLEMENT
CHECKED BY:	R. DEMERS
APPROVED BY:	M. RAMOS

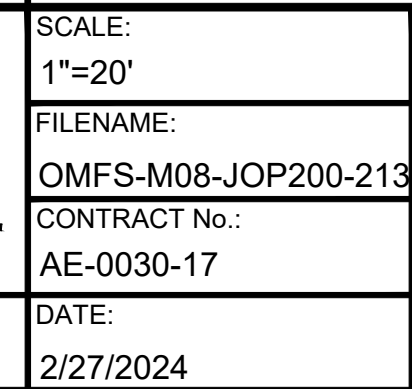
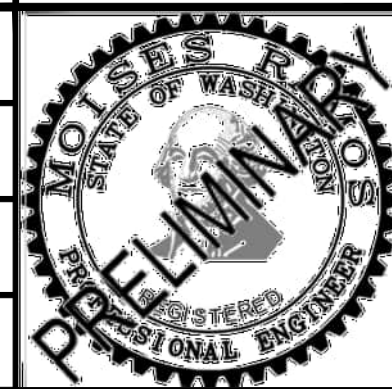


DRAWING No.:	
M08-JOP209	
FACILITY ID:	
M08	
SHEET No.:	REV:
	0

03/04/24 | 1:15 PM | MACLEMENT

SEE DWG M08-JOP212

SEE DWG M08-JOP214

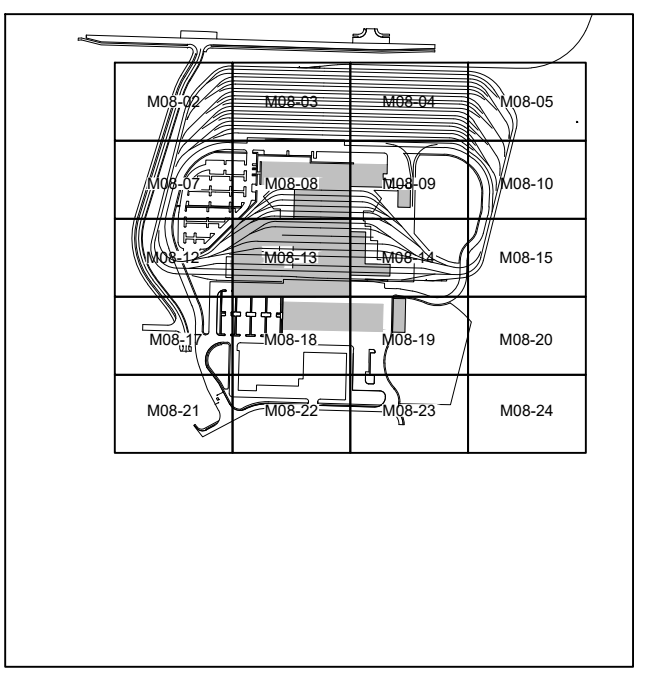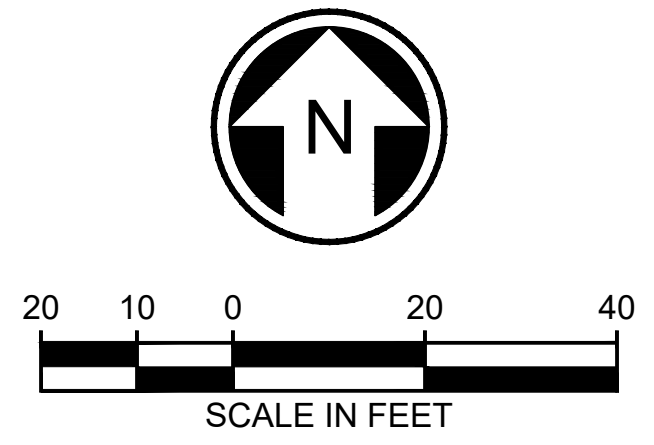



PRELIMINARY
ENGINEERING

NOT FOR
CONSTRUCTION

AHJ:						PACKAGE #						
					LINE IS " AT FULL SCALE		SCALE: 1"=20'	SOUND TRANSIT PRELIMINARY ENGINEERING PLANS OPERATIONS & MAINTENANCE FACILITY SOUTH OVERHEAD CONTACT SYSTEMS YARD LAYOUT 10 OF 13				DRAWING No.: M08-JOP210
							FILENAME: OMFS-M08-JOP200-213					FACILITY ID: M08
							CONTRACT No.: AE-0030-17					SHEET No.: REV:
							DATE: 2/27/2024					0
SUBMITTED BY: PABLO LOPEZ-HILFIKER		DATE: 2/27/2024		REVIEWED BY:		DATE:						

SEE DWG M08-JOP213



SEE DWG M08-JOP215

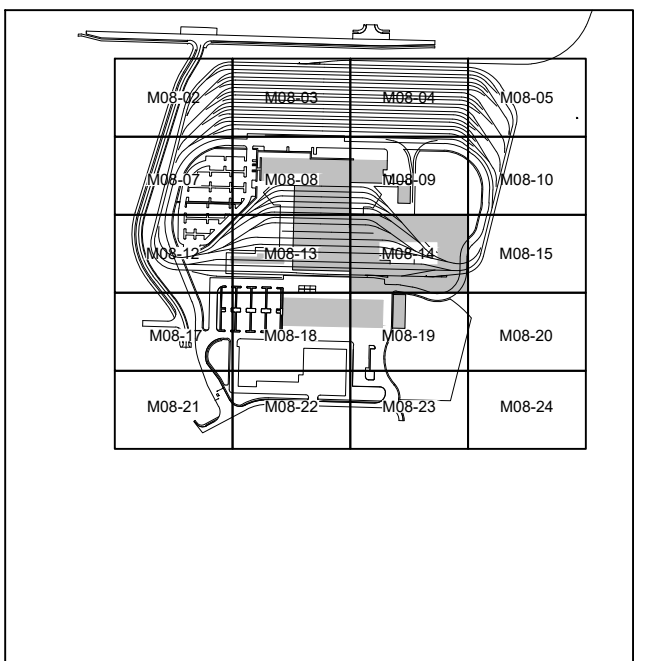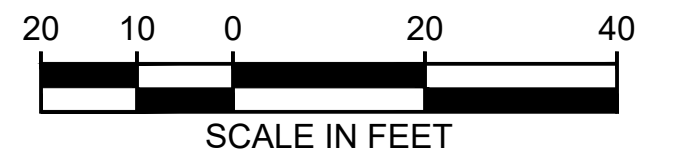

NOT FOR
CONSTRUCTION

*Refer to the plan set COVER drawing
for disclaimers regarding this drawing.*

DESIGNED BY:	M. RAMOS
DRAWN BY:	M. CLEMENT
CHECKED BY:	R. DEMERS
APPROVED BY:	M. RAMOS

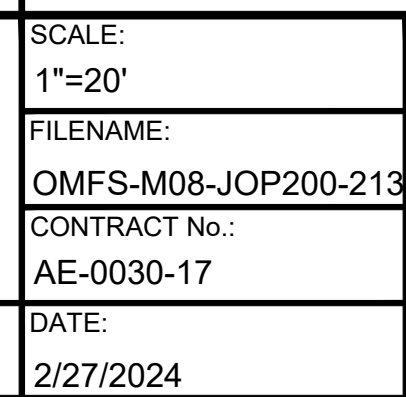
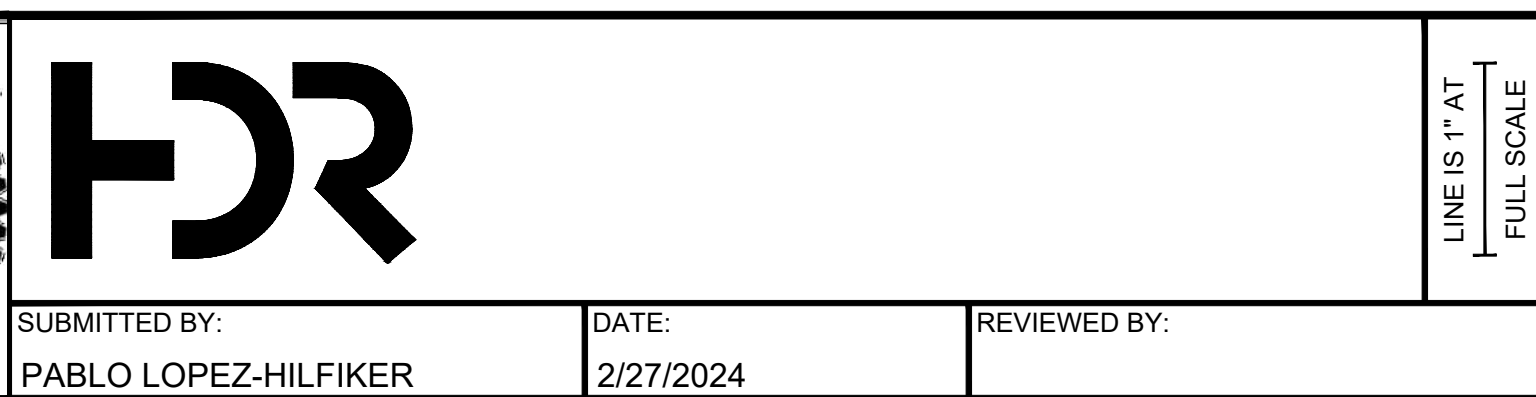


DRAWING No.:	
M08-JOP211	
FACILITY ID:	
M08	
SHEET No.:	REV:
	0

03/04/24 | 1:15 PM | MACLEMENT




SEE DWG M08-JOP217

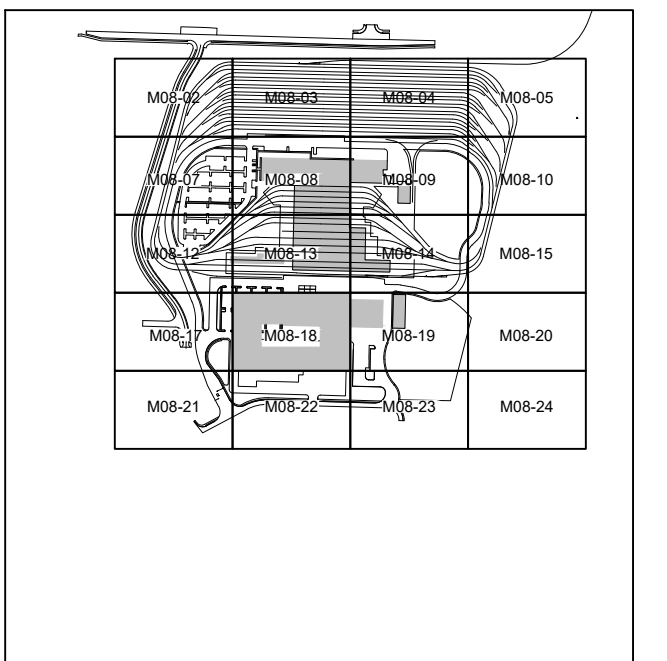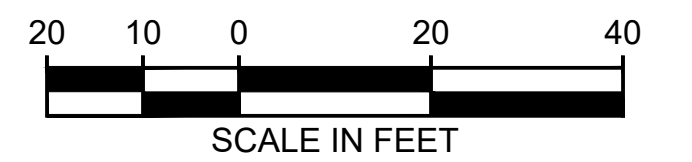SEE DWG M08-JOP219



PRELIMINARY
ENGINEERING

NOT FOR
CONSTRUCTION

*Refer to the plan set COVER drawing
for disclaimers regarding this drawing.*




Refer to the plan set COVER drawing for disclaimers regarding this drawing.										AHJ:										PACKAGE #																																		
REFERENCE CONCEPT DRAWINGS										DESIGNED BY: M. RAMOS					<div><div></div><div></div><div><div>LINE IS 1" AT FULL SCALE</div><div></div></div></div>										SCALE: 1"=20'					<div><div>SOUND TRANSIT</div><div>PRELIMINARY ENGINEERING PLANS</div><div>OPERATIONS & MAINTENANCE FACILITY SOUTH</div><div>OVERHEAD CONTACT SYSTEMS</div><div>YARD LAYOUT</div><div>13 OF 13</div></div>										DRAWING No.: M08-JOP213														
										DRAWN BY: M. CLEMENT															FILENAME: OMFS-M08-JOP200-213															FACILITY ID: M08														
										CHECKED BY: R. DEMERS															CONTRACT No.: AE-0030-17															SHEET No.: REV:														
										APPROVED BY: M. RAMOS															SUBMITTED BY: PABLO LOPEZ-HILFIKER															DATE: 2/27/2024					REVIEWED BY:					DATE: 2/27/2024				
										No.															DATE															DSN					CHK					APP				

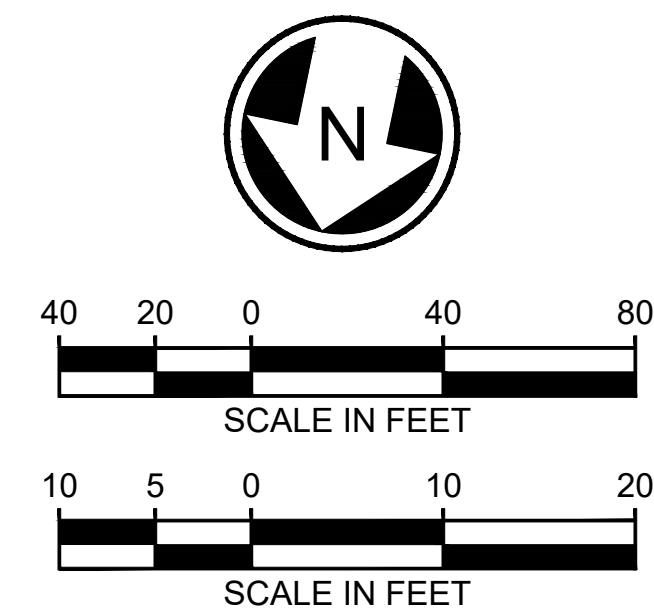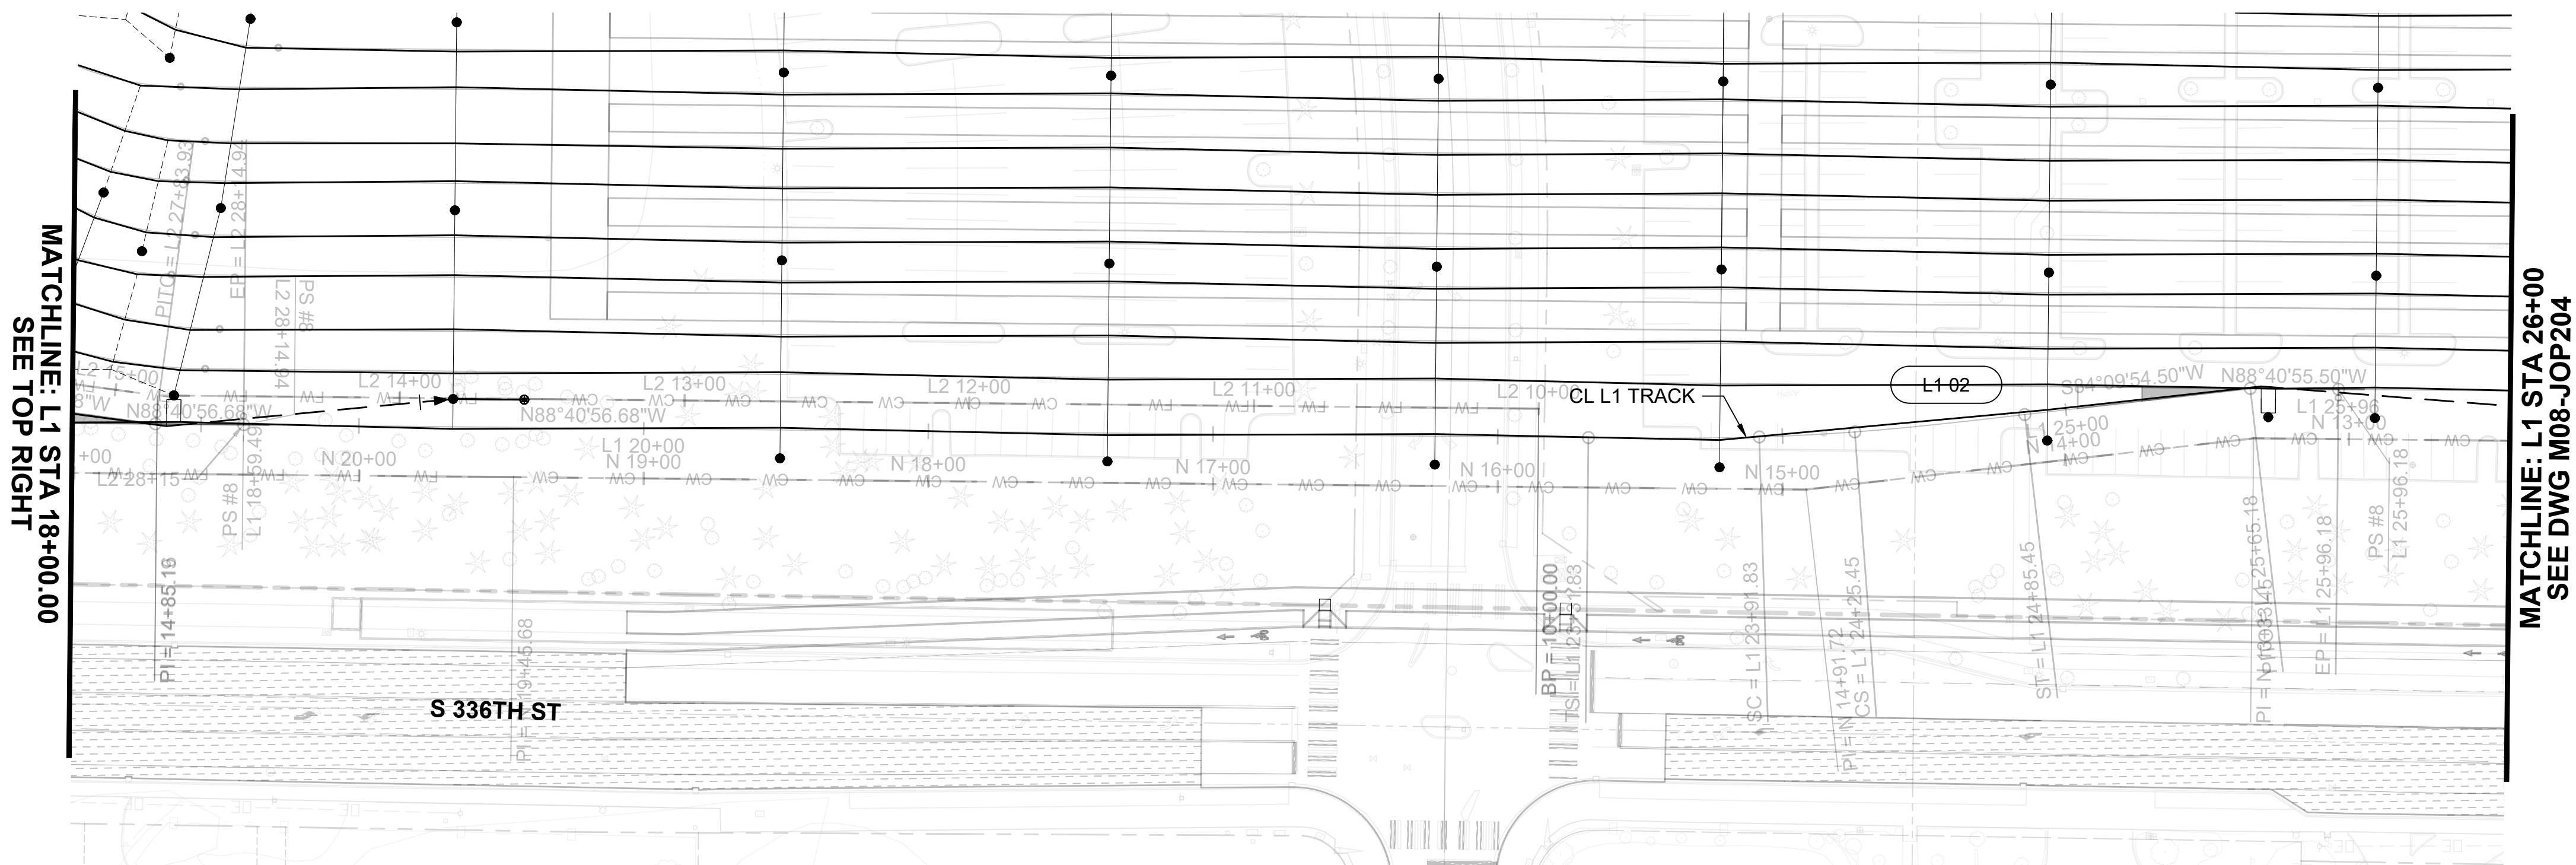
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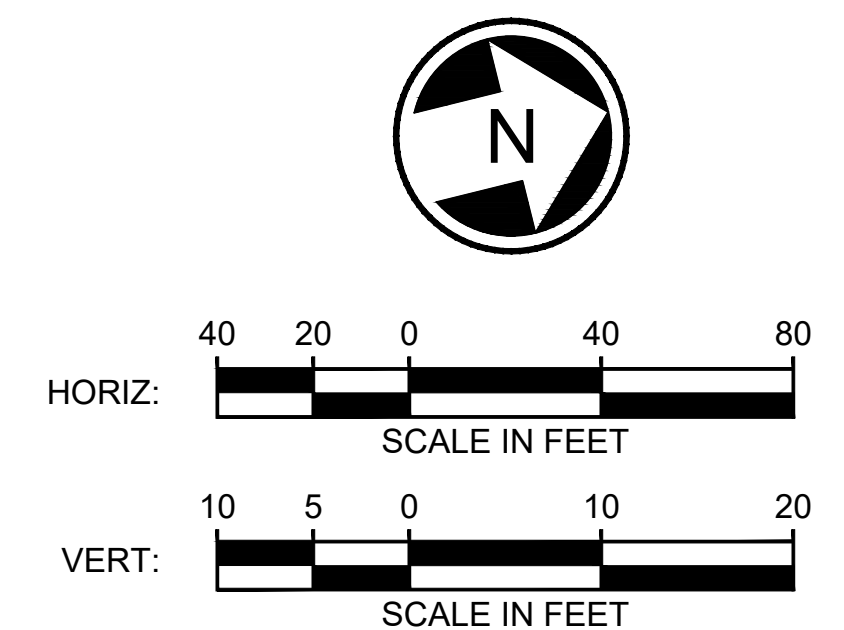
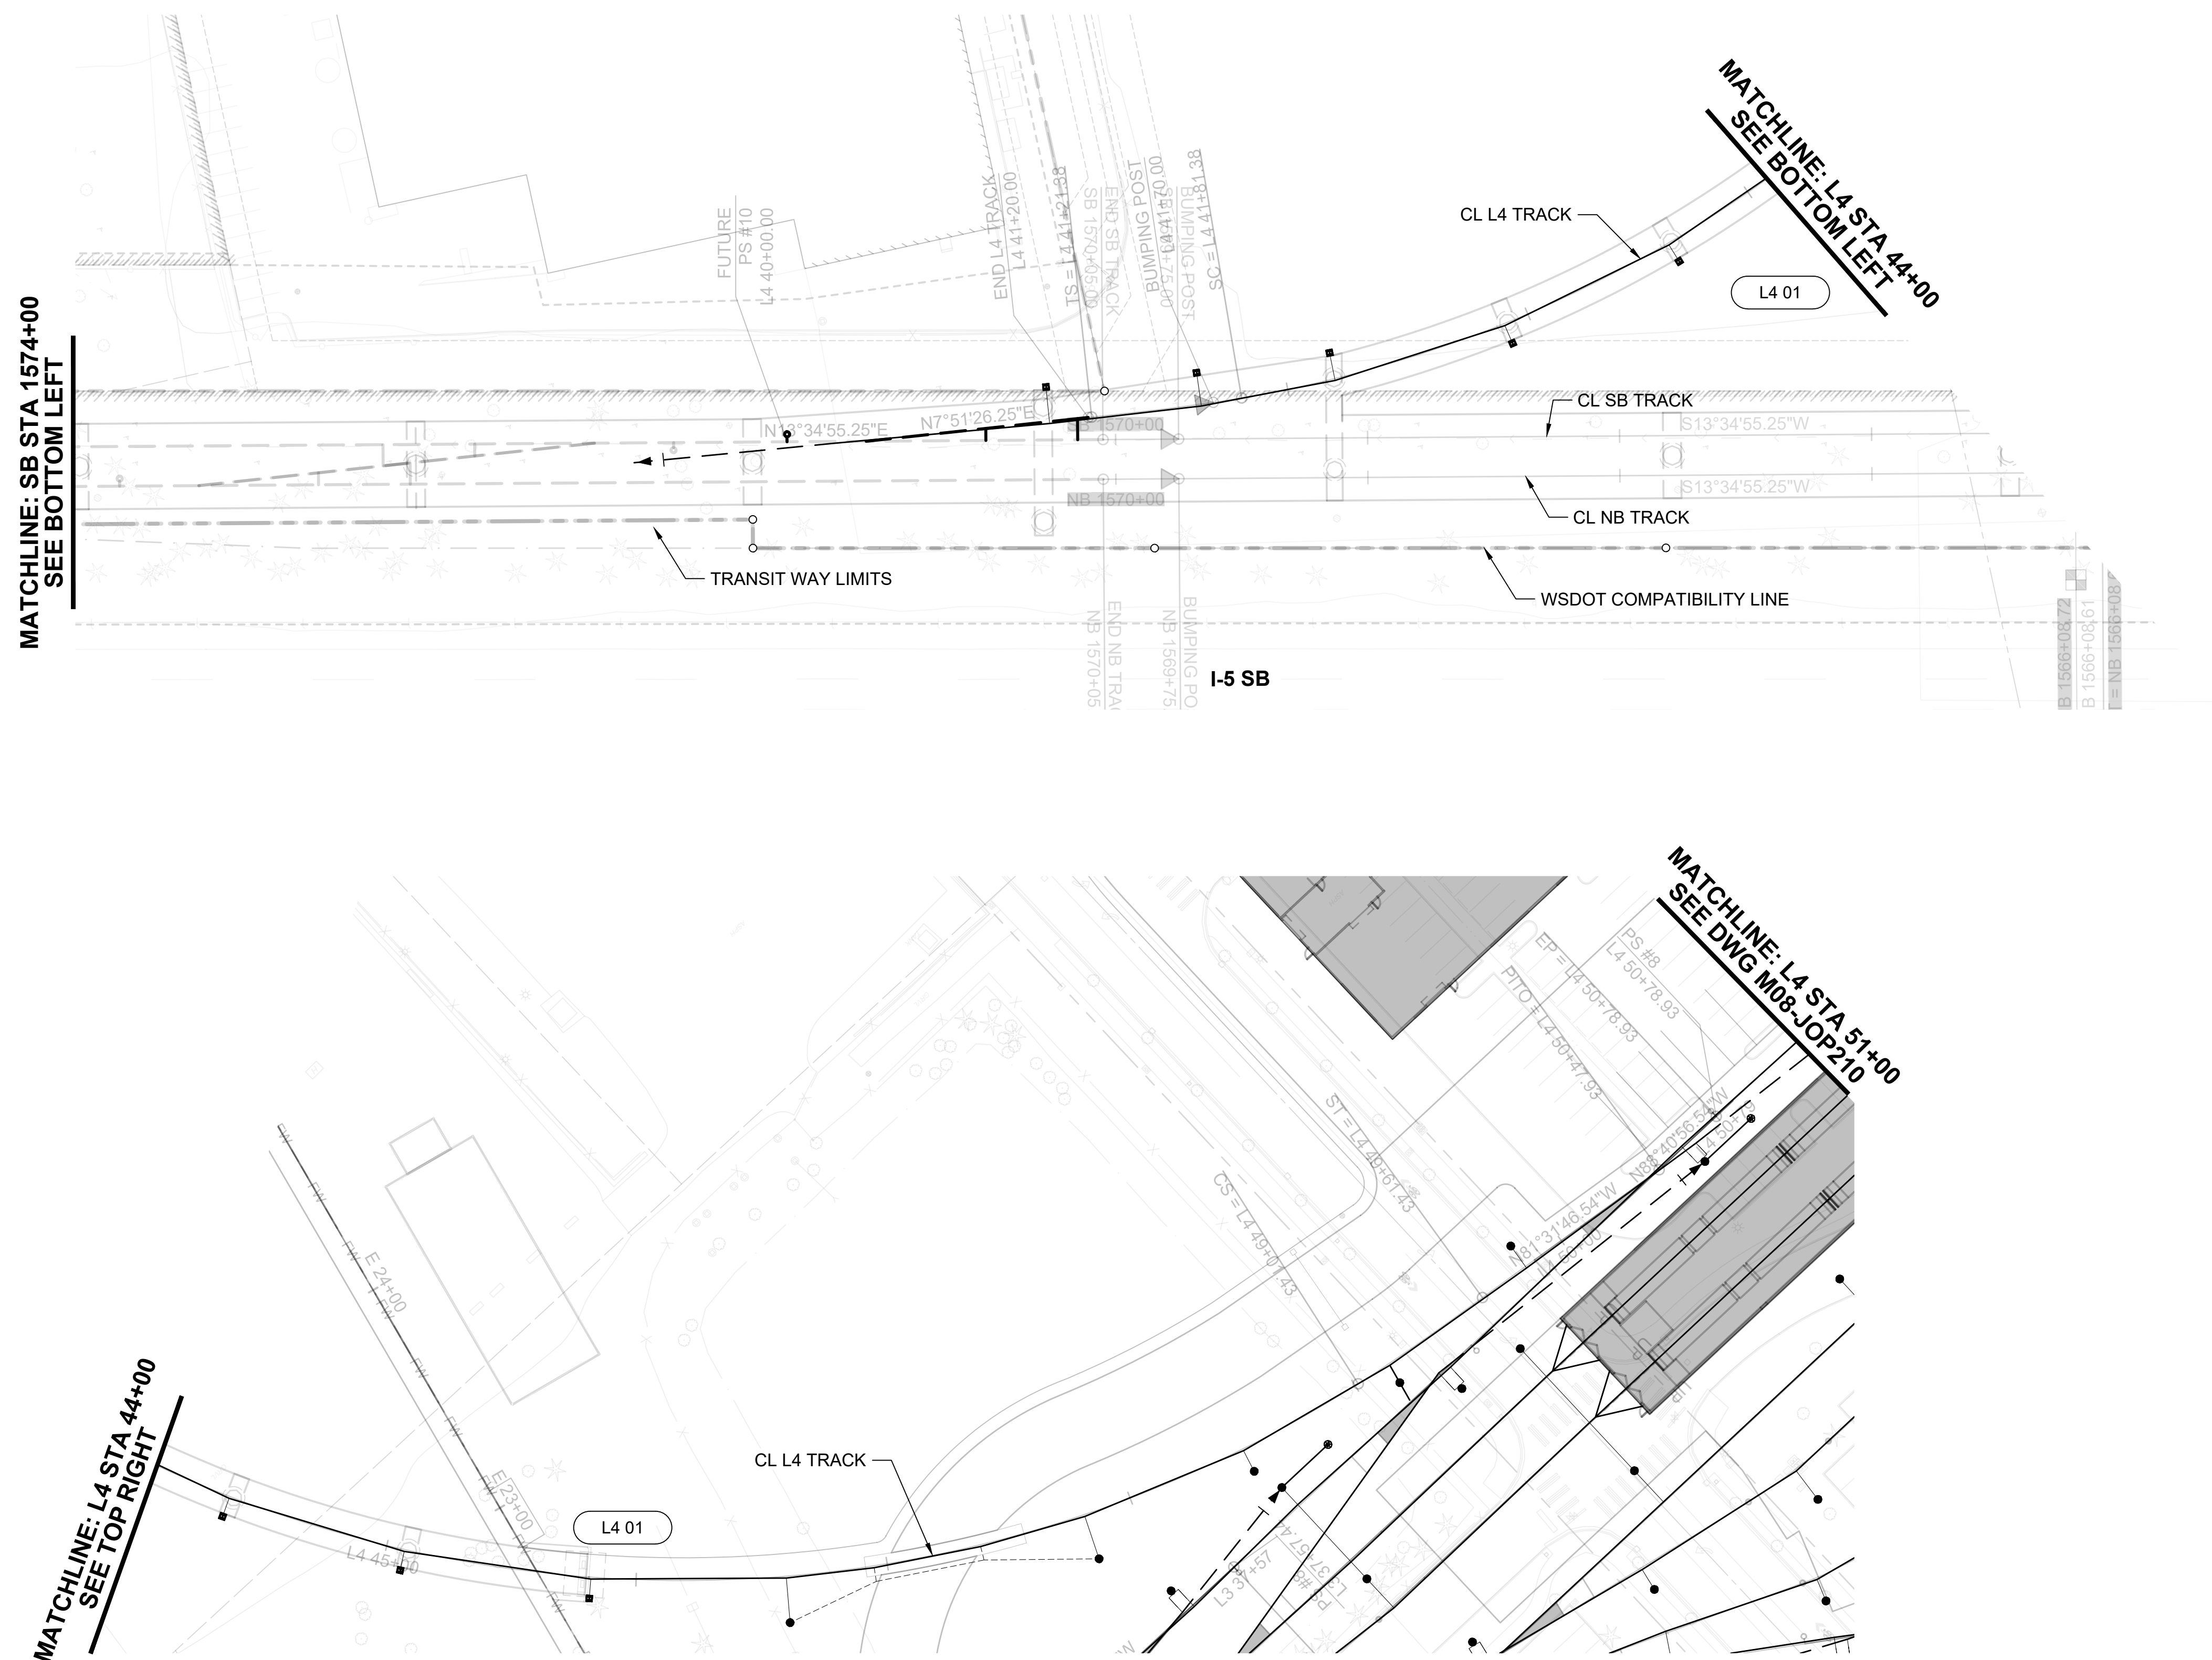
NOT FOR
CONSTRUCTION

*Refer to the plan set COVER drawing
for disclaimers regarding this drawing.*

REFERENCE CONCEPT DRAWINGS						DESIGNED BY: M. RAMOS	  <div style="text-align: center;">LINE IS 1" AT FULL SCALE</div> 	SCALE: 1"=40'	SOUND TRANSIT PRELIMINARY ENGINEERING PLANS OPERATIONS & MAINTENANCE FACILITY SOUTH OVERHEAD CONTACT SYSTEMS LEAD TRACK L1 LAYOUT L1 STA 10+00 TO 25+96.12	DRAWING No.: M08-JOP300
						DRAWN BY: M. CLEMENT		FILENAME: OMFS-M08-JOP300-303		FACILITY ID: M08
						CHECKED BY: R. DEMERS		CONTRACT No.: AE-0030-17		SHEET No.: REV:
						APPROVED BY:		DATE:		
No.	DATE	DSN	CHK	APP	REVISION	M. RAMOS		2/27/2024		2/27/2024
						PABLO LOPEZ-HILFIKER	2/27/2024			0



Refer to the plan set COVER drawing
for disclaimers regarding this drawing.

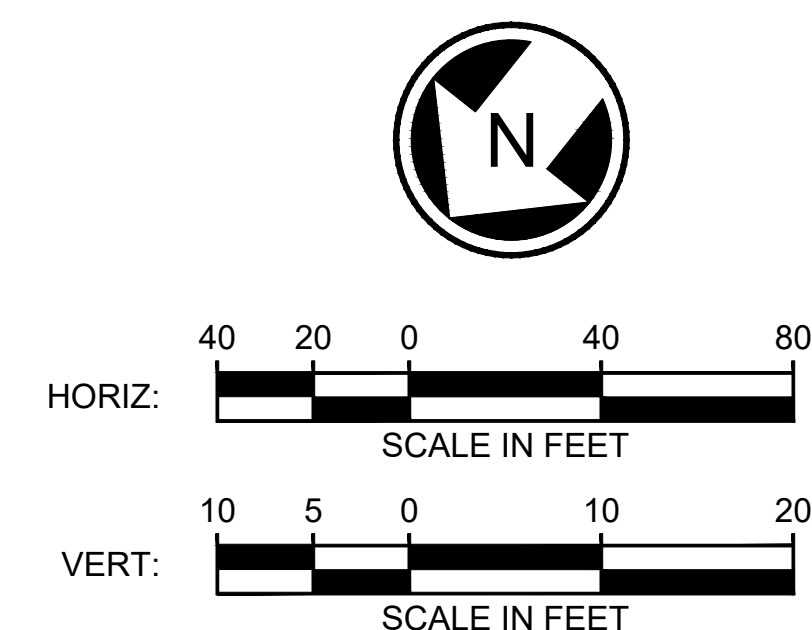

NOT FOR
CONSTRUCTION



[illegible]

1. VENDOR WILL PROVIDE SHOP DRAWING NUMBER.



NOT FOR
CONSTRUCTION

DESIGNED BY:	M. RAMOS
DRAWN BY:	M. CLEMENT
CHECKED BY:	R. DEMERS
APPROVED BY:	M. RAMOS

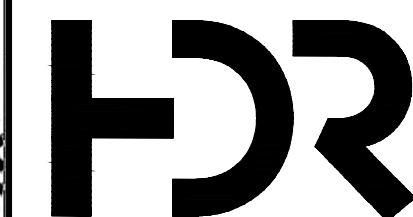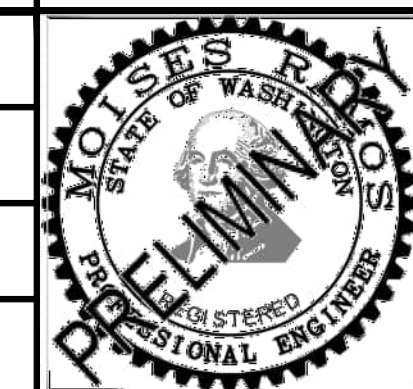

LINE IS 1" AT




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FILENAME:	OMFS-M08-JOD102
CONTRACT No.:	AE-0030-17
DATE:	2/27/2024

SOUND TRANSIT
PRELIMINARY ENGINEERING PLANS
OPERATIONS & MAINTENANCE FACILITY SOUTH

OVERHEAD CONTACT SYSTEMS
CANTILEVER - YARD - LONG REACH
CL-03L, M, H

DRAWING No.:
M08-JOD405
FACILITY ID:
M08
SHEET No.: REV:
0



02/23/24 | 11:11 AM | MSHEPPARD
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Refer to the plan set COVER drawing
for disclaimers regarding this drawing.

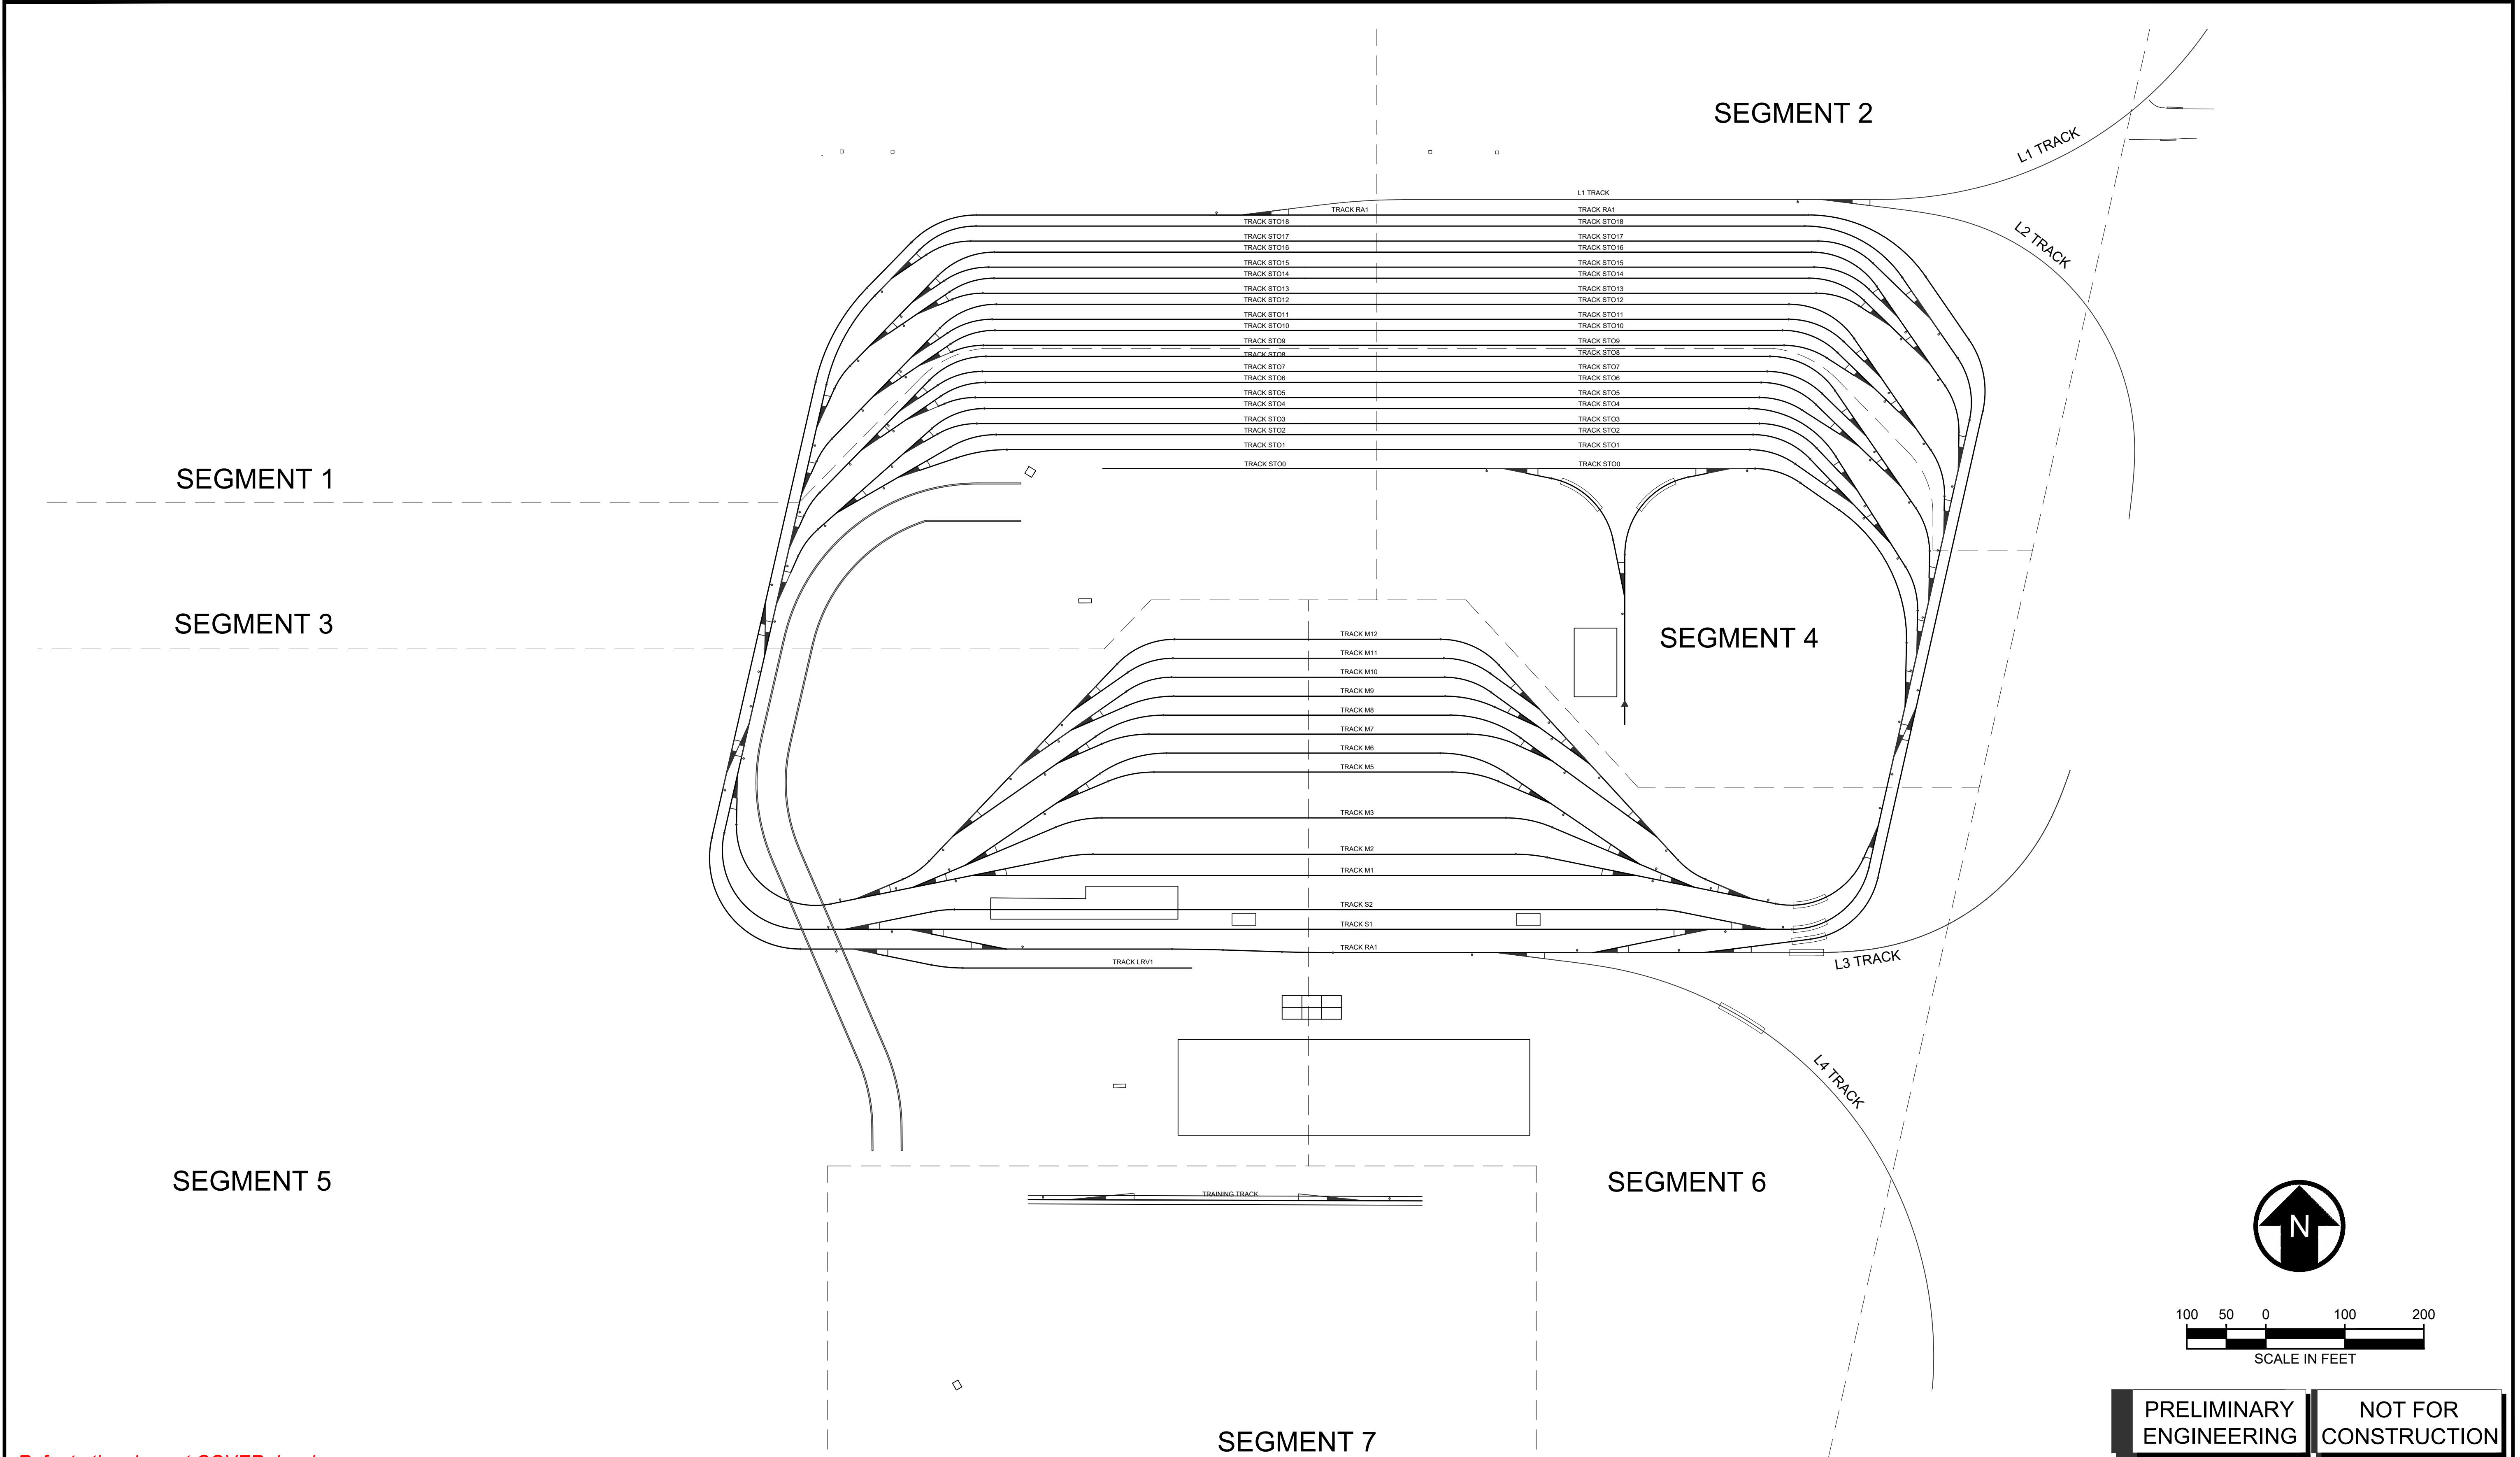REFERENCE CONCEPT DRAWINGS						DESIGNED BY:									SCALE:						DRAWING No.: Y03-JSP001																																																																																																																																																																																																																																																																																																																																																																																																																																																																																																																																																		
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APPROVED BY:	DATE:	REVIEWED BY:	DATE:	SOUND TRANSIT PRELIMINARY ENGINEERING PLANS OPERATIONS & MAINTENANCE FACILITY SOUTH				FACILITY ID:																																																																																																																																																																																																																																																																																																																																																																																																																																																																																																																																																															
J. CANTWELL	2/27/2024							Y03																																																																																																																																																																																																																																																																																																																																																																																																																																																																																																																																																															
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PRELIMINARY
ENGINEERING

NOT FOR
CONSTRUCTION

Refer to the plan set COVER drawing
for disclaimers regarding this drawing.



REFERENCE CONCEPT DRAWINGS

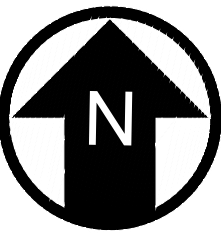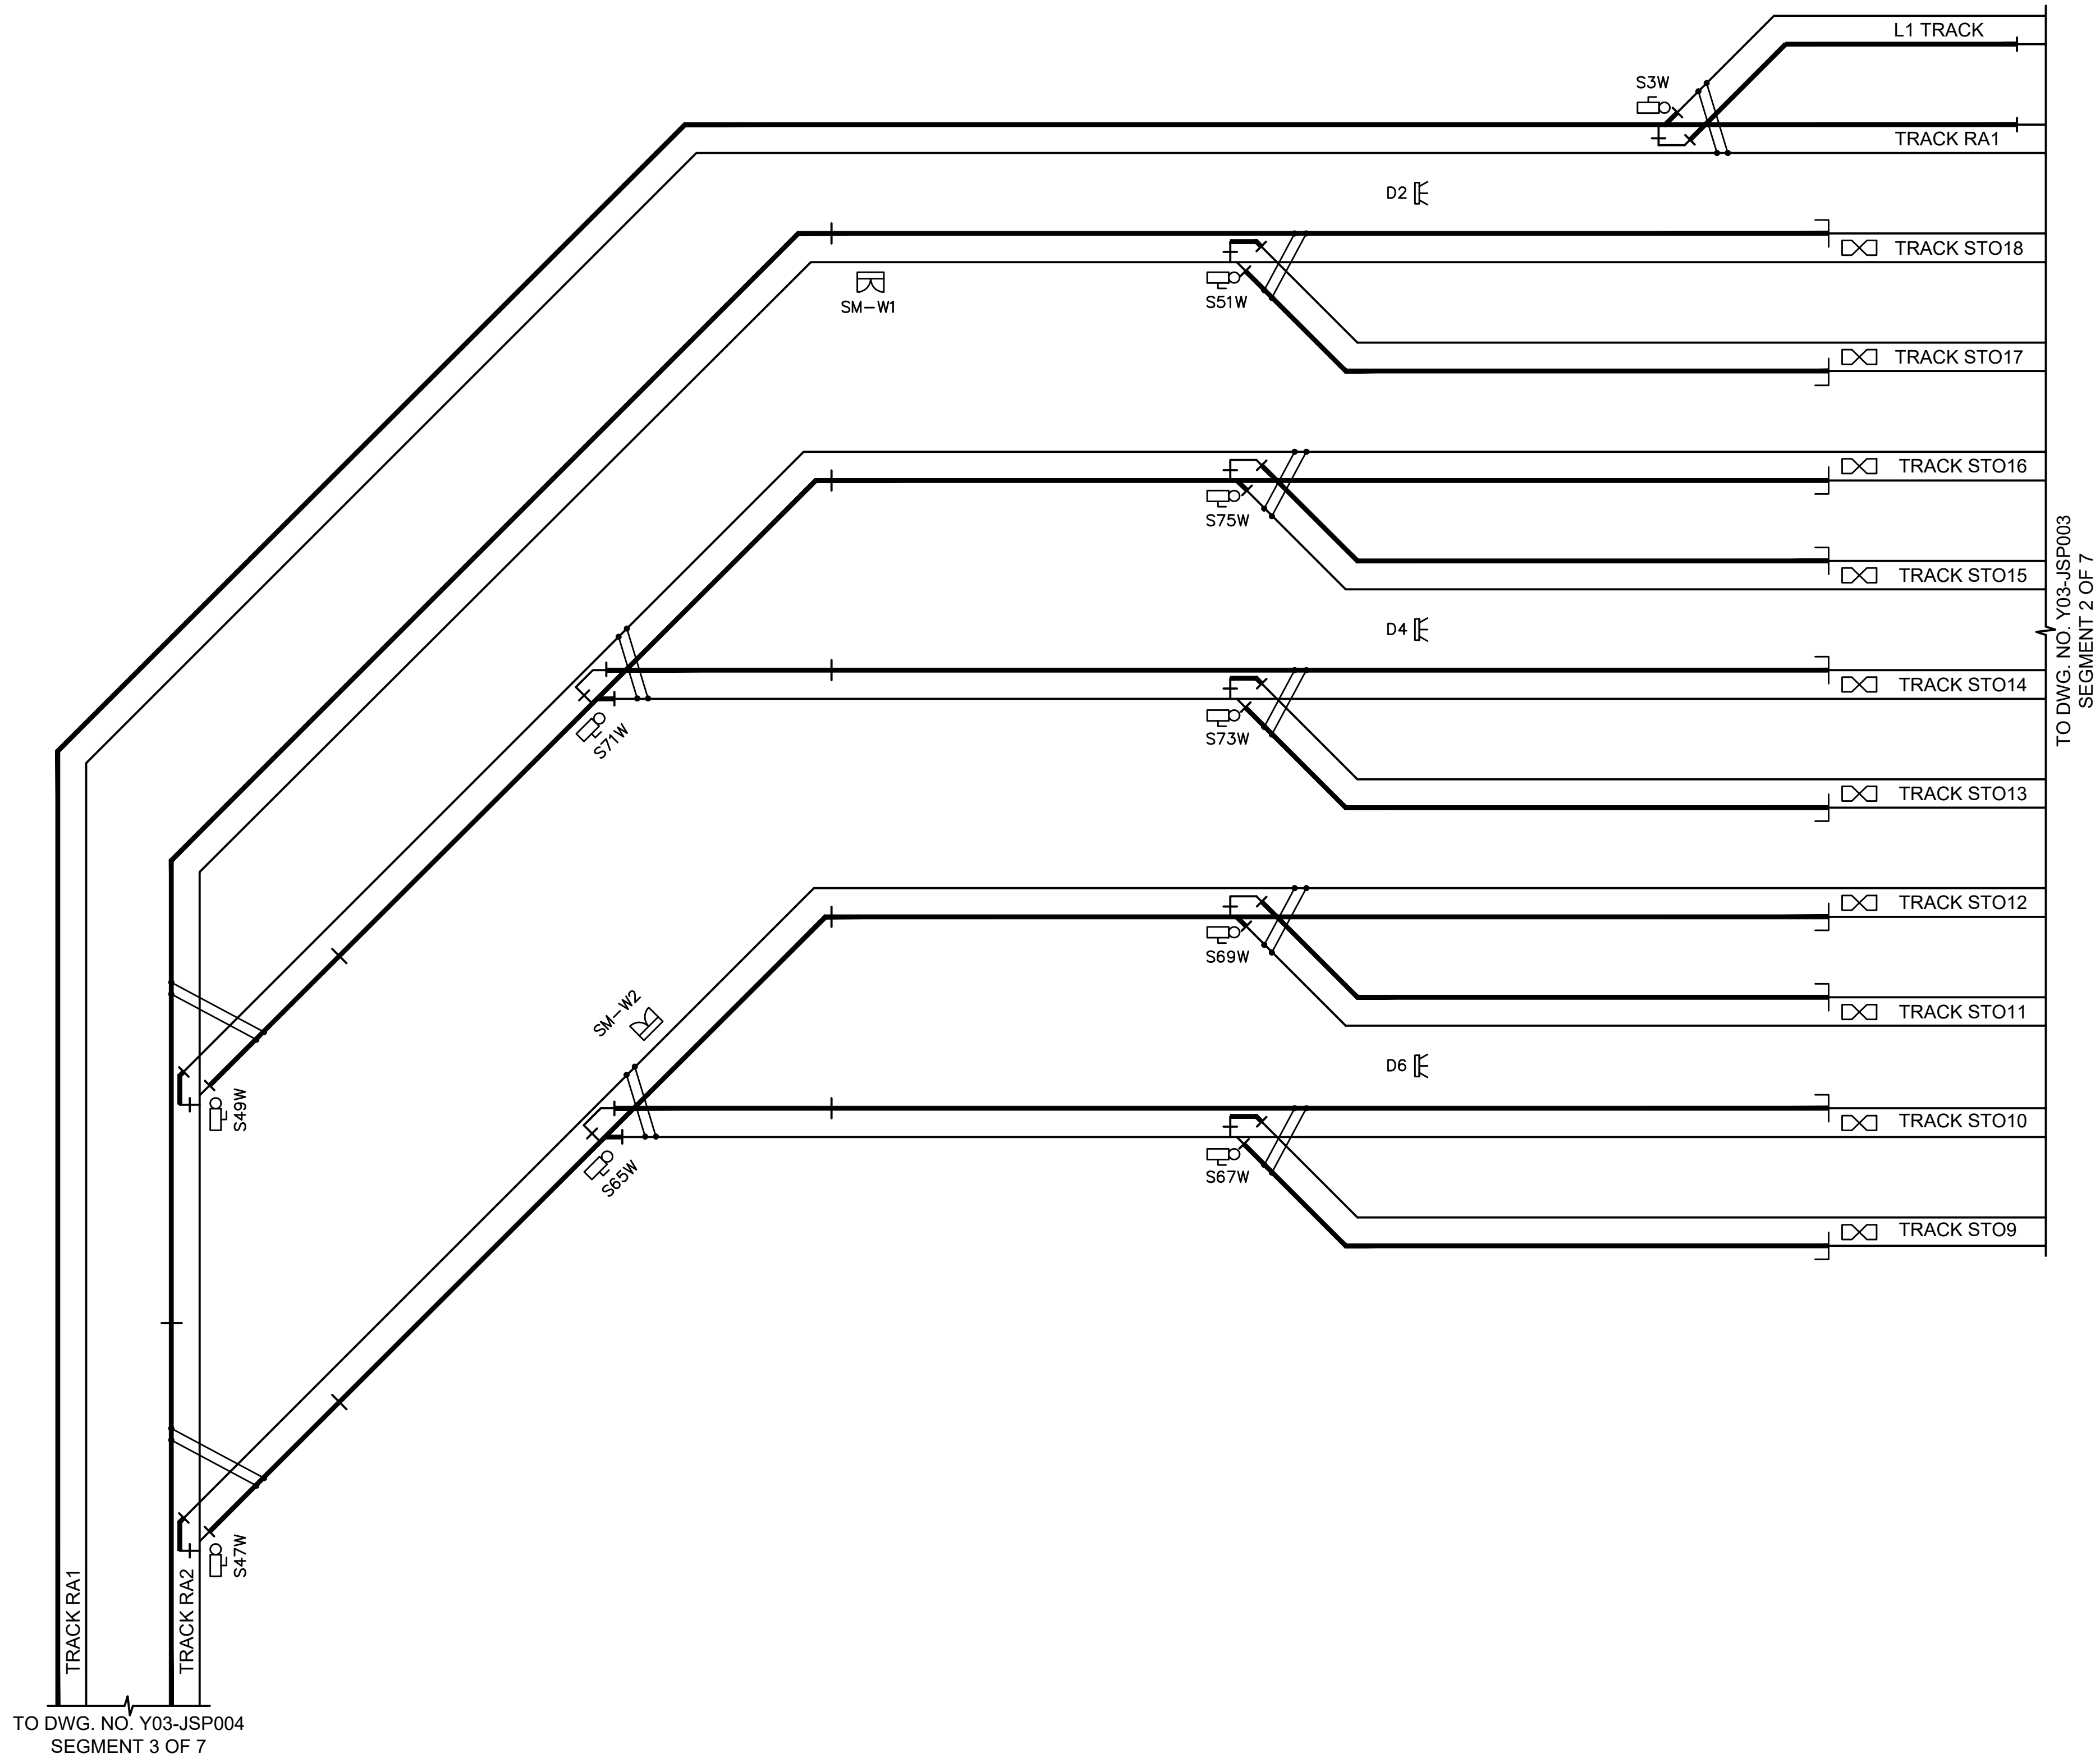No.	DATE	DSN	CHK	APP	REVISION

DESIGNED BY:	S. EDELMAN
DRAWN BY:	M. SHEPPARD
CHECKED BY:	A. EDLEMAN
APPROVED BY:	J. CANTWELL

AHJ:				PACKAGE #				
	 Burns <small>BURNS ENGINEERING, INC. 215 978-7700 TWO COMMERCE SQUARE, 2001 MARKET ST, SUITE 600 PHILADELPHIA, PA 19106</small>			<div>LINE IS "A" AT FULL SCALE</div>	SCALE: NTS	SOUND TRANSIT PRELIMINARY ENGINEERING PLANS OPERATIONS & MAINTENANCE FACILITY SOUTH SIGNALS SYSTEM YARD DOUBLE LINE TRACK PLAN SEGMENT 1 OF 7	DRAWING No.: Y03-JSP002	
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					CONTRACT No.: AE0030-17		SHEET No.: REV:	
					DATE:		0	
	SUBMITTED BY: PABLO LOPEZ-HILFIKER		DATE: 2/27/2024	REVIEWED BY:			DATE:	

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ENGINEERING
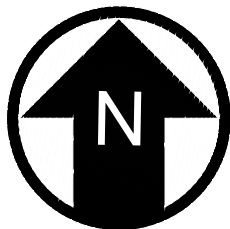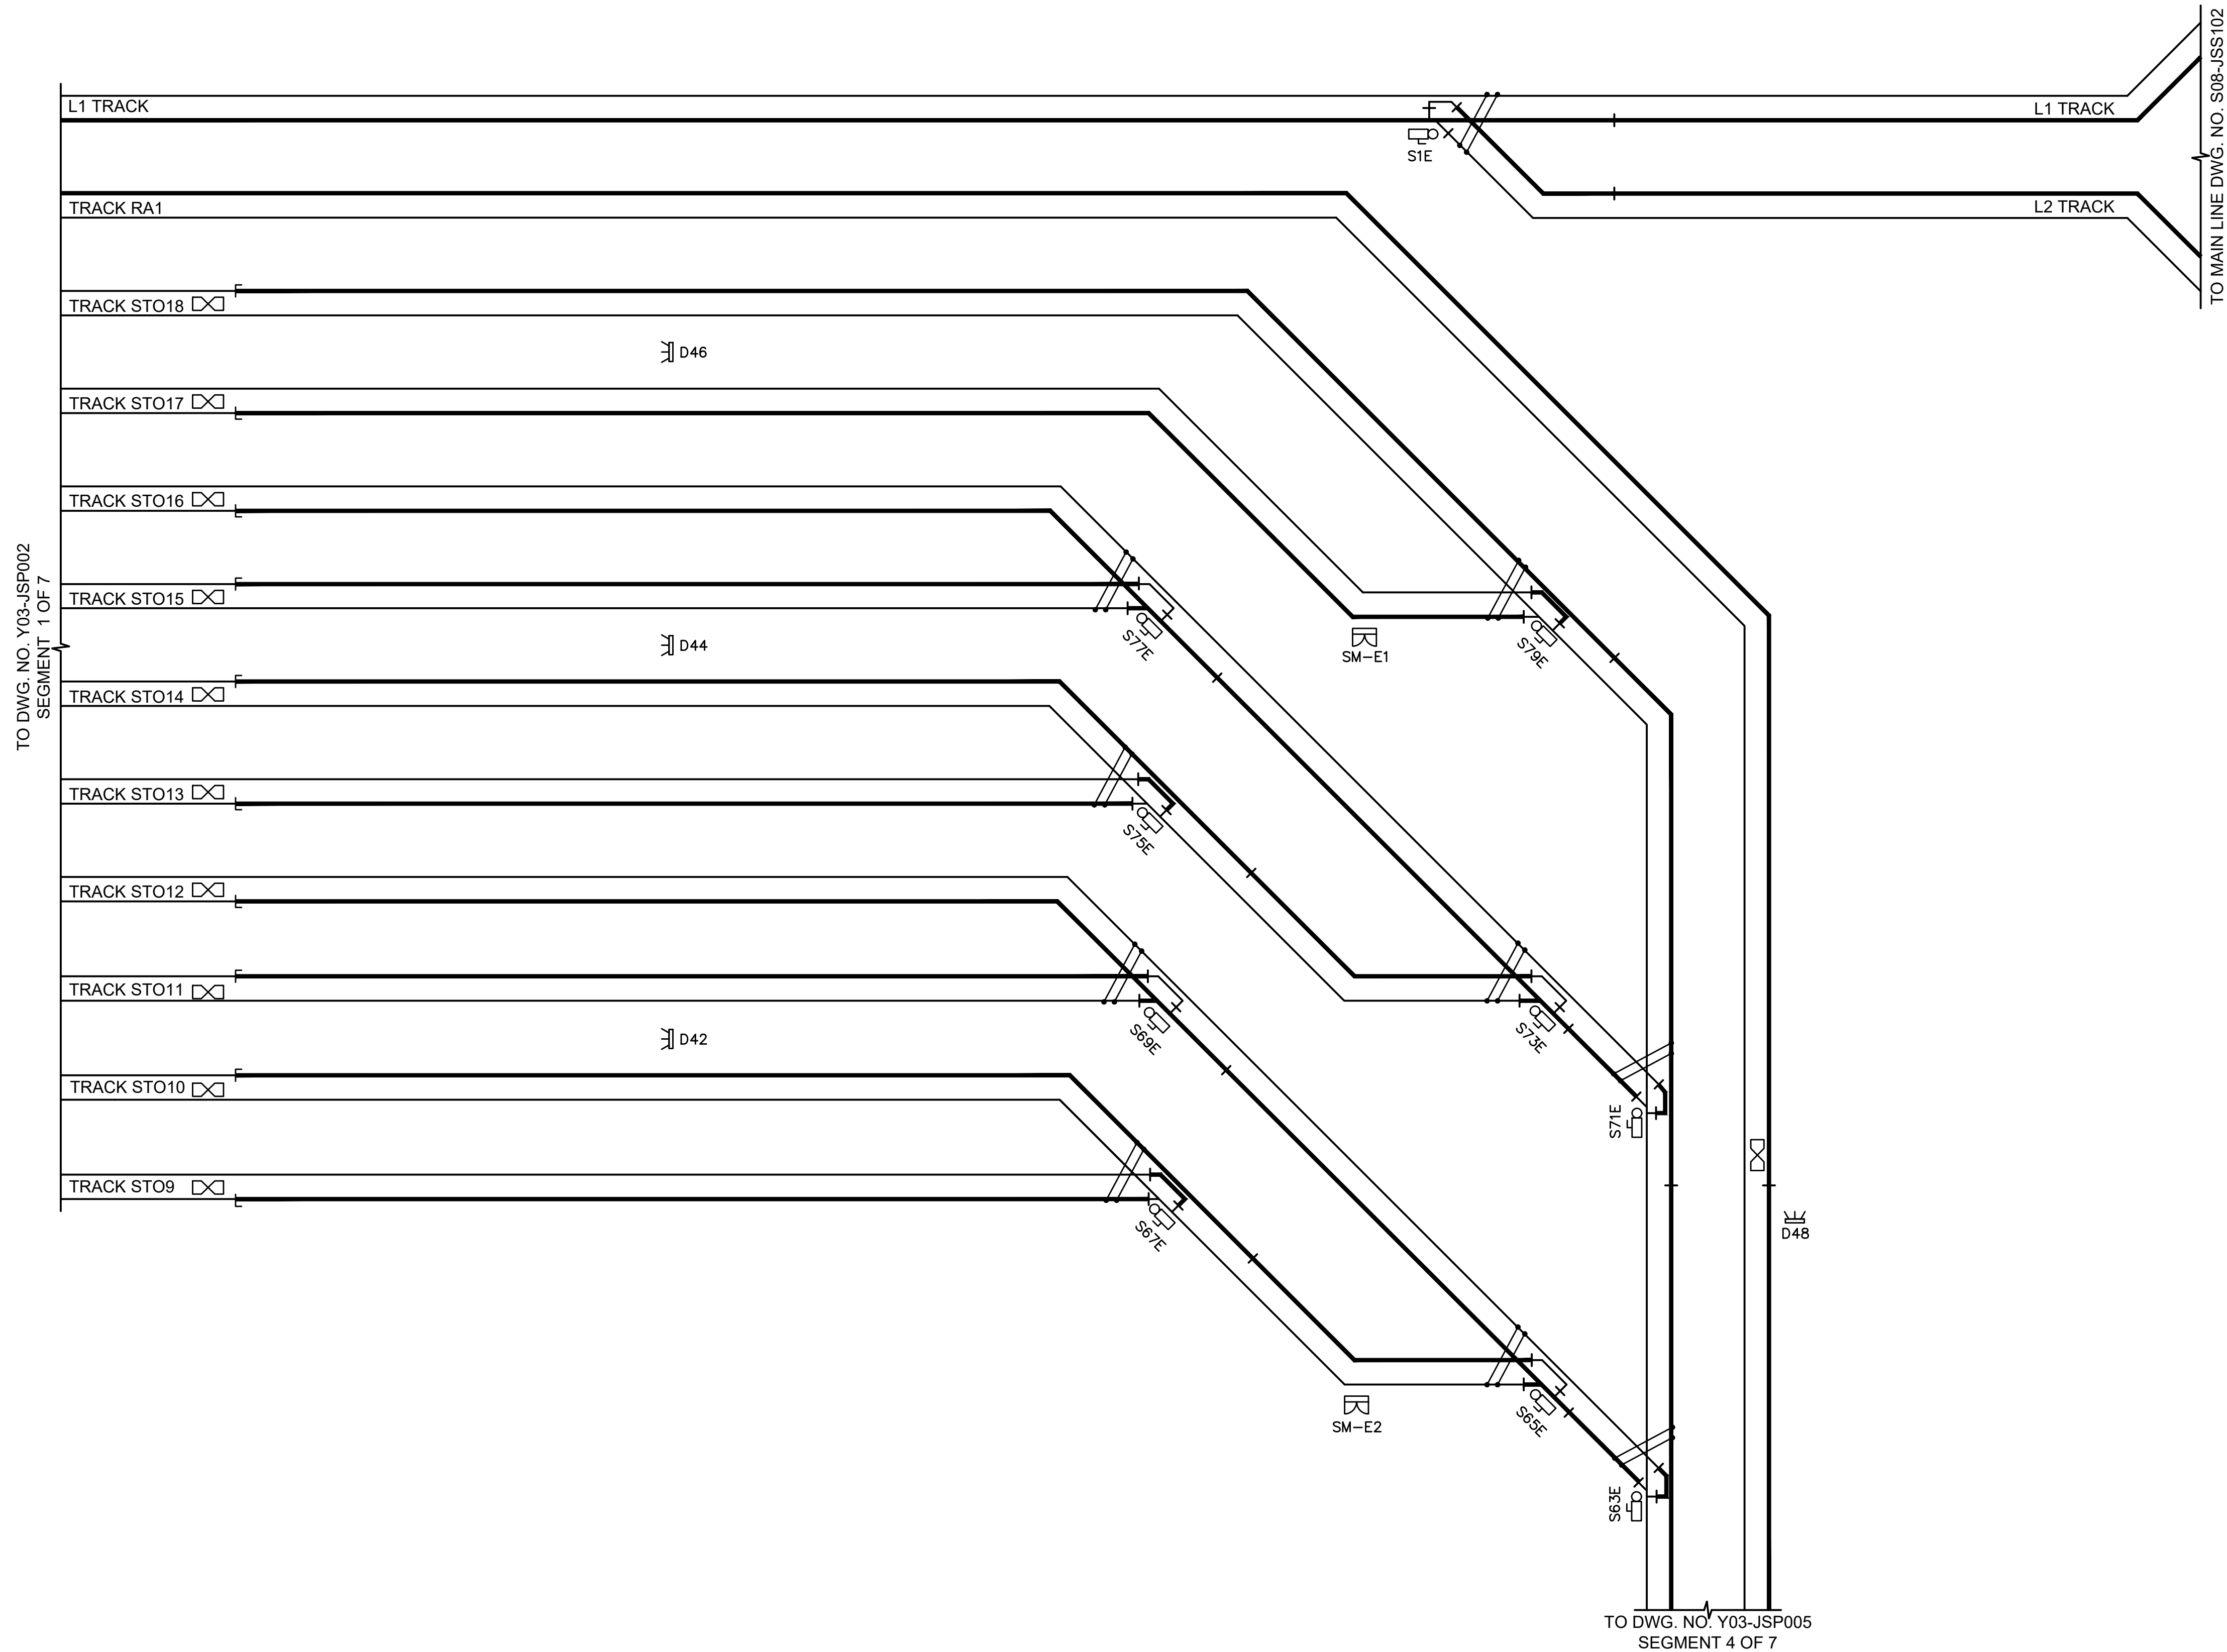
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CONSTRUCTION

Refer to the plan set COVER drawing
for disclaimers regarding this drawing.

REFERENCE CONCEPT DRAWINGS

No.	DATE	DSN	CHK	APP	REVISION

DESIGNED BY:	S. EDELMAN
DRAWN BY:	M. SHEPPARD
CHECKED BY:	A. EDLEMAN
APPROVED BY:	J. CANTWELL

AHJ:					PACKAGE #				
								DRAWING No.:	
								Y03-JSP003	
								FACILITY ID:	
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	SUBMITTED BY:			DATE:		REVIEWED BY:		DATE:	
PABLO LOPEZ-HILFIKER			2/27/2024						


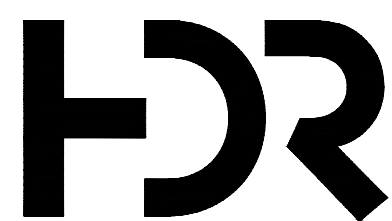

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Refer to the plan set COVER drawing
for disclaimers regarding this drawing.

REFERENCE CONCEPT DRAWINGS

No.	DATE	DSN	CHK	APP	REVISION


DESIGNED BY:	S. EDELMAN
DRAWN BY:	M. SHEPPARD
CHECKED BY:	A. EDLEMAN
APPROVED BY:	J. CANTWELL

AHJ:					PACKAGE #				
	 Burns BURNS ENGINEERING, INC. 215 978-7700 TWO COMMERCE SQUARE, 2001 MARKET ST, SUITE 600 PHILADELPHIA, PA 19106			<div>LINE IS "A" AT FULL SCALE</div> 	SCALE: NTS	<div>SOUND TRANSIT PRELIMINARY ENGINEERING PLANS OPERATIONS & MAINTENANCE FACILITY SOUTH</div> <div>SIGNALS SYSTEM YARD DOUBLE LINE TRACK PLAN SEGMENT 3 OF 7</div>		DRAWING No.: Y03-JSP004	
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					CONTRACT No.: AE0030-17			SHEET No.: REV:	
					DATE:			0	
	SUBMITTED BY: PABLO LOPEZ-HILFIKER	DATE: 2/27/2024	REVIEWED BY:	DATE:					

TO DWG. NO. Y03-JSP002
SEGMENT 1 OF 7

TO DWG. NO. Y03-JSP006
SEGMENT 5 OF 7



TO DWG. NO. Y03-JSP005
SEGMENT 4 OF 7

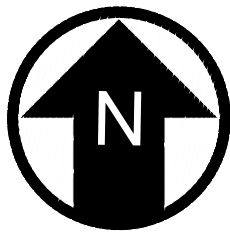

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ENGINEERING

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CONSTRUCTION

Refer to the plan set COVER drawing
for disclaimers regarding this drawing.

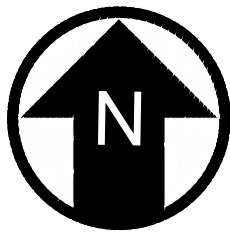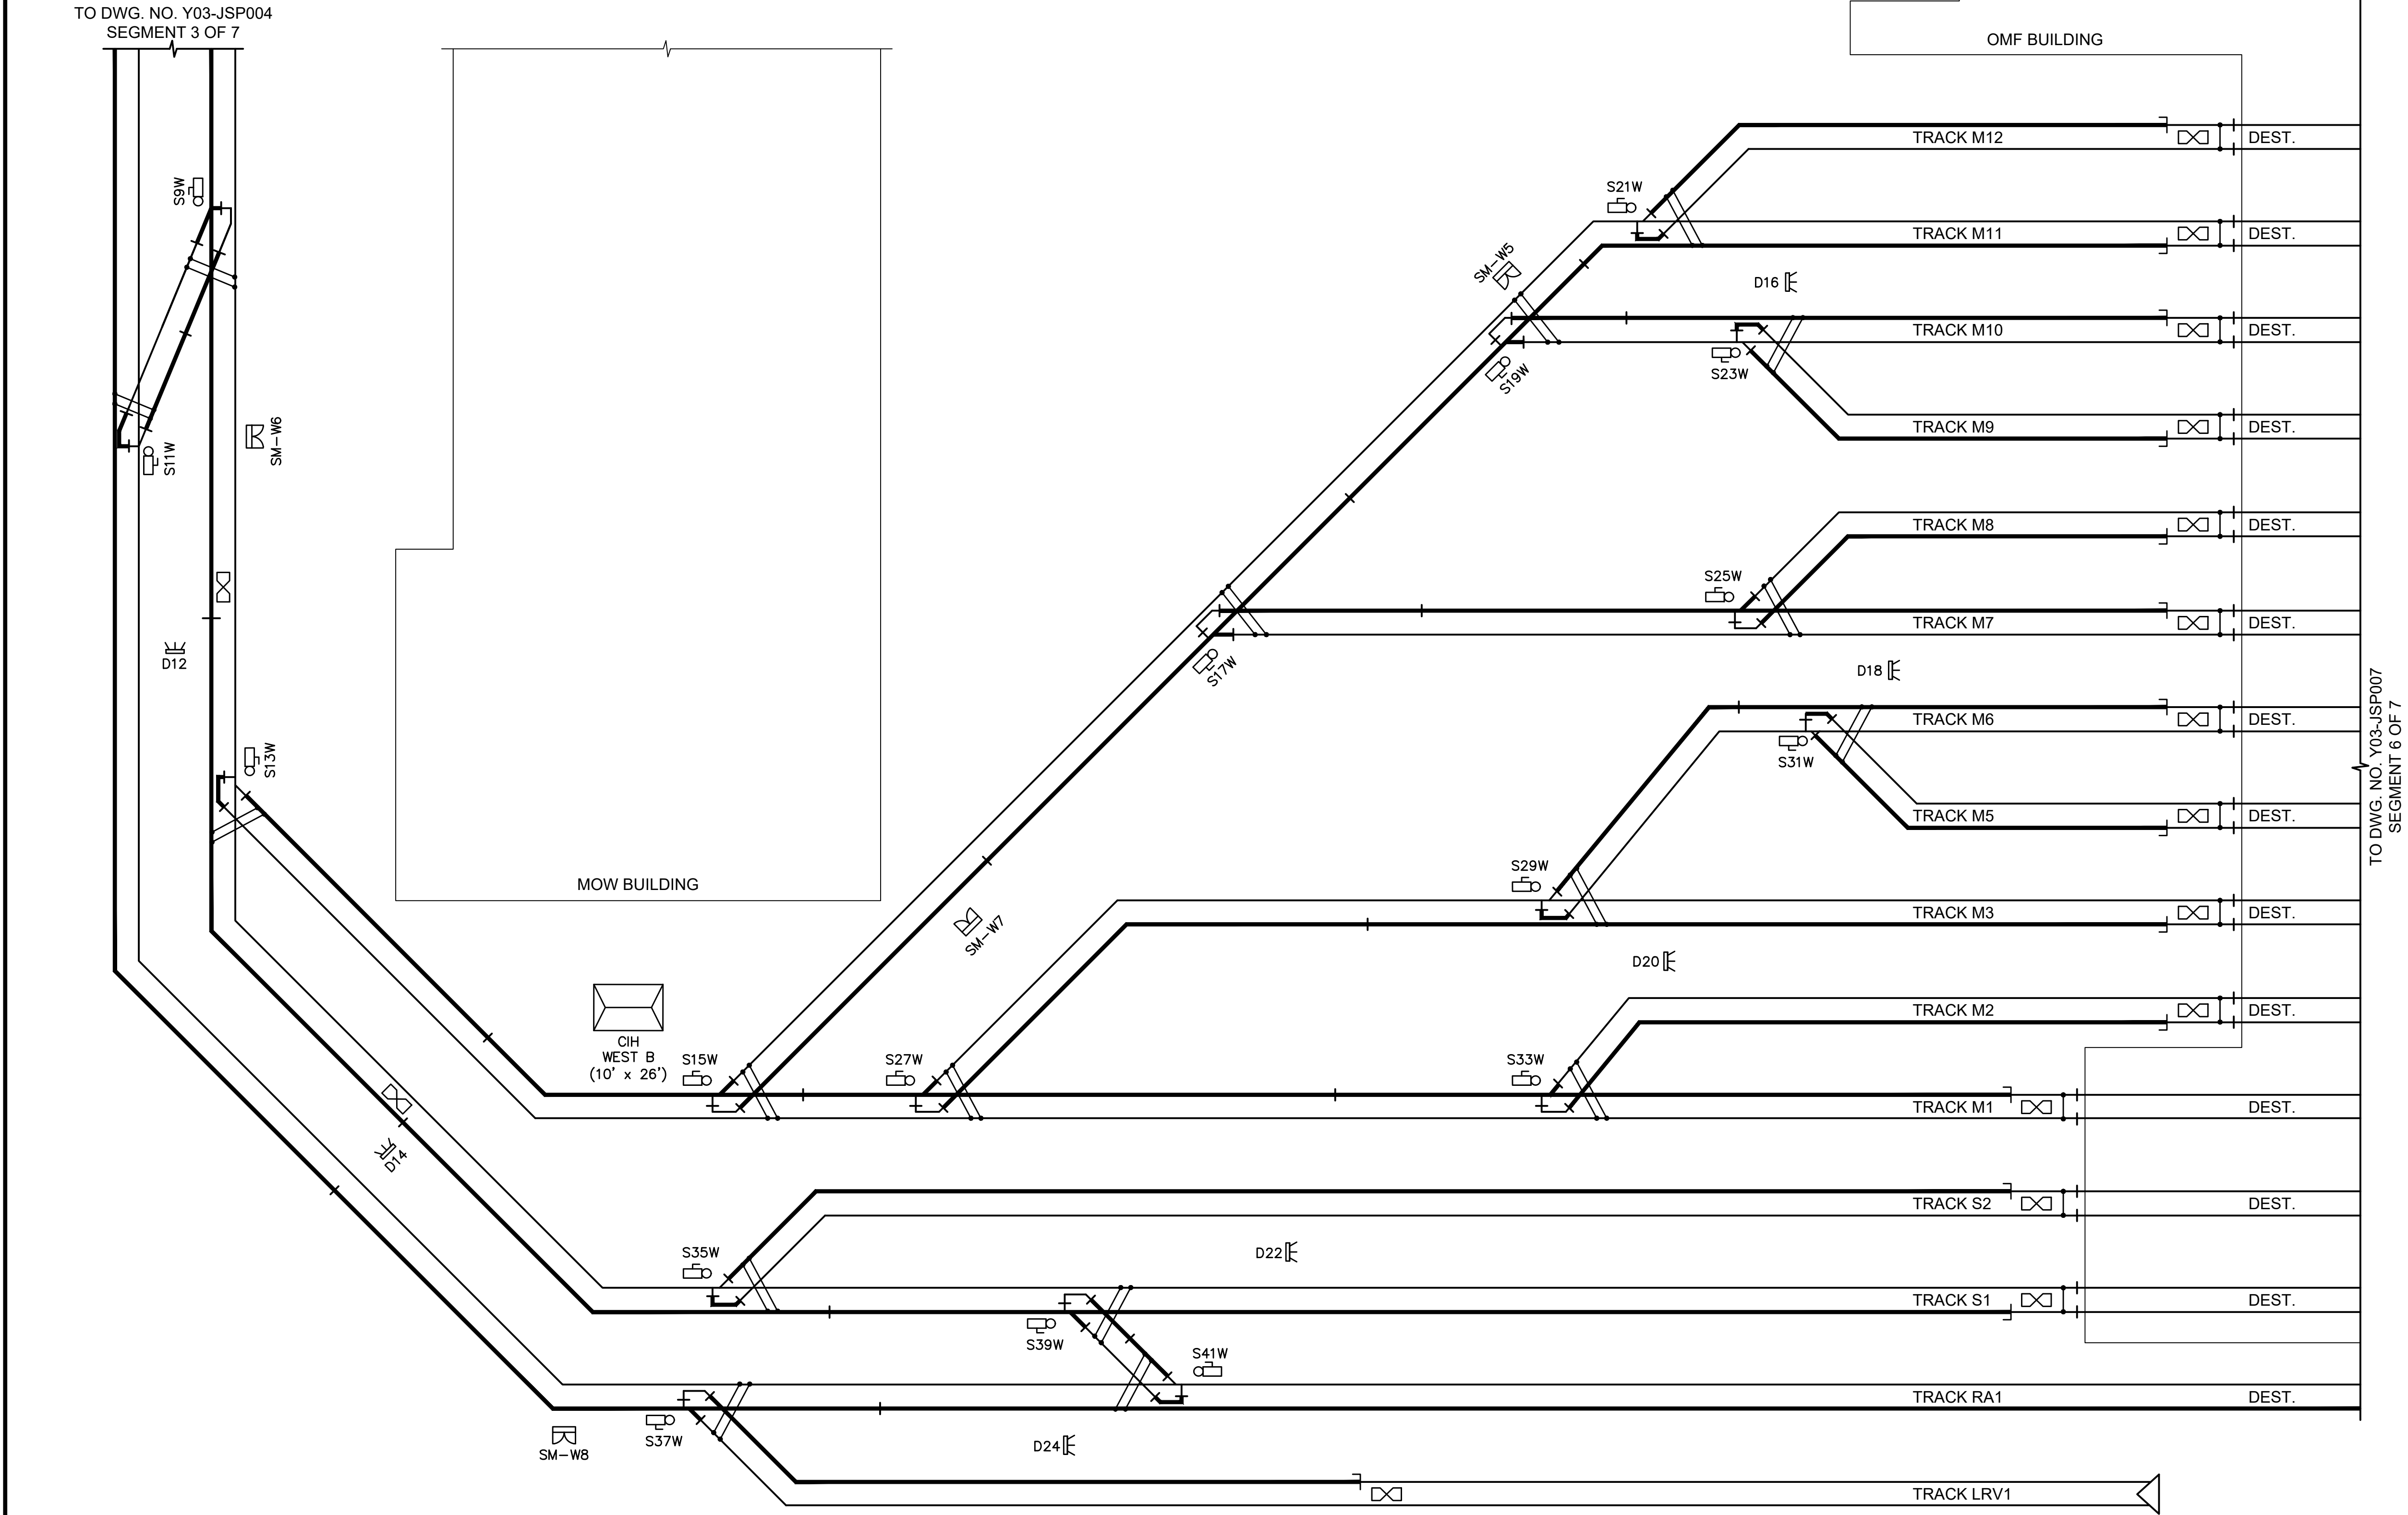REFERENCE CONCEPT DRAWINGS

No.	DATE	DSN	CHK	APP	REVISION

DESIGNED BY:	S. EDELMAN
DRAWN BY:	M. SHEPPARD
CHECKED BY:	A. EDLEMAN
APPROVED BY:	J. CANTWELL

AHJ:				PACKAGE #						
					SCALE: NTS FILENAME: OMFS-Y03-JSP006 CONTRACT No.: AE0030-17 DATE:		SOUND TRANSIT PRELIMINARY ENGINEERING PLANS OPERATIONS & MAINTENANCE FACILITY SOUTH SIGNALS SYSTEM YARD DOUBLE LINE TRACK PLAN SEGMENT 5 OF 7		DRAWING No.: Y03-JSP006	
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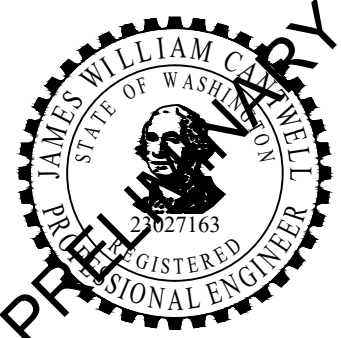
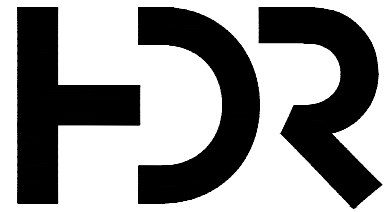


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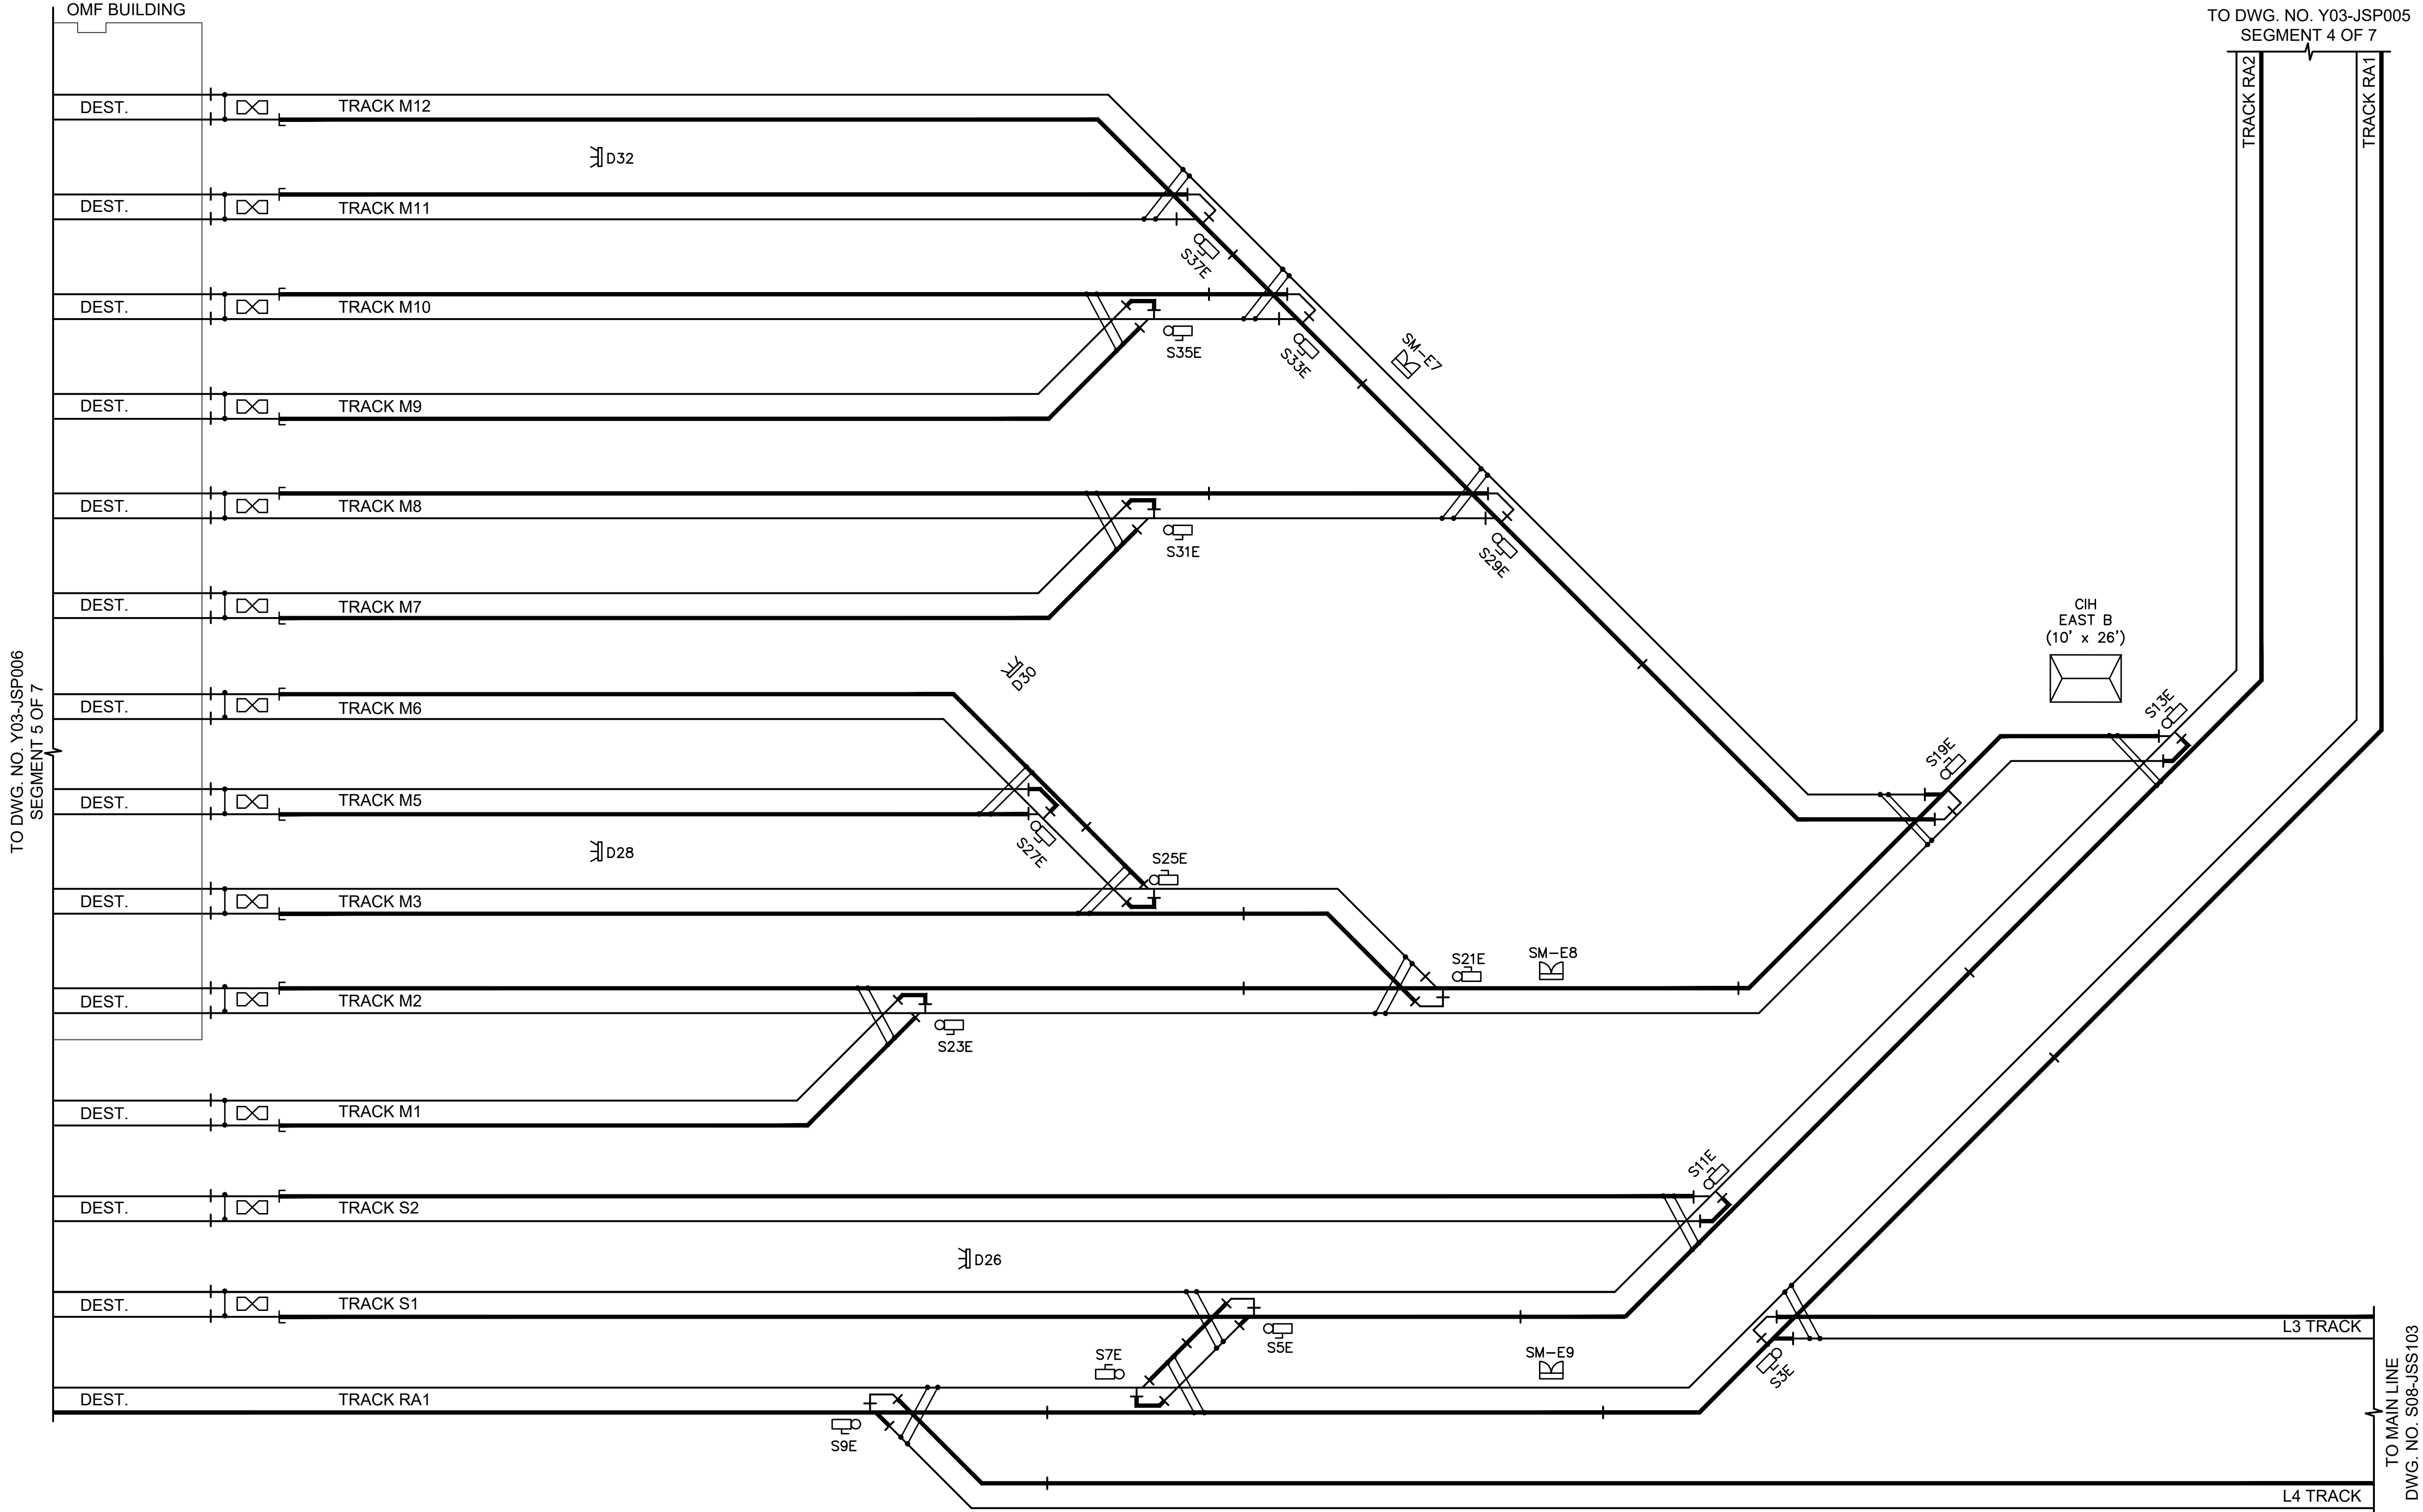
Refer to the plan set COVER drawing
for disclaimers regarding this drawing.

REFERENCE CONCEPT DRAWINGS

No.	DATE	DSN	CHK	APP	REVISION

DESIGNED BY:	S. EDELMAN
DRAWN BY:	M. SHEPPARD
CHECKED BY:	A. EDLEMAN
APPROVED BY:	J. CANTWELL

AHJ:			PACKAGE #			
			 <small>BURNS ENGINEERING, INC. 215.978.7700 TWO COMMERCE SQUARE, 2001 MARKET ST, SUITE 600 PHILADELPHIA, PA 19103</small>		 SOUNDTRANSIT	
SUBMITTED BY:		DATE:	REVIEWED BY:	DATE:	SCALE:	
PABLO LOPEZ-HILFIKER		2/27/2024			NTS	
					FILENAME:	
					OMFS-Y03-JSP007	
					CONTRACT No.:	
					AE0030-17	
					DATE:	
SOUND TRANSIT PRELIMINARY ENGINEERING PLANS OPERATIONS & MAINTENANCE FACILITY SOUTH					DRAWING No.:	
SIGNALS SYSTEM YARD DOUBLE LINE TRACK PLAN SEGMENT 6 OF 7					Y03-JSP007	
					FACILITY ID:	
					Y03	
					SHEET No.:	
					REV:	
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PRELIMINARY ENGINEERING NOT FOR CONSTRUCTION

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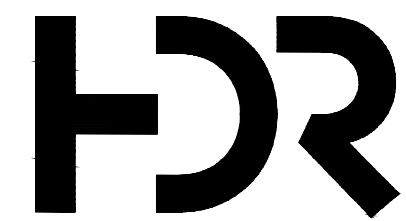
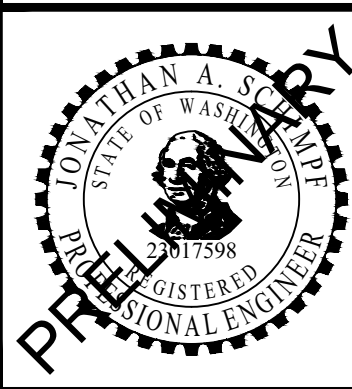
Refer to the plan set COVER drawing
for disclaimers regarding this drawing.

REFERENCE CONCEPT DRAWINGS

No.	DATE	DSN	CHK	APP	REVISION

DESIGNED BY:	Z. ZHANG
DRAWN BY:	Z. ZHANG
CHECKED BY:	P. PERREAULT
APPROVED BY:	J. SCHIMPF

AHJ:



SUBMITTED BY:
PABLO LOPEZ-HILFIKER

DATE:
2/27/2024



BURNS ENGINEERING, INC. | 215-978-7700
TWO COMMERCIAL SQUARE, 2001 MARKET ST., SUITE 600
PHILADELPHIA, PA 19103

REVIEWED BY:



DATE:


PACKAGE #

SCALE: 1"=100'
FILENAME: OMFS-Y03-JCP000_019
CONTRACT No.: AE0030-17
DATE:

SOUND TRANSIT
PRELIMINARY ENGINEERING PLANS
OPERATIONS & MAINTENANCE FACILITY SOUTH

COMMUNICATION SYSTEM
OVERALL YARD PLAN


DRAWING No.:	Y03-JCP000
FACILITY ID:	Y03
SHEET No.:	REV:
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NOTES:

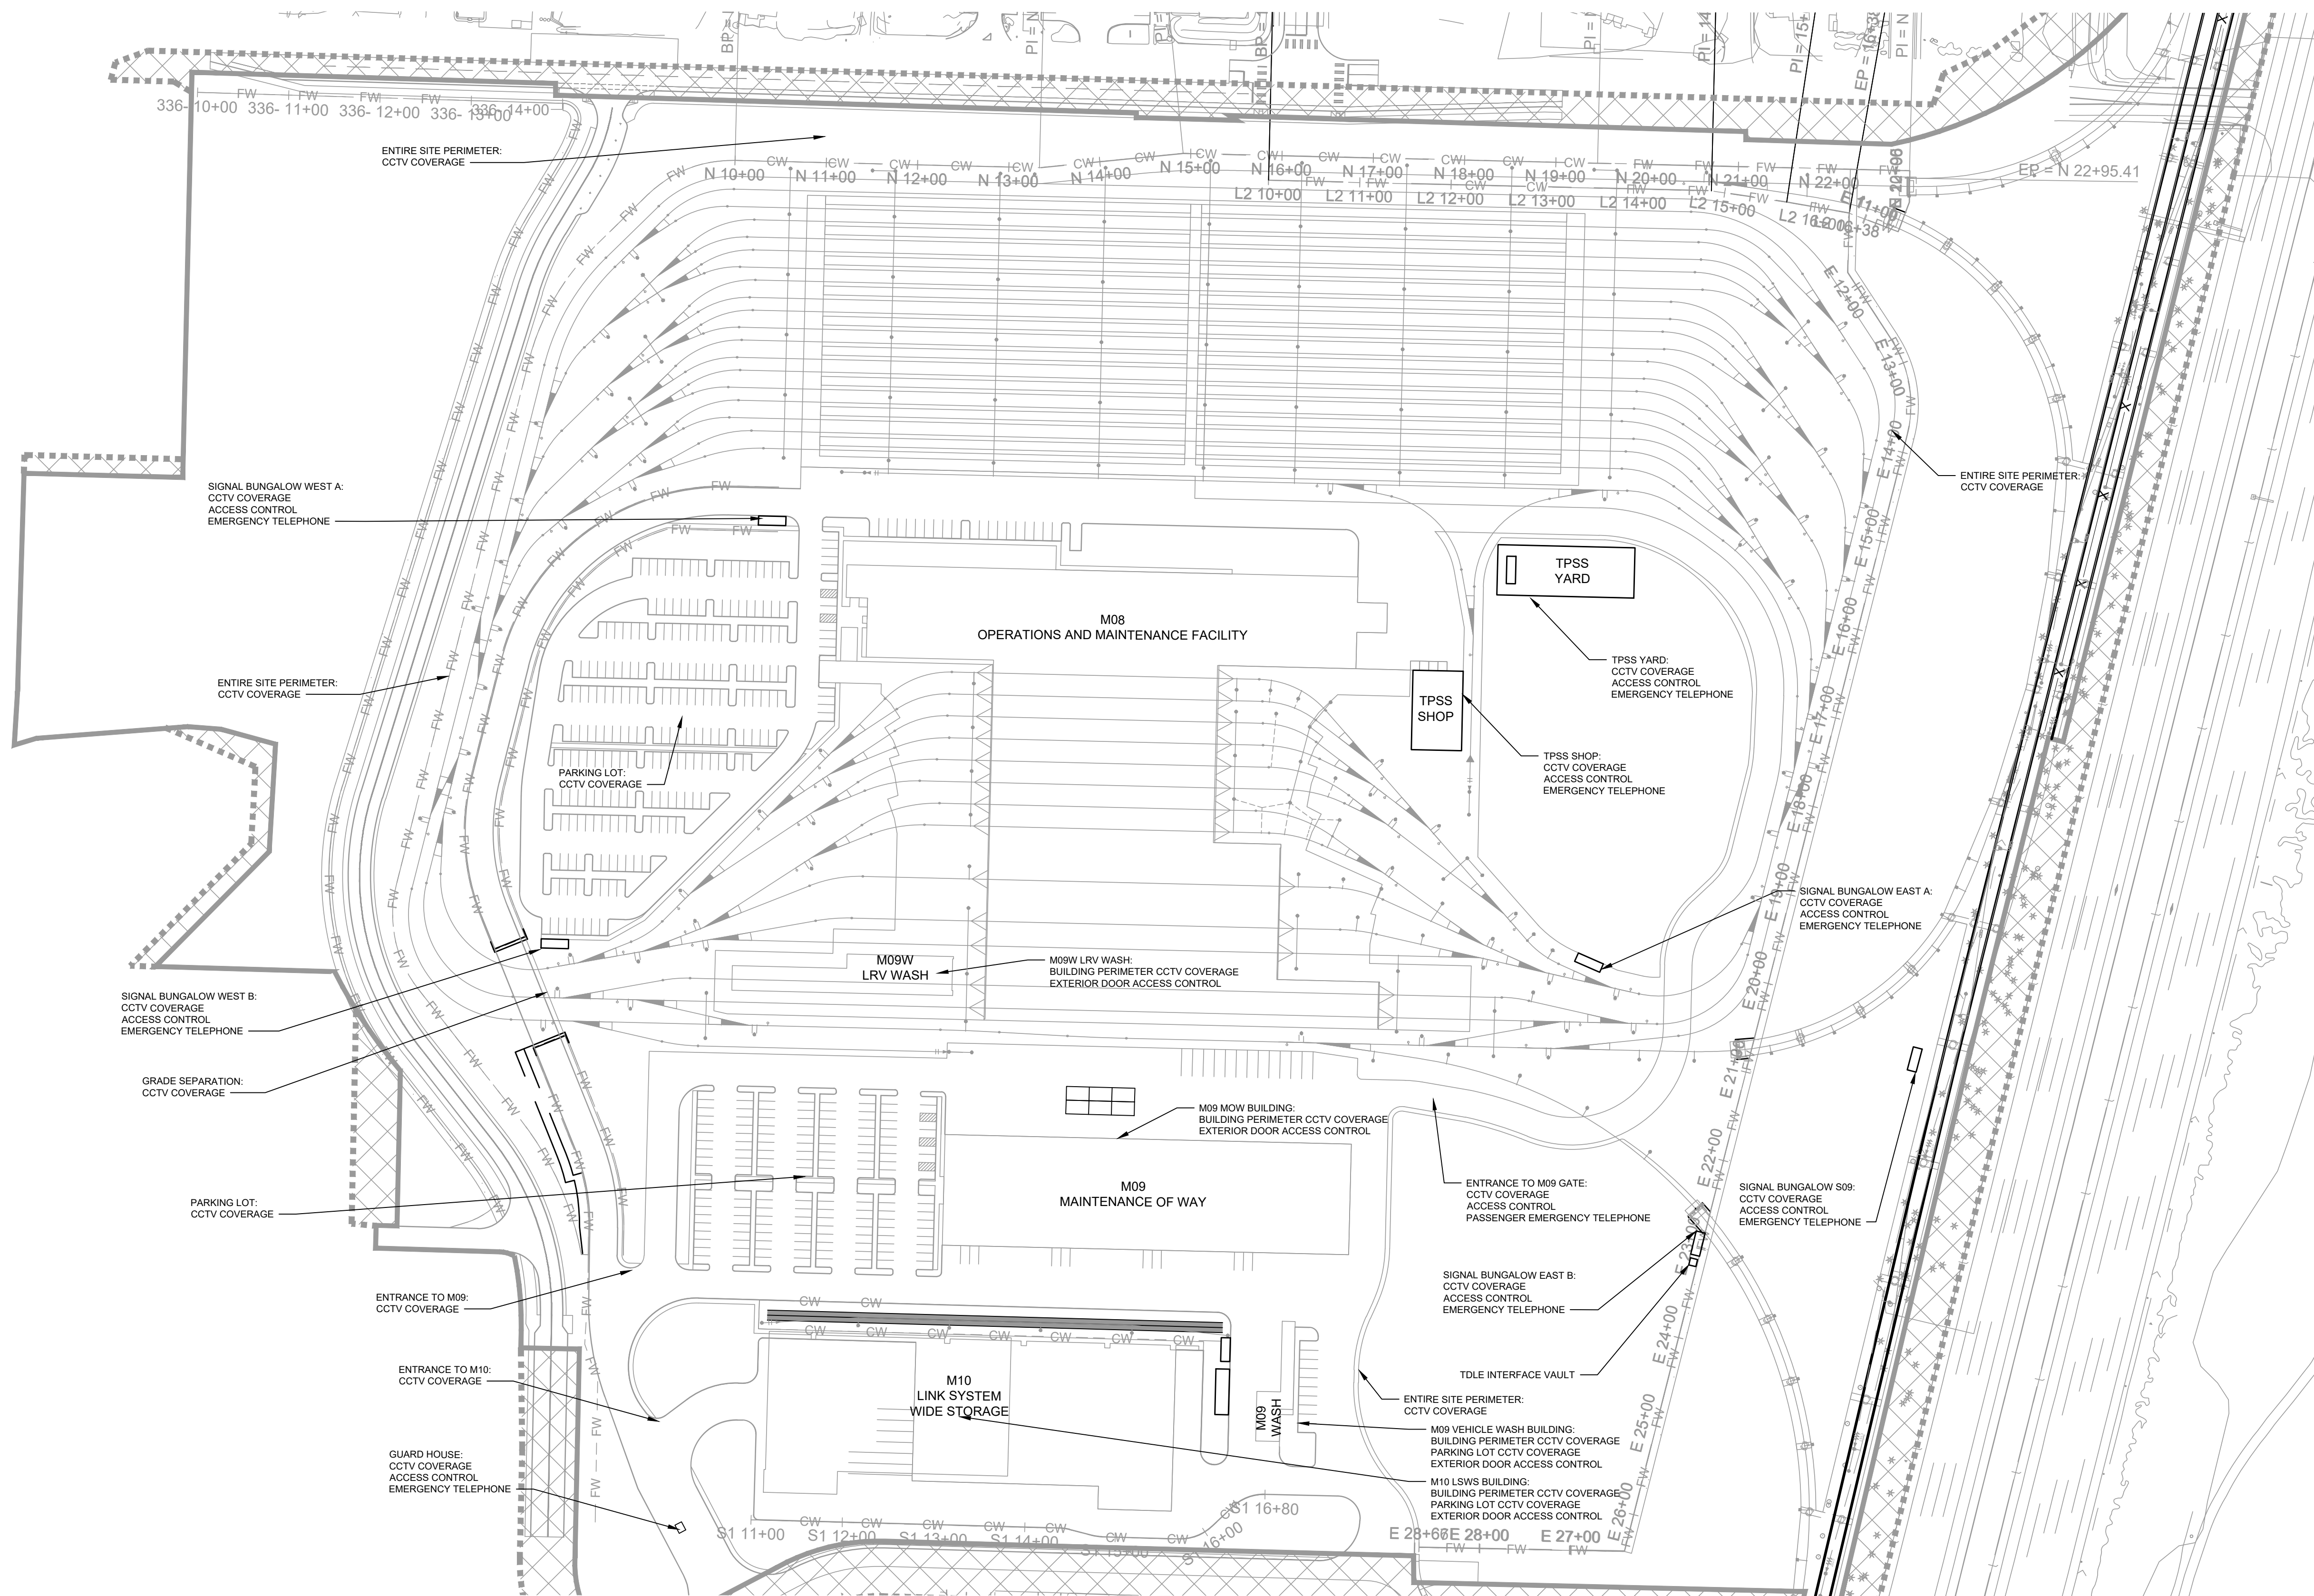1. FINAL DEVICE LOCATIONS SHALL BE COORDINATED WITH SOUND TRANSIT.
2. PROVIDE WIFI COVERAGE FOR THE ENTIRE YARD.
3. REFER TO STRM 1202.4.2 FOR MINIMUM CCTV PLACEMENT REQUIREMENTS.

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- NOTES:**
- EXISTING LOCATIONS SHOWN REPRESENTATIVE ONLY.
 - REDUNDANT BACKHAUL FIBER CONNECTIONS/RING AND ETHERNET SWITCHES NOT SHOWN FOR CLARITY.
 - REFER TO JZN002 AND JZN004 FOR SYMBOLS.

TRAIN CONTROL SYSTEM
SCALE: NTS

PRELIMINARY
ENGINEERING


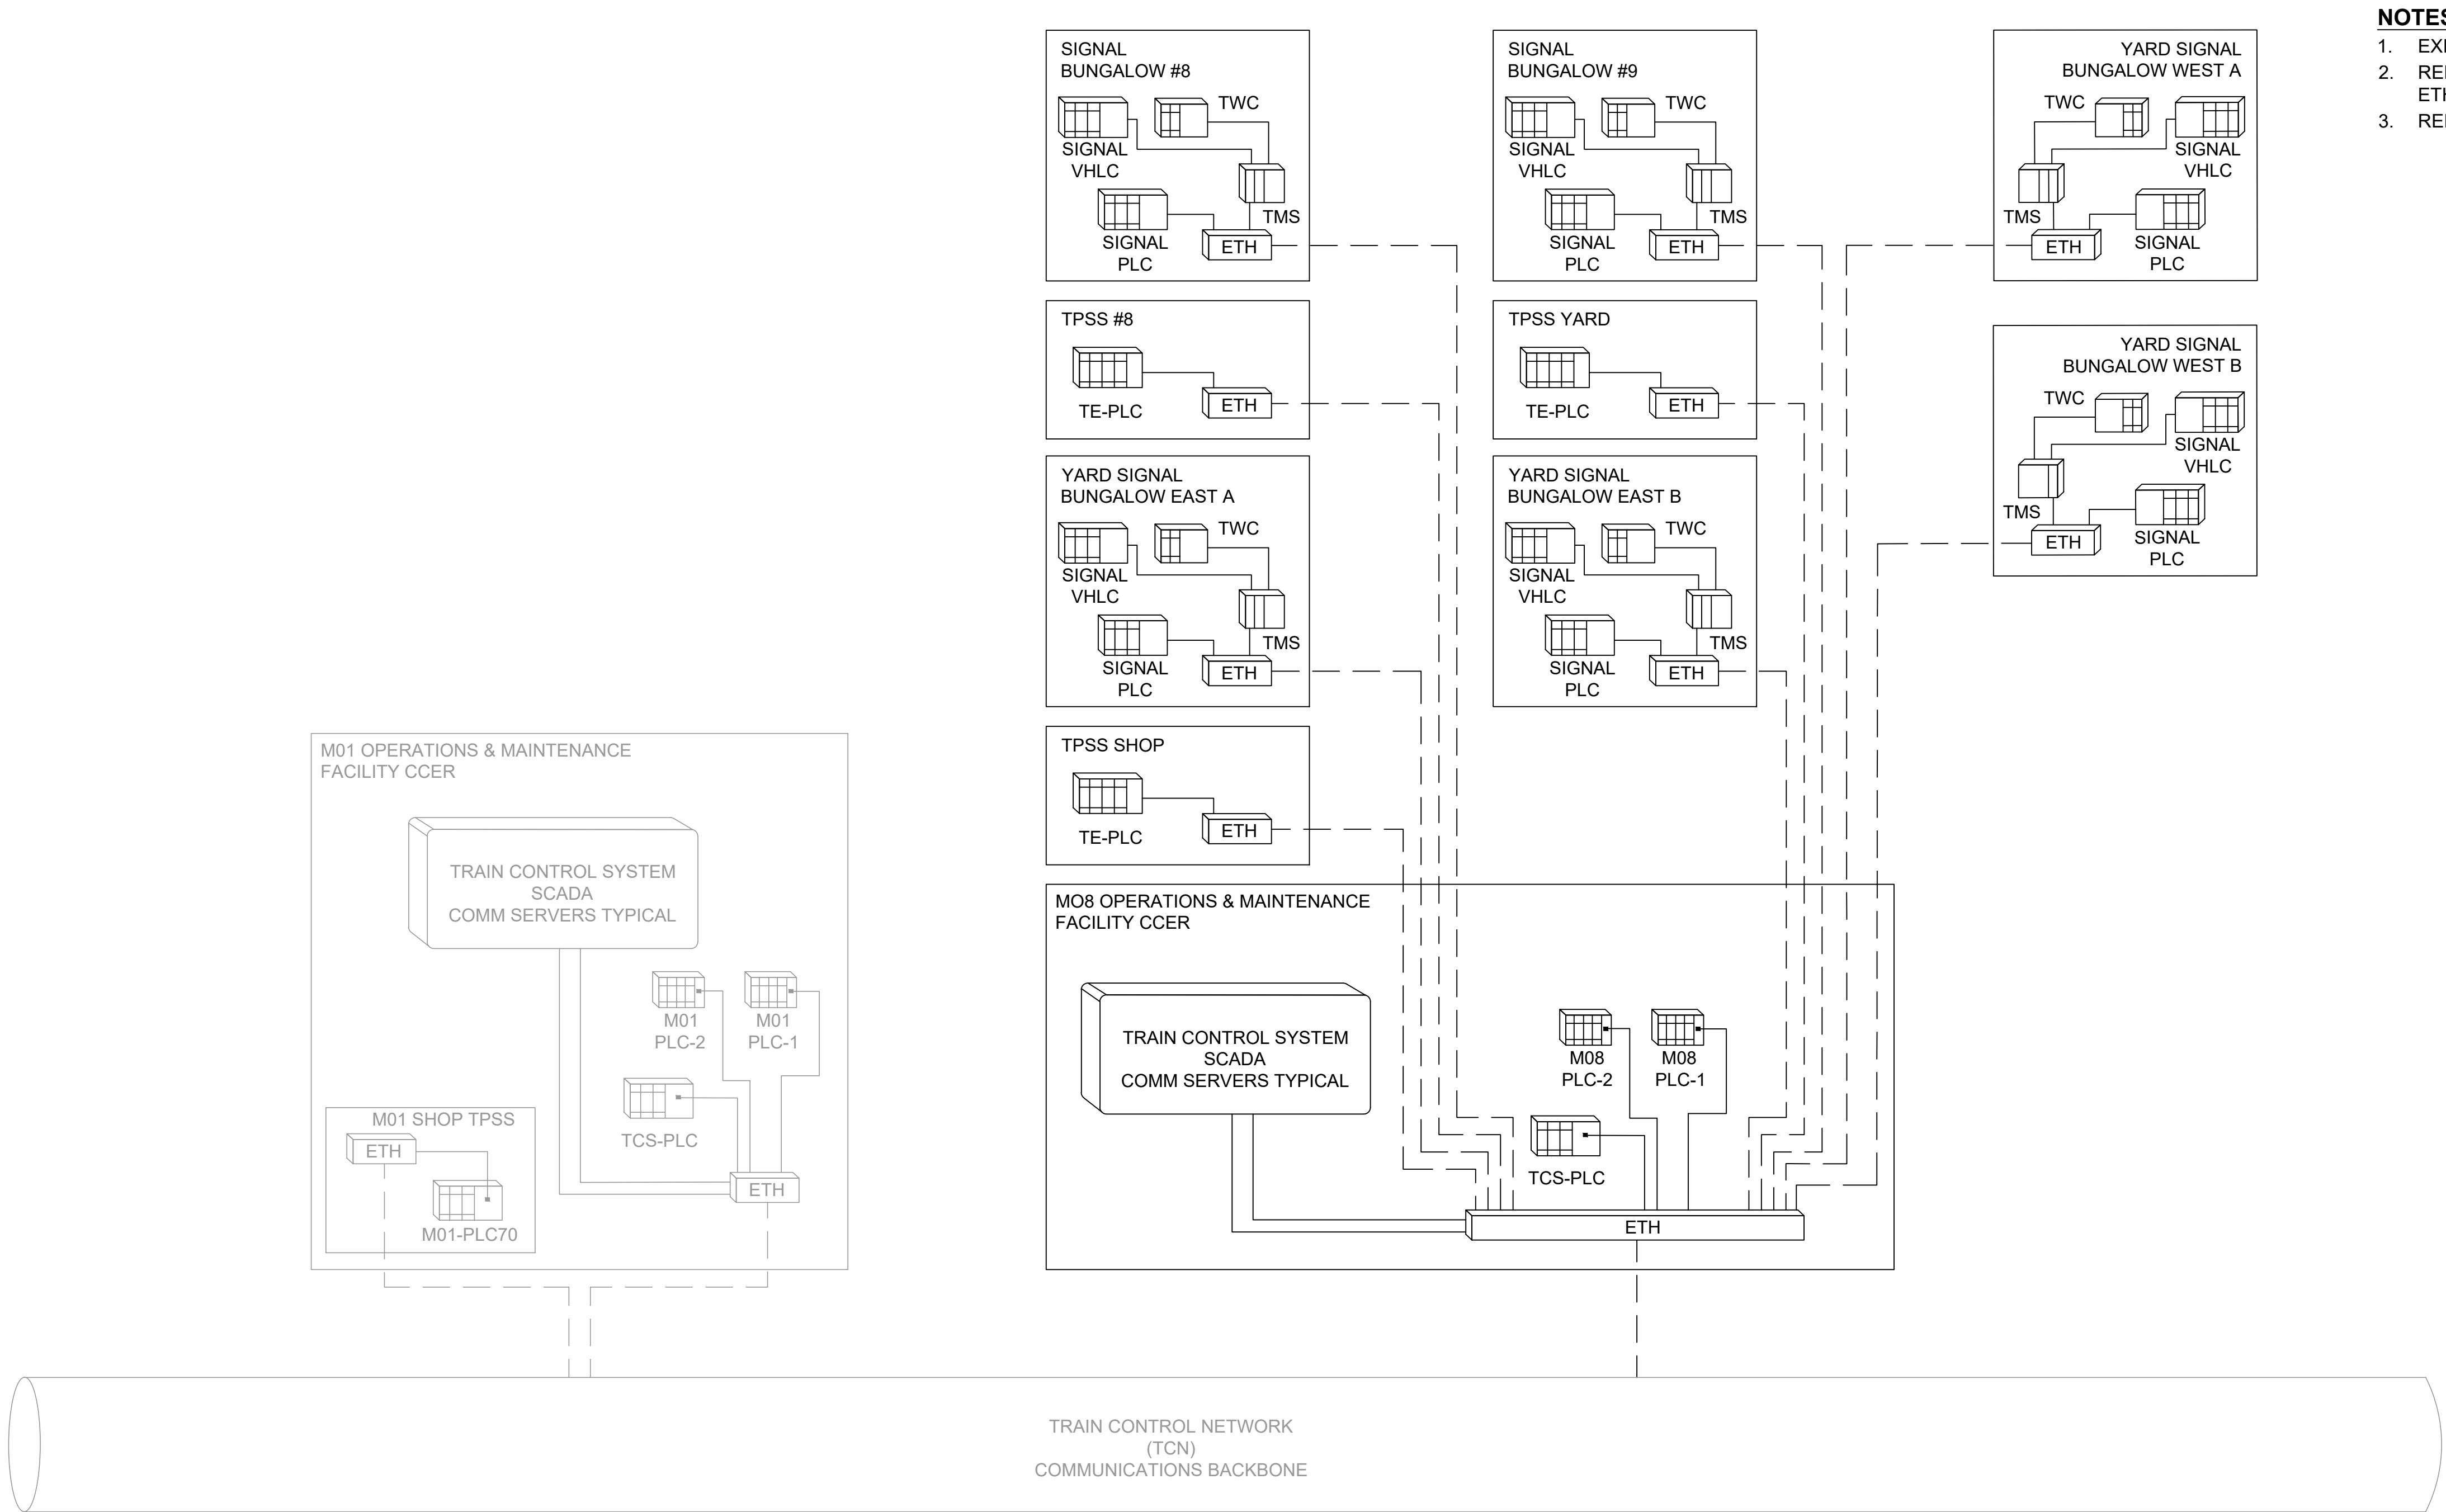
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CONSTRUCTION

Refer to the plan set COVER drawing
for disclaimers regarding this drawing.

REFERENCE CONCEPT DRAWINGS

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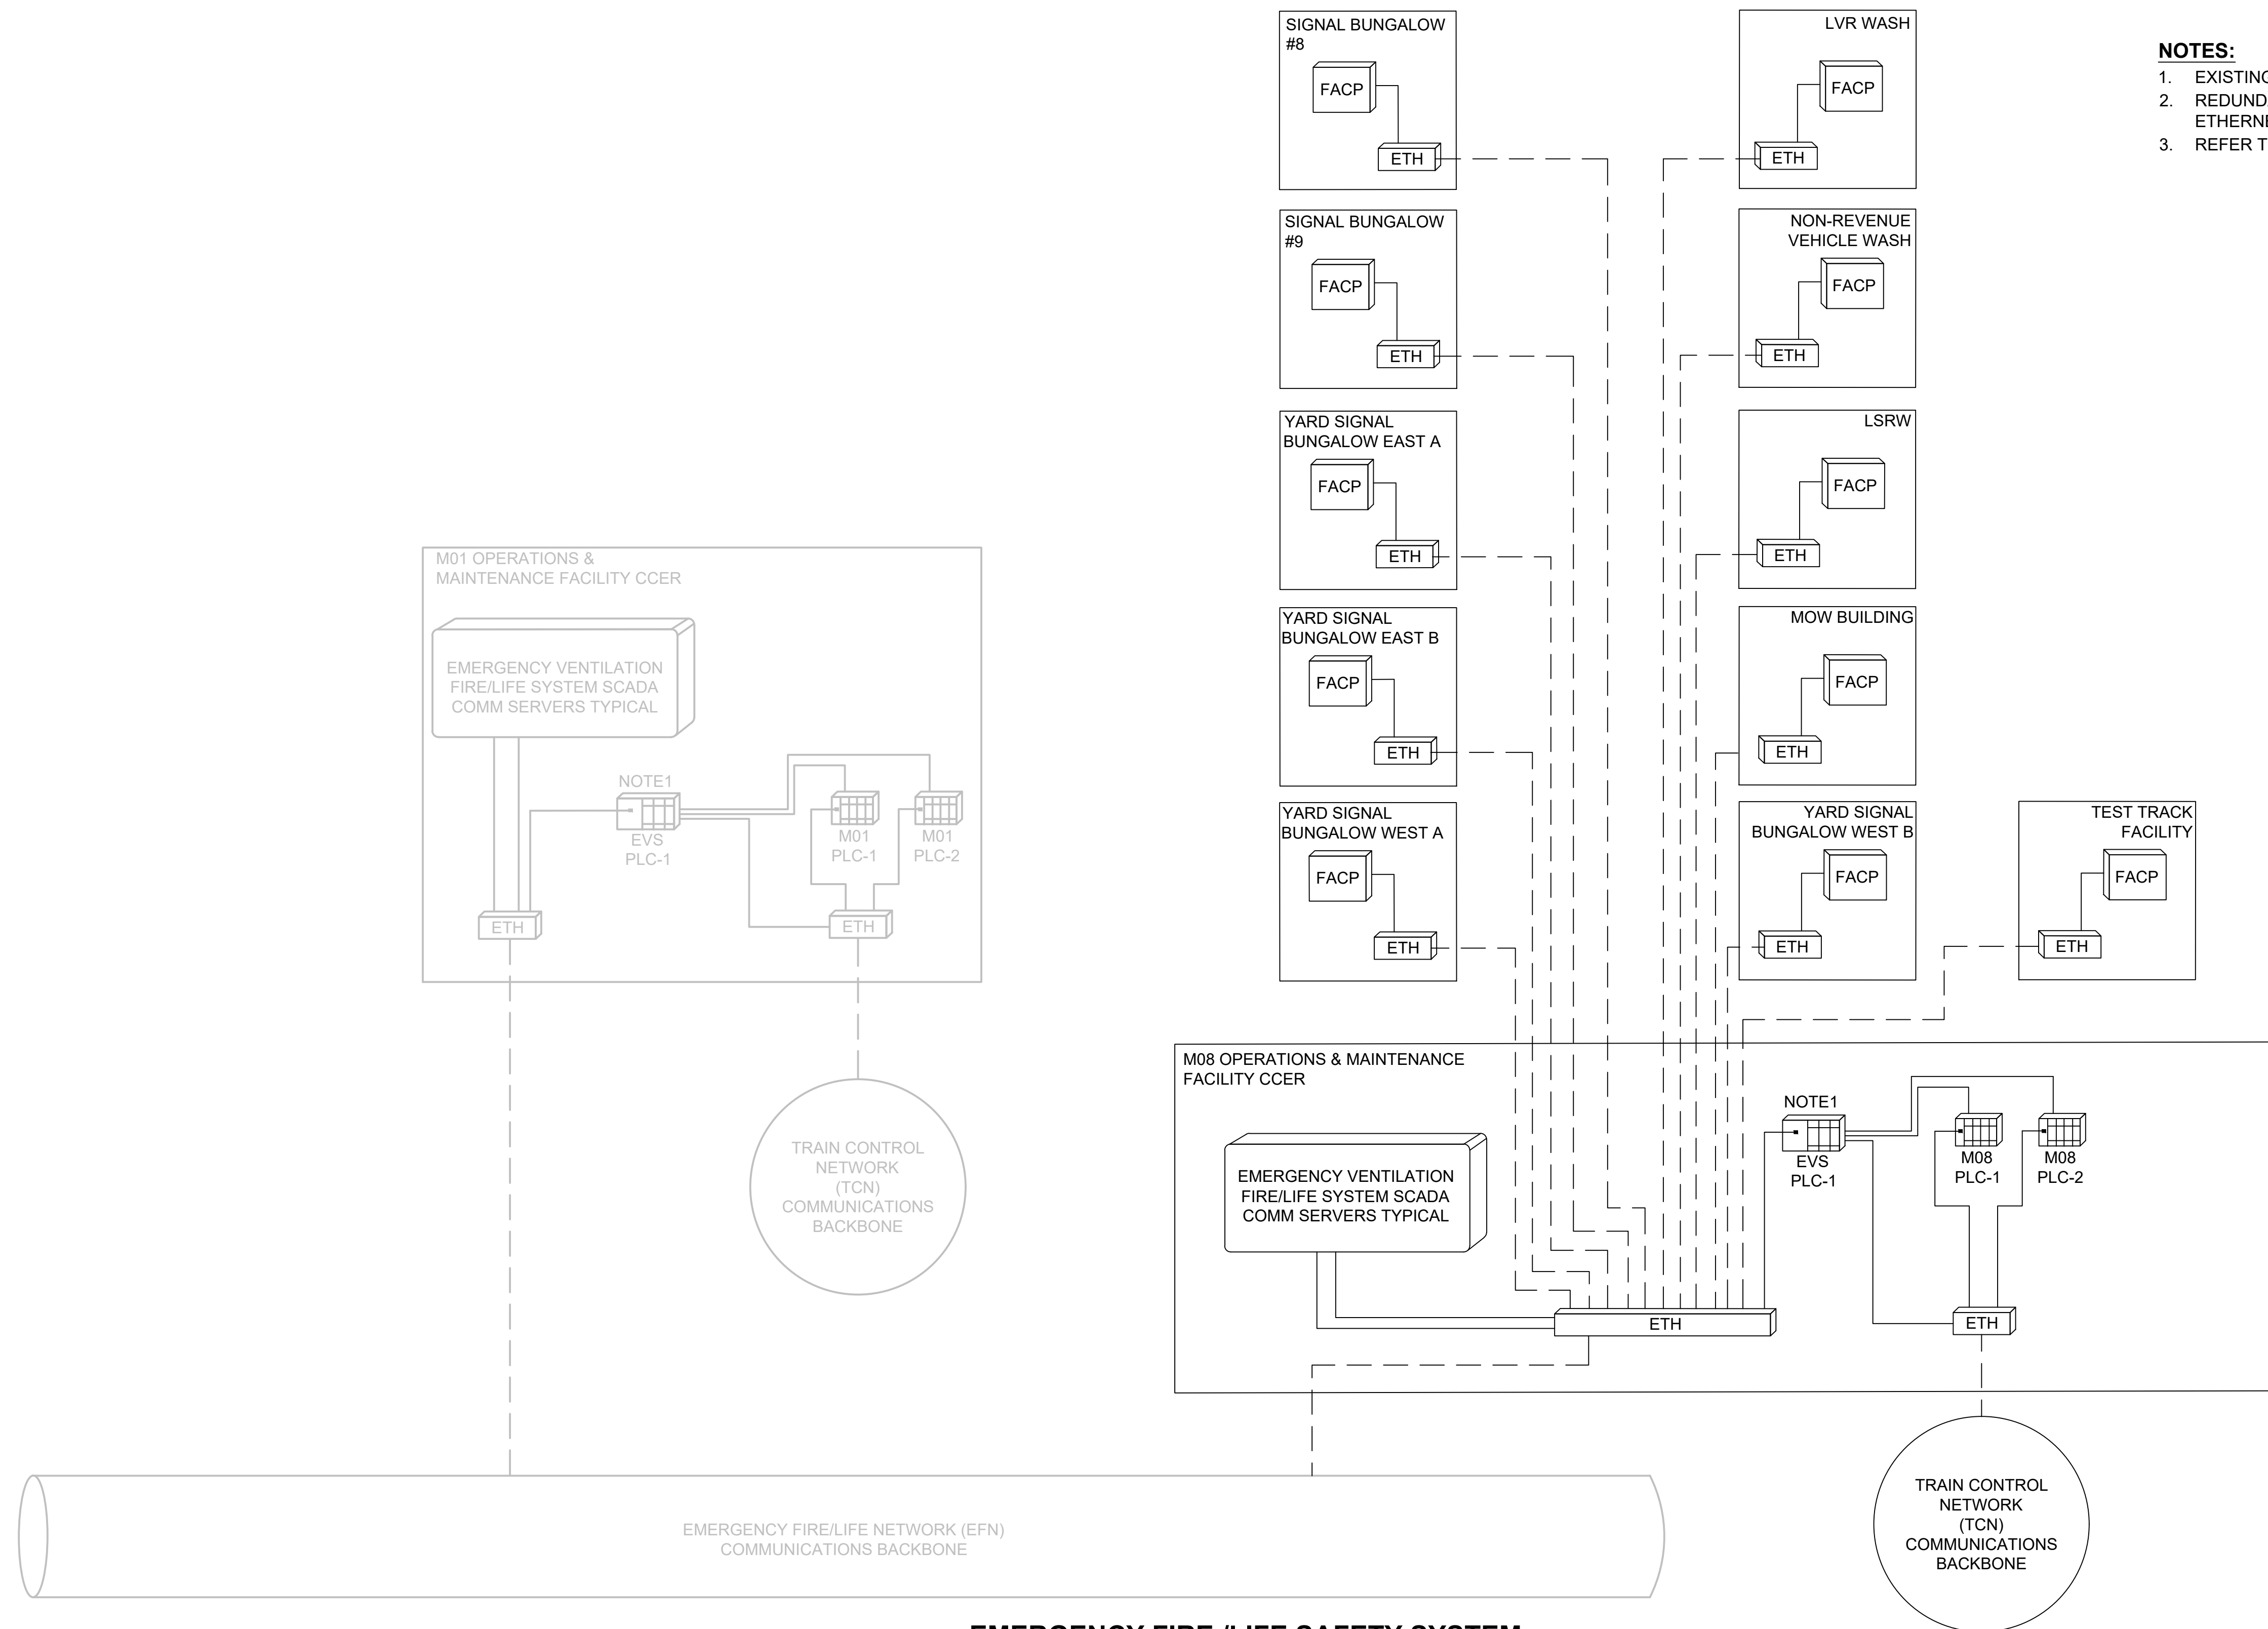
DESIGNED BY:	Z. ZHANG
DRAWN BY:	Z. ZHANG
CHECKED BY:	P. PERREAULT
APPROVED BY:	J. SCHIMPF

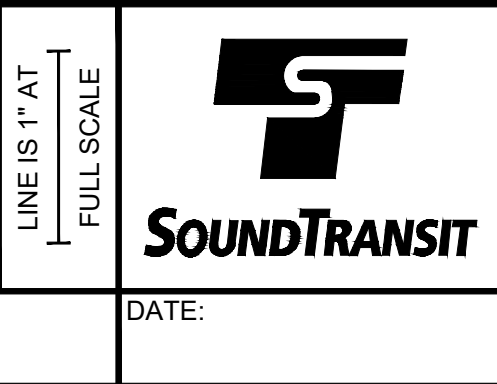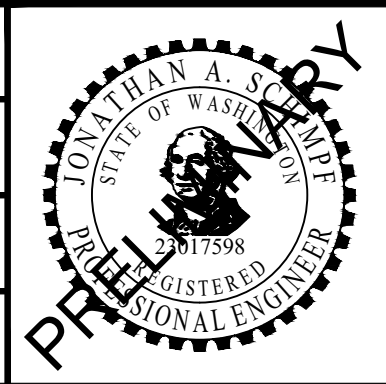

SCALE:	NTS
FILENAME:	OMFS-Y03-JCS001
CONTRACT No.:	AE0030-17
DATE:	

SOUND TRANSIT PRELIMINARY ENGINEERING PLANS OPERATIONS & MAINTENANCE FACILITY SOUTH COMMUNICATION SYSTEM SYSTEM WIDE OVERVIEW DIAGRAM TRAIN CONTROL SYSTEM

DRAWING No.:	Y03-JCS001
FACILITY ID:	Y03, M08, S08
SHEET No.:	REV:
	0



- NOTES:**
1. EXISTING LOCATIONS SHOWN REPRESENTATIVE ONLY.
 2. REDUNDANT BACKHAUL FIBER CONNECTIONS/RING AND ETHERNET SWITCHES NOT SHOWN FOR CLARITY.
 3. REFER TO JZN002 AND JZN004 FOR SYMBOLS

EMERGENCY FIRE /LIFE SAFETY SYSTEM

SCALE: NTS



PRELIMINARY
ENGINEERING

NOT FOR
CONSTRUCTION

REFERENCE CONCEPT DRAWINGS

No.	DATE	DSN	CHK	APP	REVISION

DESIGNED BY:	Z. ZHANG
DRAWN BY:	Z. ZHANG
CHECKED BY:	P. PERREAULT
APPROVED BY:	J. SCHIMPF

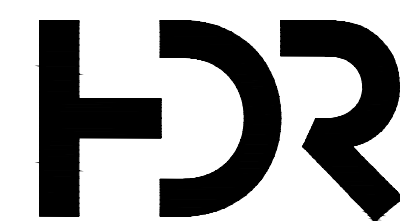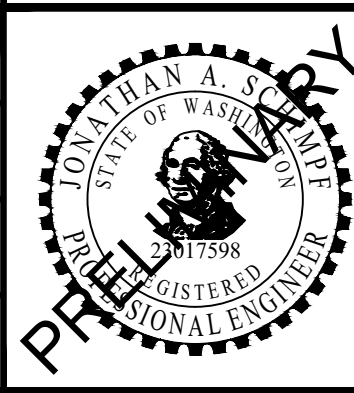SUBMITTED BY:
PABLO LOPEZ-HILFIKER

DATE:	2/27/2024
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Burns
BURNS ENGINEERING, INC. | 215 979-7700
TWO COMMERCE SQUARE, 2001 MARKET ST, SUITE
PHILADELPHIA, PA 19103

REVIEWED BY:

LINE IS 1" AT



DATE:

PACKAGE #

SCALE:

FILENAME:

OMFS-Y03-JCS00

AE0030-17

DATE: _____

SOUND TRANSIT
PRELIMINARY ENGINEERING PLANS
OPERATIONS & MAINTENANCE FACILITY SOUTH

COMMUNICATION SYSTEM
SYSTEM WIDE OVERVIEW
EMERGENCY FIRE/LIFE SAFETY SYSTEM


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Y03, M08	
SHEET No.:	REV:

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- NOTES:**
1. LOCAL PLC COMM. BUS CONNECTIONS TO REMOTE I/O AT EACH LOCATION NOT SHOWN FOR CLARITY.
 2. REDUNDANT BACKHAUL FIBER CONNECTIONS/RING AND ETHERNET SWITCHES NOT SHOWN FOR CLARITY.
 3. REFER TO JZN002 AND JZN004 FOR SYMBOLS

Refer to the plan set COVER drawing
for disclaimers regarding this drawing.

REFERENCE CONCEPT DRAWINGS

No.	DATE	DSN	CHK	APP	REVISION

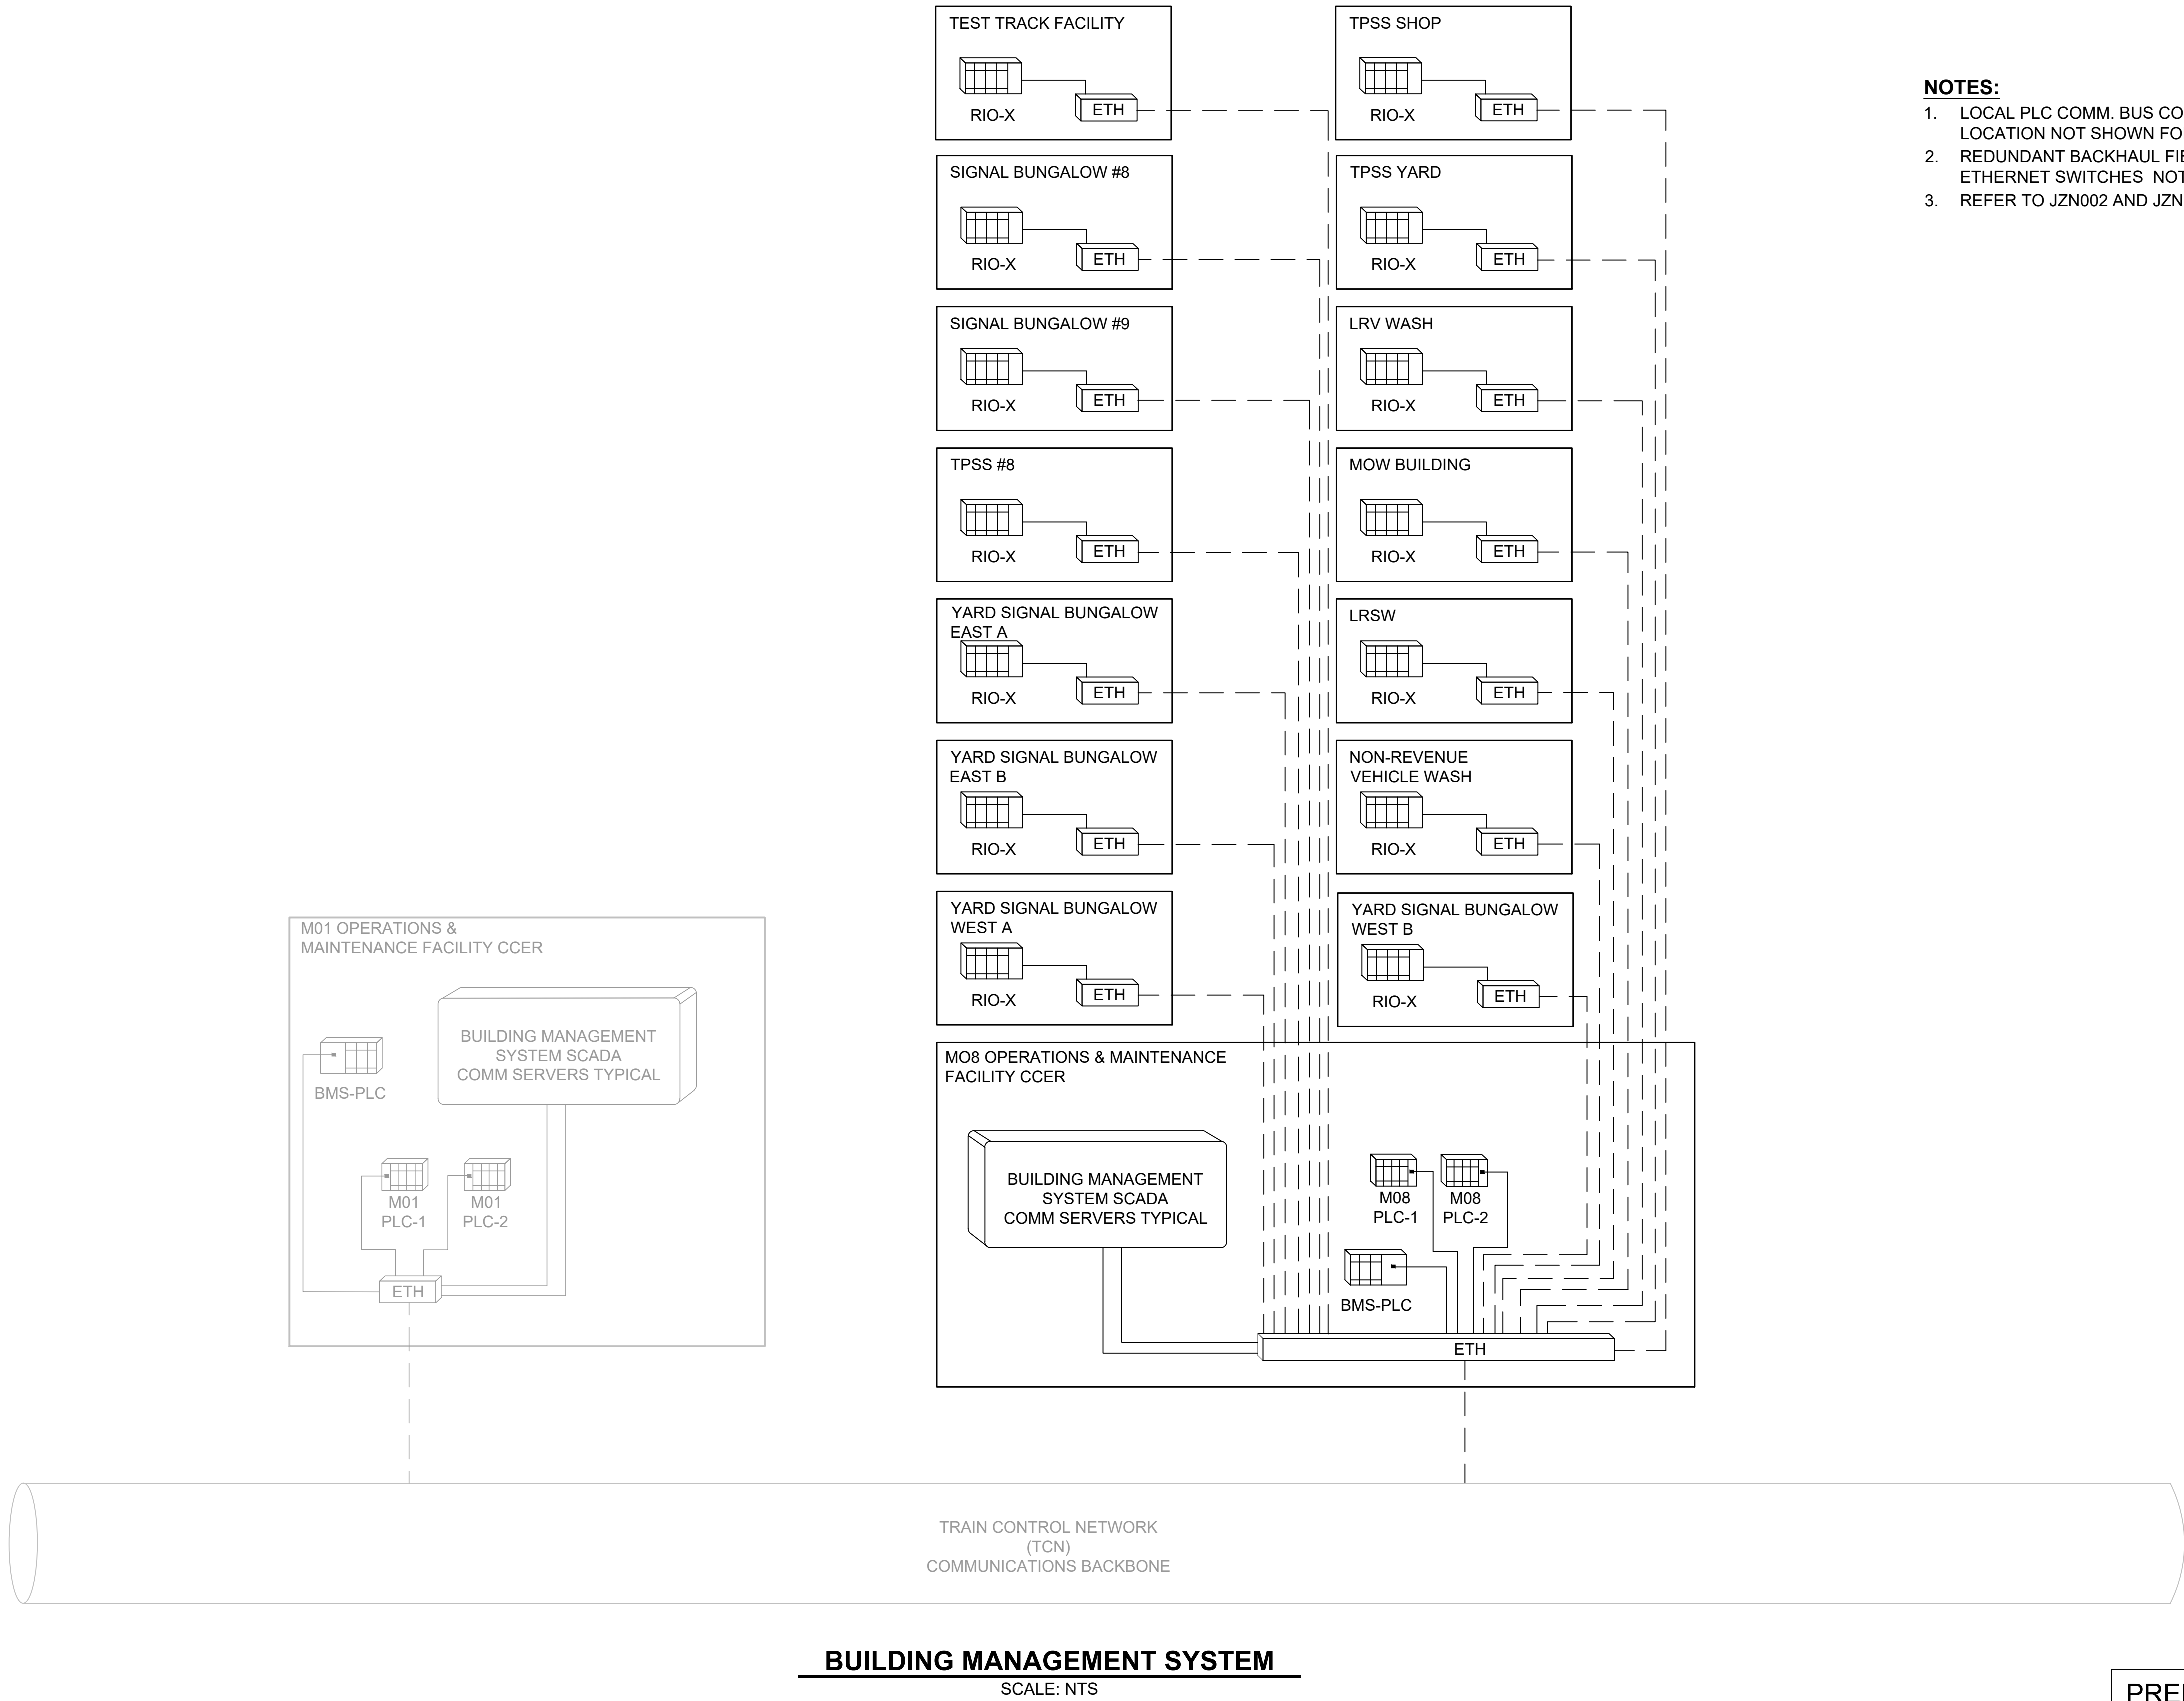DESIGNED BY:
Z. ZHANG
DRAWN BY:
Z. ZHANG
CHECKED BY:
P. PERREAU
APPROVED BY:
J. SCHIMPF

AHJ:					PACKAGE #					
						<div>SOUND TRANSIT PRELIMINARY ENGINEERING PLANS OPERATIONS & MAINTENANCE FACILITY SOUTH COMMUNICATION SYSTEM SYSTEM WIDE OVERVIEW DIAGRAM BUILDING MANAGEMENT SYSTEM</div>			DRAWING No.: Y03-JCS003	
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SUBMITTED BY: PABLO LOPEZ-HILFIKER		DATE: 2/27/2024	REVIEWED BY:		DATE:					



- NOTES:**




NOT FOR
CONSTRUCTION

SCALE: NTS

No.	DATE	DSN	CHK	APP	REVISION

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DRAWN BY:	Z. ZHANG
CHECKED BY:	P. PERREAULT
APPROVED BY:	J. SCHIMPF

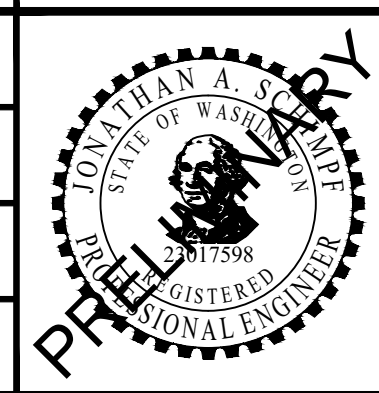


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FILENAME:
OMFS-Y03-JCS004
CONTRACT No.:
AE0030-17
DATE:

SOUND TRANSIT
PRELIMINARY ENGINEERING PLANS
OPERATIONS & MAINTENANCE FACILITY SOUTH

COMMUNICATION SYSTEM
TCS HARDWARE/SOFTWARE
BLOCK DIAGRAM

DRAWING No.:	
Y03-JCS004	
FACILITY ID:	
Y03, M08, S08	
SHEET No.:	REV:
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REFERENCE CONCEPT DRAWINGS						AHJ:		PACKAGE #		SOUND TRANSIT PRELIMINARY ENGINEERING PLANS OPERATIONS & MAINTENANCE FACILITY SOUTH COMMUNICATION SYSTEM EVS HARDWARE/SOFTWARE BLOCK DIAGRAM			DRAWING No.: Y03-JCS005	
No.	DATE	DSN	CHK	APP	REVISION	DESIGNED BY: Z. ZHANG		SCALE: NTS		 BURNS ENGINEERING, INC. 215 976-7700 TWO COMMERCE SQUARE, 2001 MARKET ST, SUITE 600 PHILADELPHIA, PA 19103			FACILITY ID: Y03, M08, S08	
						DRAWN BY: Z. ZHANG							SHEET No.: REV:	
						CHECKED BY: P. PERREAULT							0	
						APPROVED BY: J. SCHIMPF								
						SUBMITTED BY: PABLO LOPEZ-HILFIKER	DATE: 2/27/2024		REVIEWED BY:		DATE:			

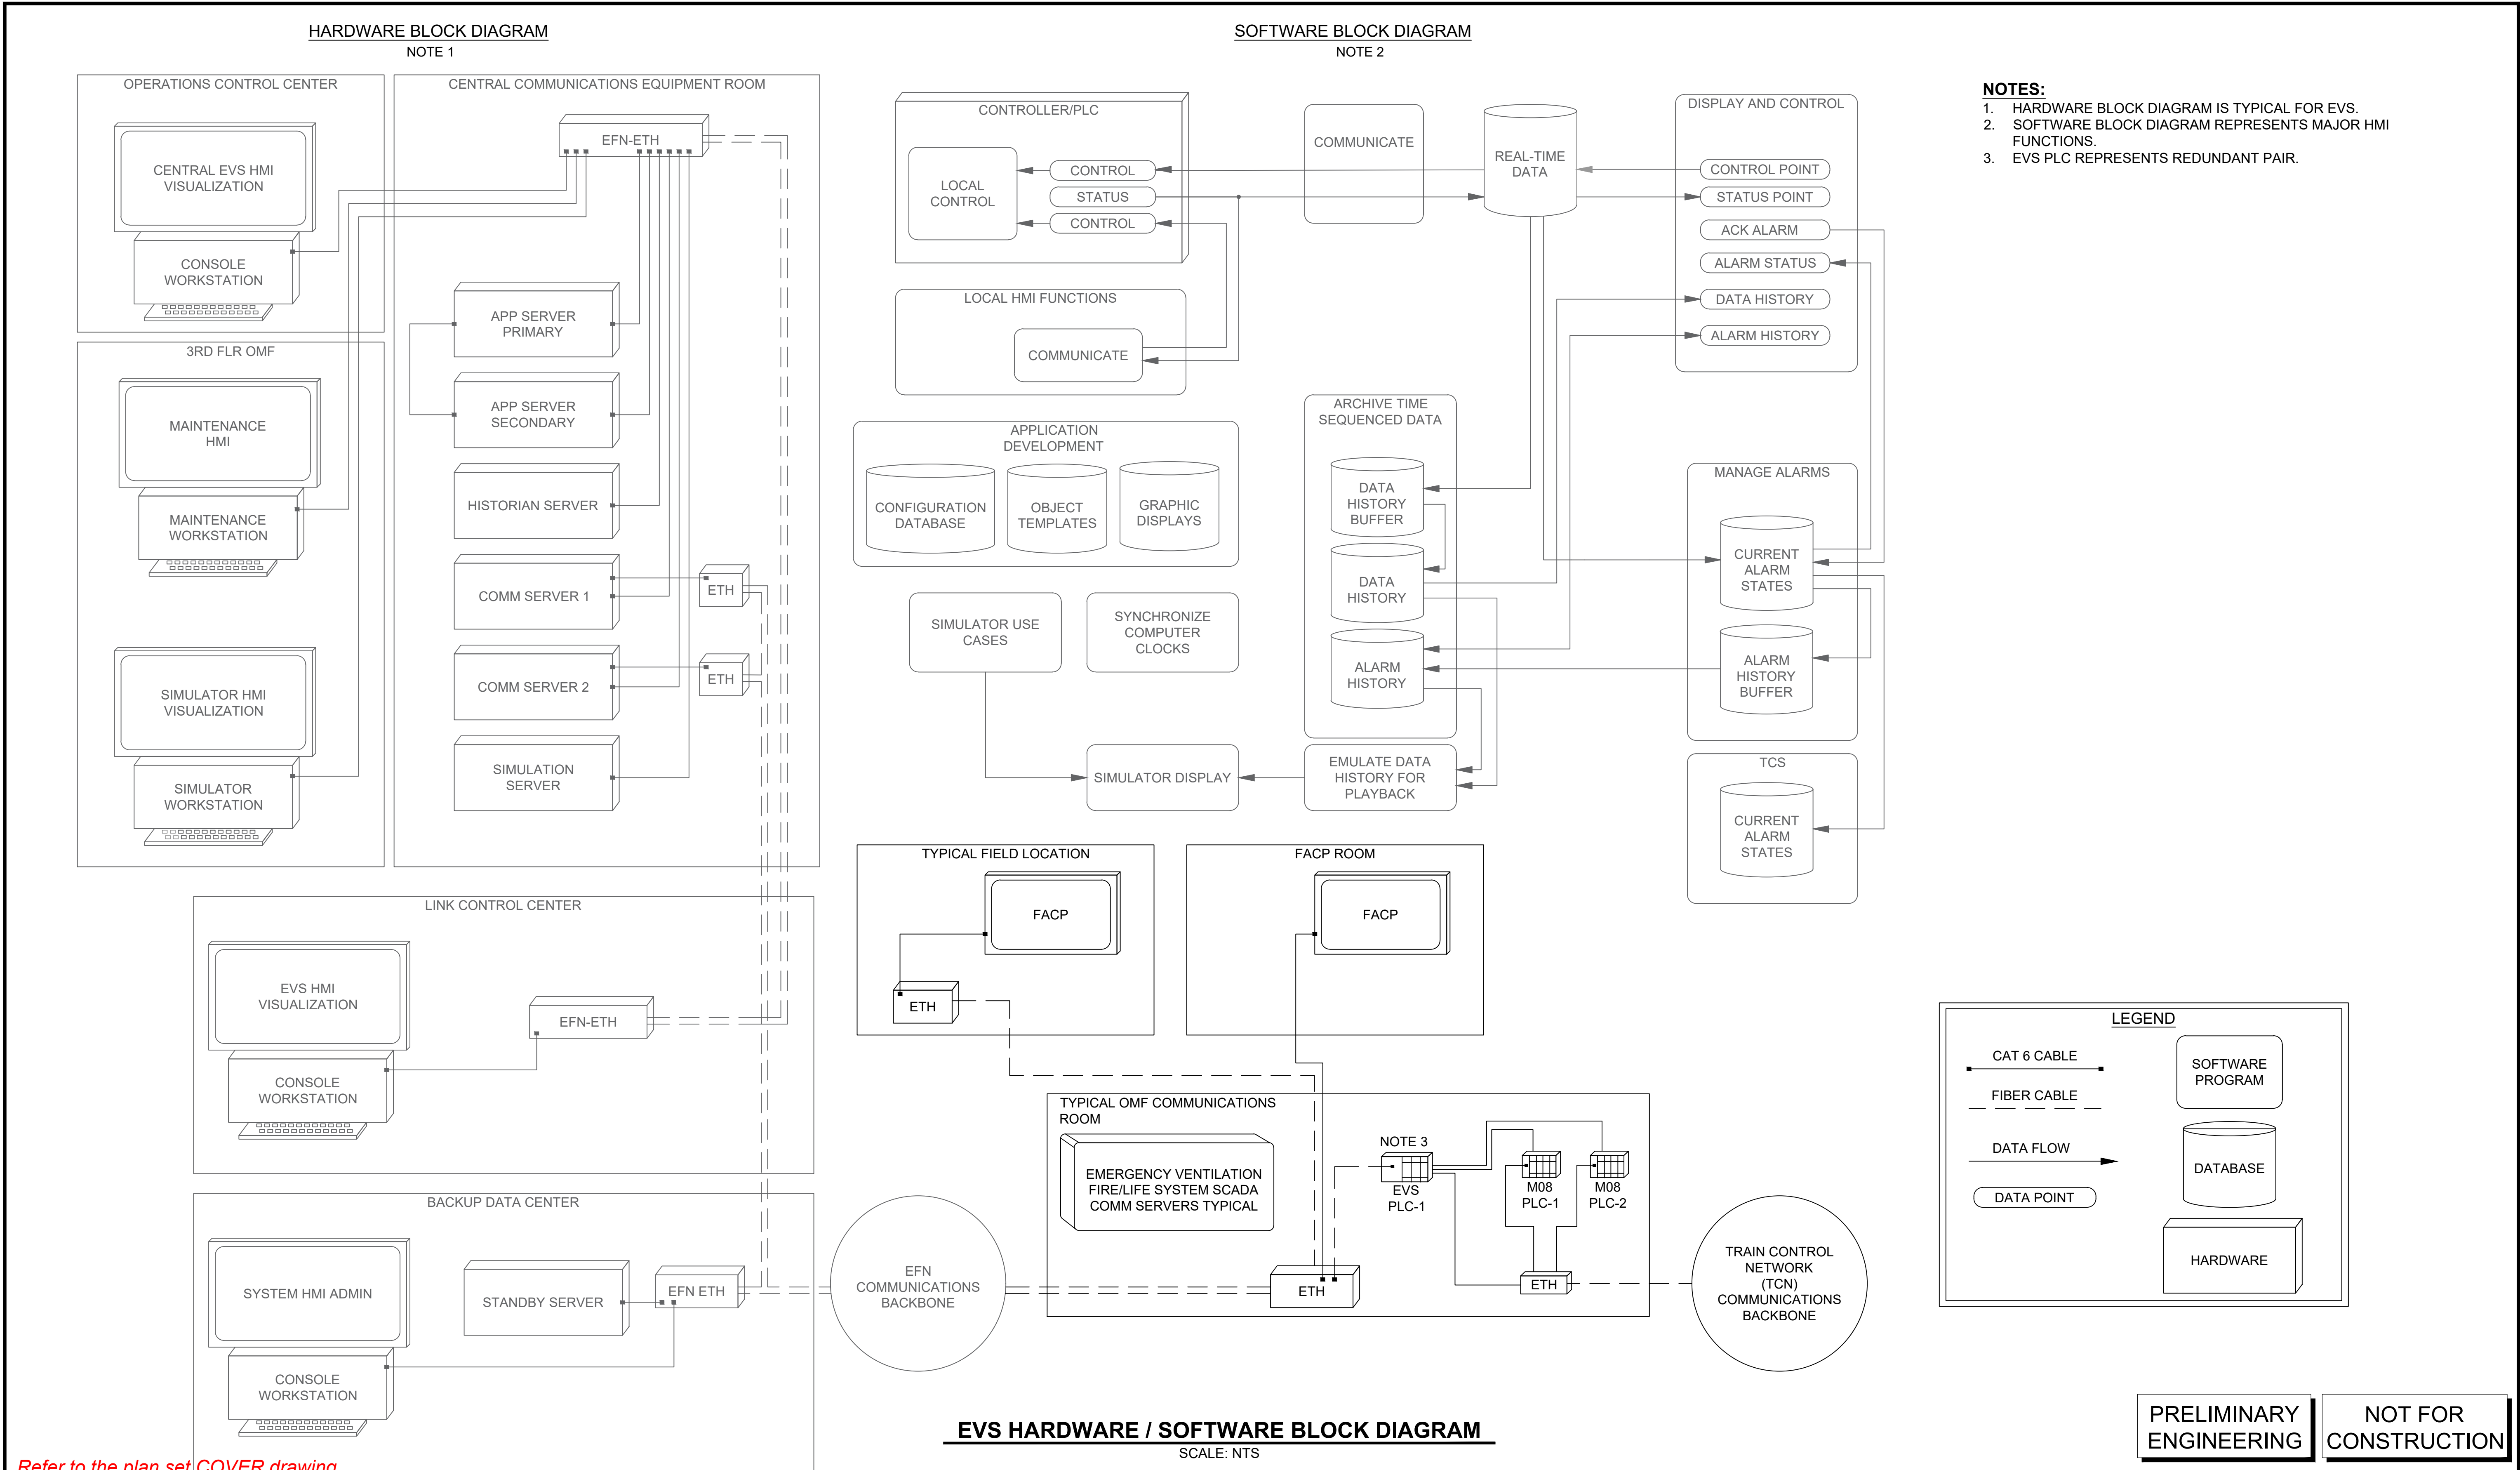

NOTE 1



NOTES:

1. HARDWARE BLOCK DIAGRAM IS TYPICAL FOR BMS.
2. SOFTWARE BLOCK DIAGRAM REPRESENTS MAJOR HMI FUNCTIONS.
3. CONTRACTOR SHALL MODIFY HARDWARE AND SOFTWARE TO INCORPORATE TDLE OMFS. NO NEW HARDWARE REQUIRED AT LCC OR OMF.



CAT 6 CABLE

FIBER CABLE

DATA FLOW

DATA POINT

SOFTWARE
PROGRAM

DATABASE

HARDWARE

PRELIMINARY ENGINEERING

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CONSTRUCTION



BMS SOFTWARE BLOCK DIAGRAM

SCALE: NTS

REFERENCE CONCEPT DRAWINGS

No.	DATE	DSN	CHK	APP	REVISION

DESIGNED BY:	Z. ZHANG
DRAWN BY:	Z. ZHANG
CHECKED BY:	P. PERREAULT
APPROVED BY:	J. SCHIMPF

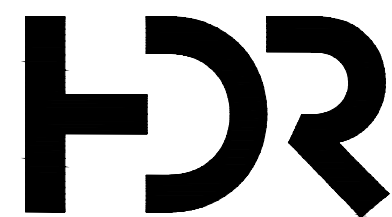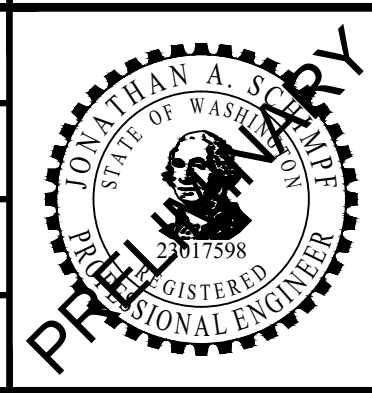

SUBMITTED BY:
PABLO LOPEZ-HILFIKER



BURNS ENGINEERING, INC. | 215 979-7700
TWO COMMERCE SQUARE, 2001 MARKET ST, SUITE
PHILADELPHIA, PA 19103

REVIEWED BY:	
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LINE IS 1" AT FULL SCALE



DATE: _____

PACKAGE #

SCALE:

NTS

FILENAME:

CONTRACT No.:

AE0030-17

DATE:

SOUND TRANSIT
PRELIMINARY ENGINEERING PLANS
OPERATIONS & MAINTENANCE FACILITY SOUTH
COMMUNICATION SYSTEM
BMS HARDWARE/SOFTWARE BLOCK DIAGRAM
BLOCK DIAGRAM

DRAWING No.:

Y03-JCS006

EQUILIBRIUM

Y03 M08 S08

SHEET No.:	REV
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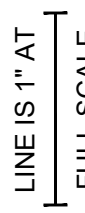
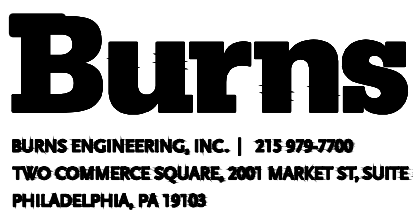
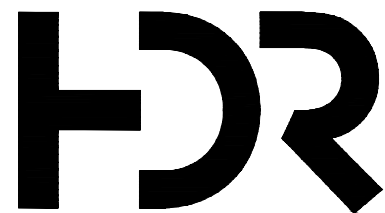
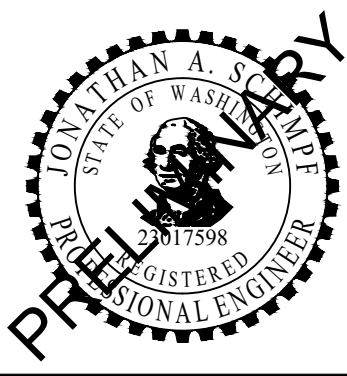
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Refer to the plan set COVER drawing
for disclaimers regarding this drawing.

REFERENCE CONCEPT DRAWINGS

No.	DATE	DSN	CHK	APP	REVISION

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DRAWN BY:	Z. ZHANG
CHECKED BY:	M. STAHLLEY
APPROVED BY:	J. SCHIMPF




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PABLO LOPEZ-HILFIKER	2/27/2024		

PACKAGE #
SCALE:
NTS
FILENAME:
OMFS-Y03-JCS007
CONTRACT No.:
AE0030-17
DATE:

SOUND TRANSIT
PRELIMINARY ENGINEERING PLANS
OPERATIONS & MAINTENANCE FACILITY SOUTH

COMMUNICATION SYSTEM
SYSTEM COMMUNICATIONS FIBER
NETWORK TOPOLOGY DIAGRAM

DRAWING No.:	Y03-JCS007
FACILITY ID:	Y03, M08
SHEET No.:	REV:
	0

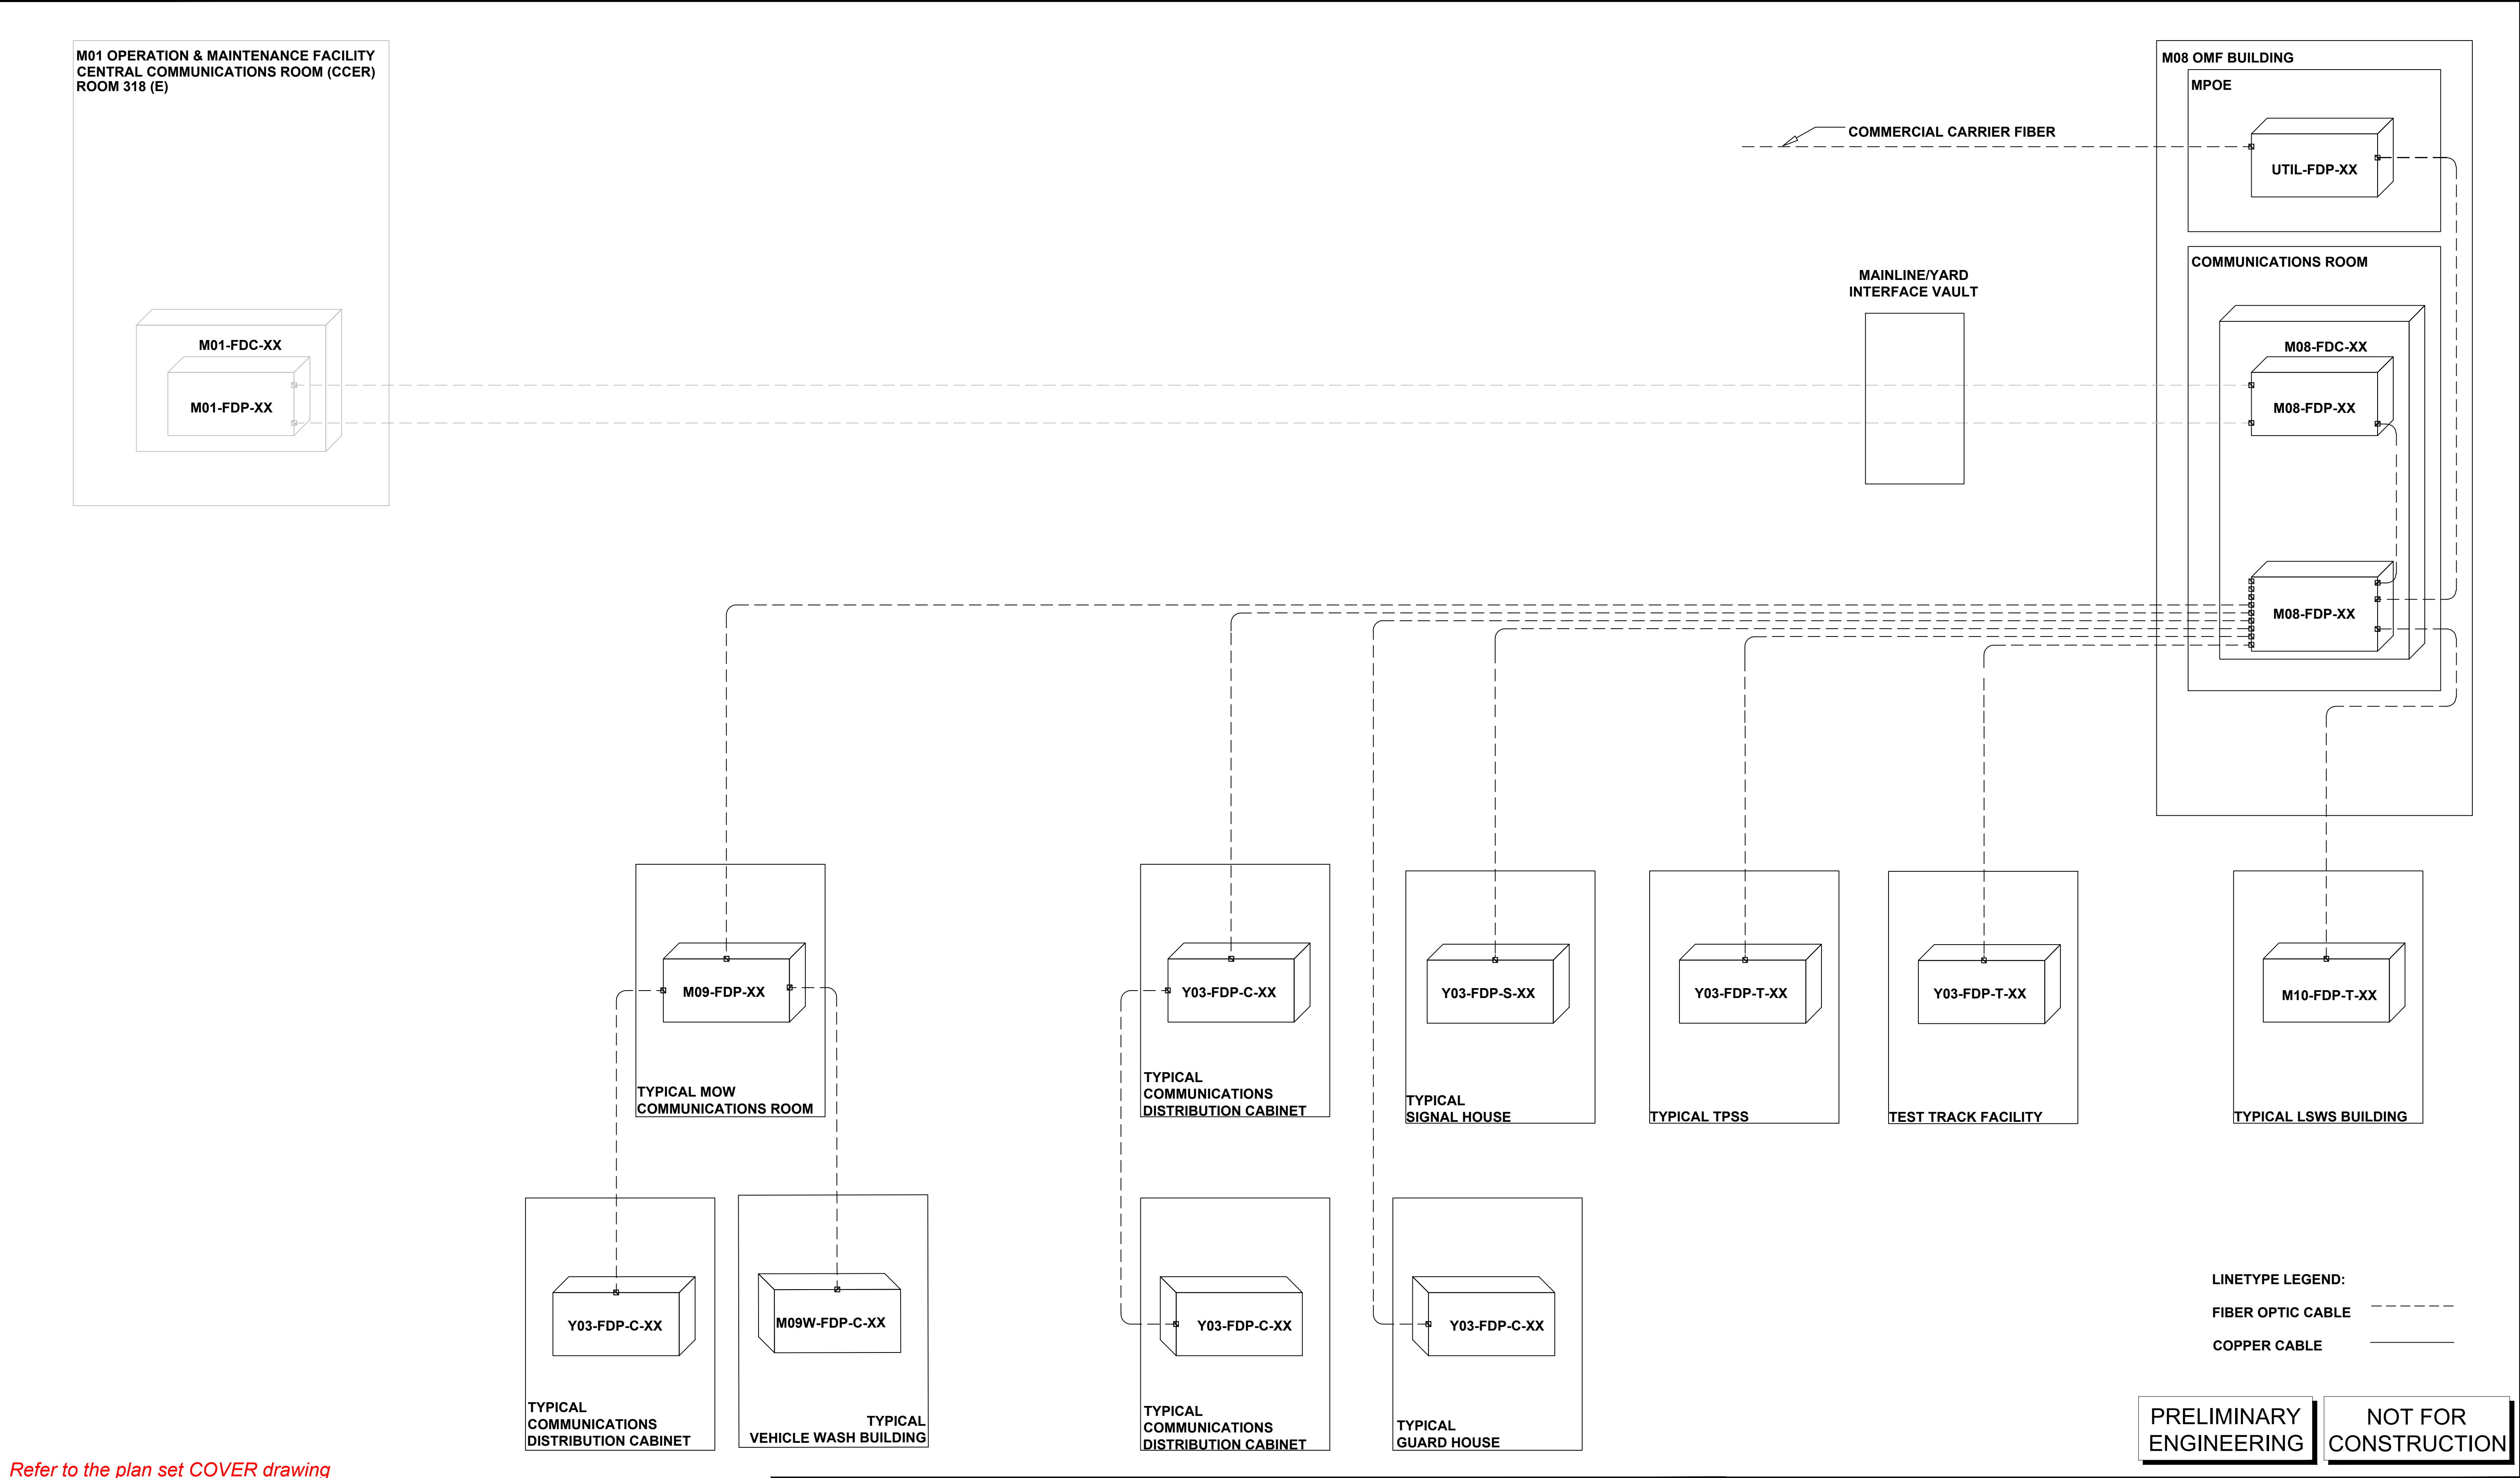

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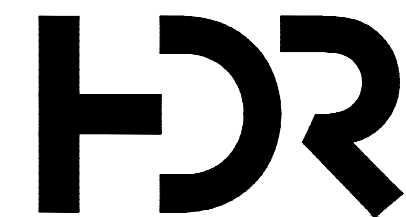
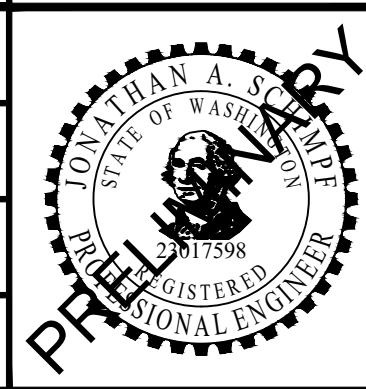
Refer to the plan set COVER drawing
for disclaimers regarding this drawing.

REFERENCE CONCEPT DRAWINGS

No.	DATE	DSN	CHK	APP	REVISION

DESIGNED BY:	Z. ZHANG
DRAWN BY:	Z. ZHANG
CHECKED BY:	P. PERREAULT
APPROVED BY:	J. SCHIMPF

AHJ:



LINE IS 1" AT
FULL SCALE




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SCALE:	NTS
FILENAME:	OMFS-Y03-JCS008
CONTRACT No.:	AE0030-17
DATE:	

**SOUND TRANSIT
PRELIMINARY ENGINEERING PLANS**
OPERATIONS & MAINTENANCE FACILITY SOUTH

COMMUNICATION SYSTEM
TYPICAL CCTV FUNCTIONAL
BLOCK DIAGRAM

DRAWING No.:	Y03-JCS008
FACILITY ID:	Y03, M08
SHEET No.:	REV:
	0

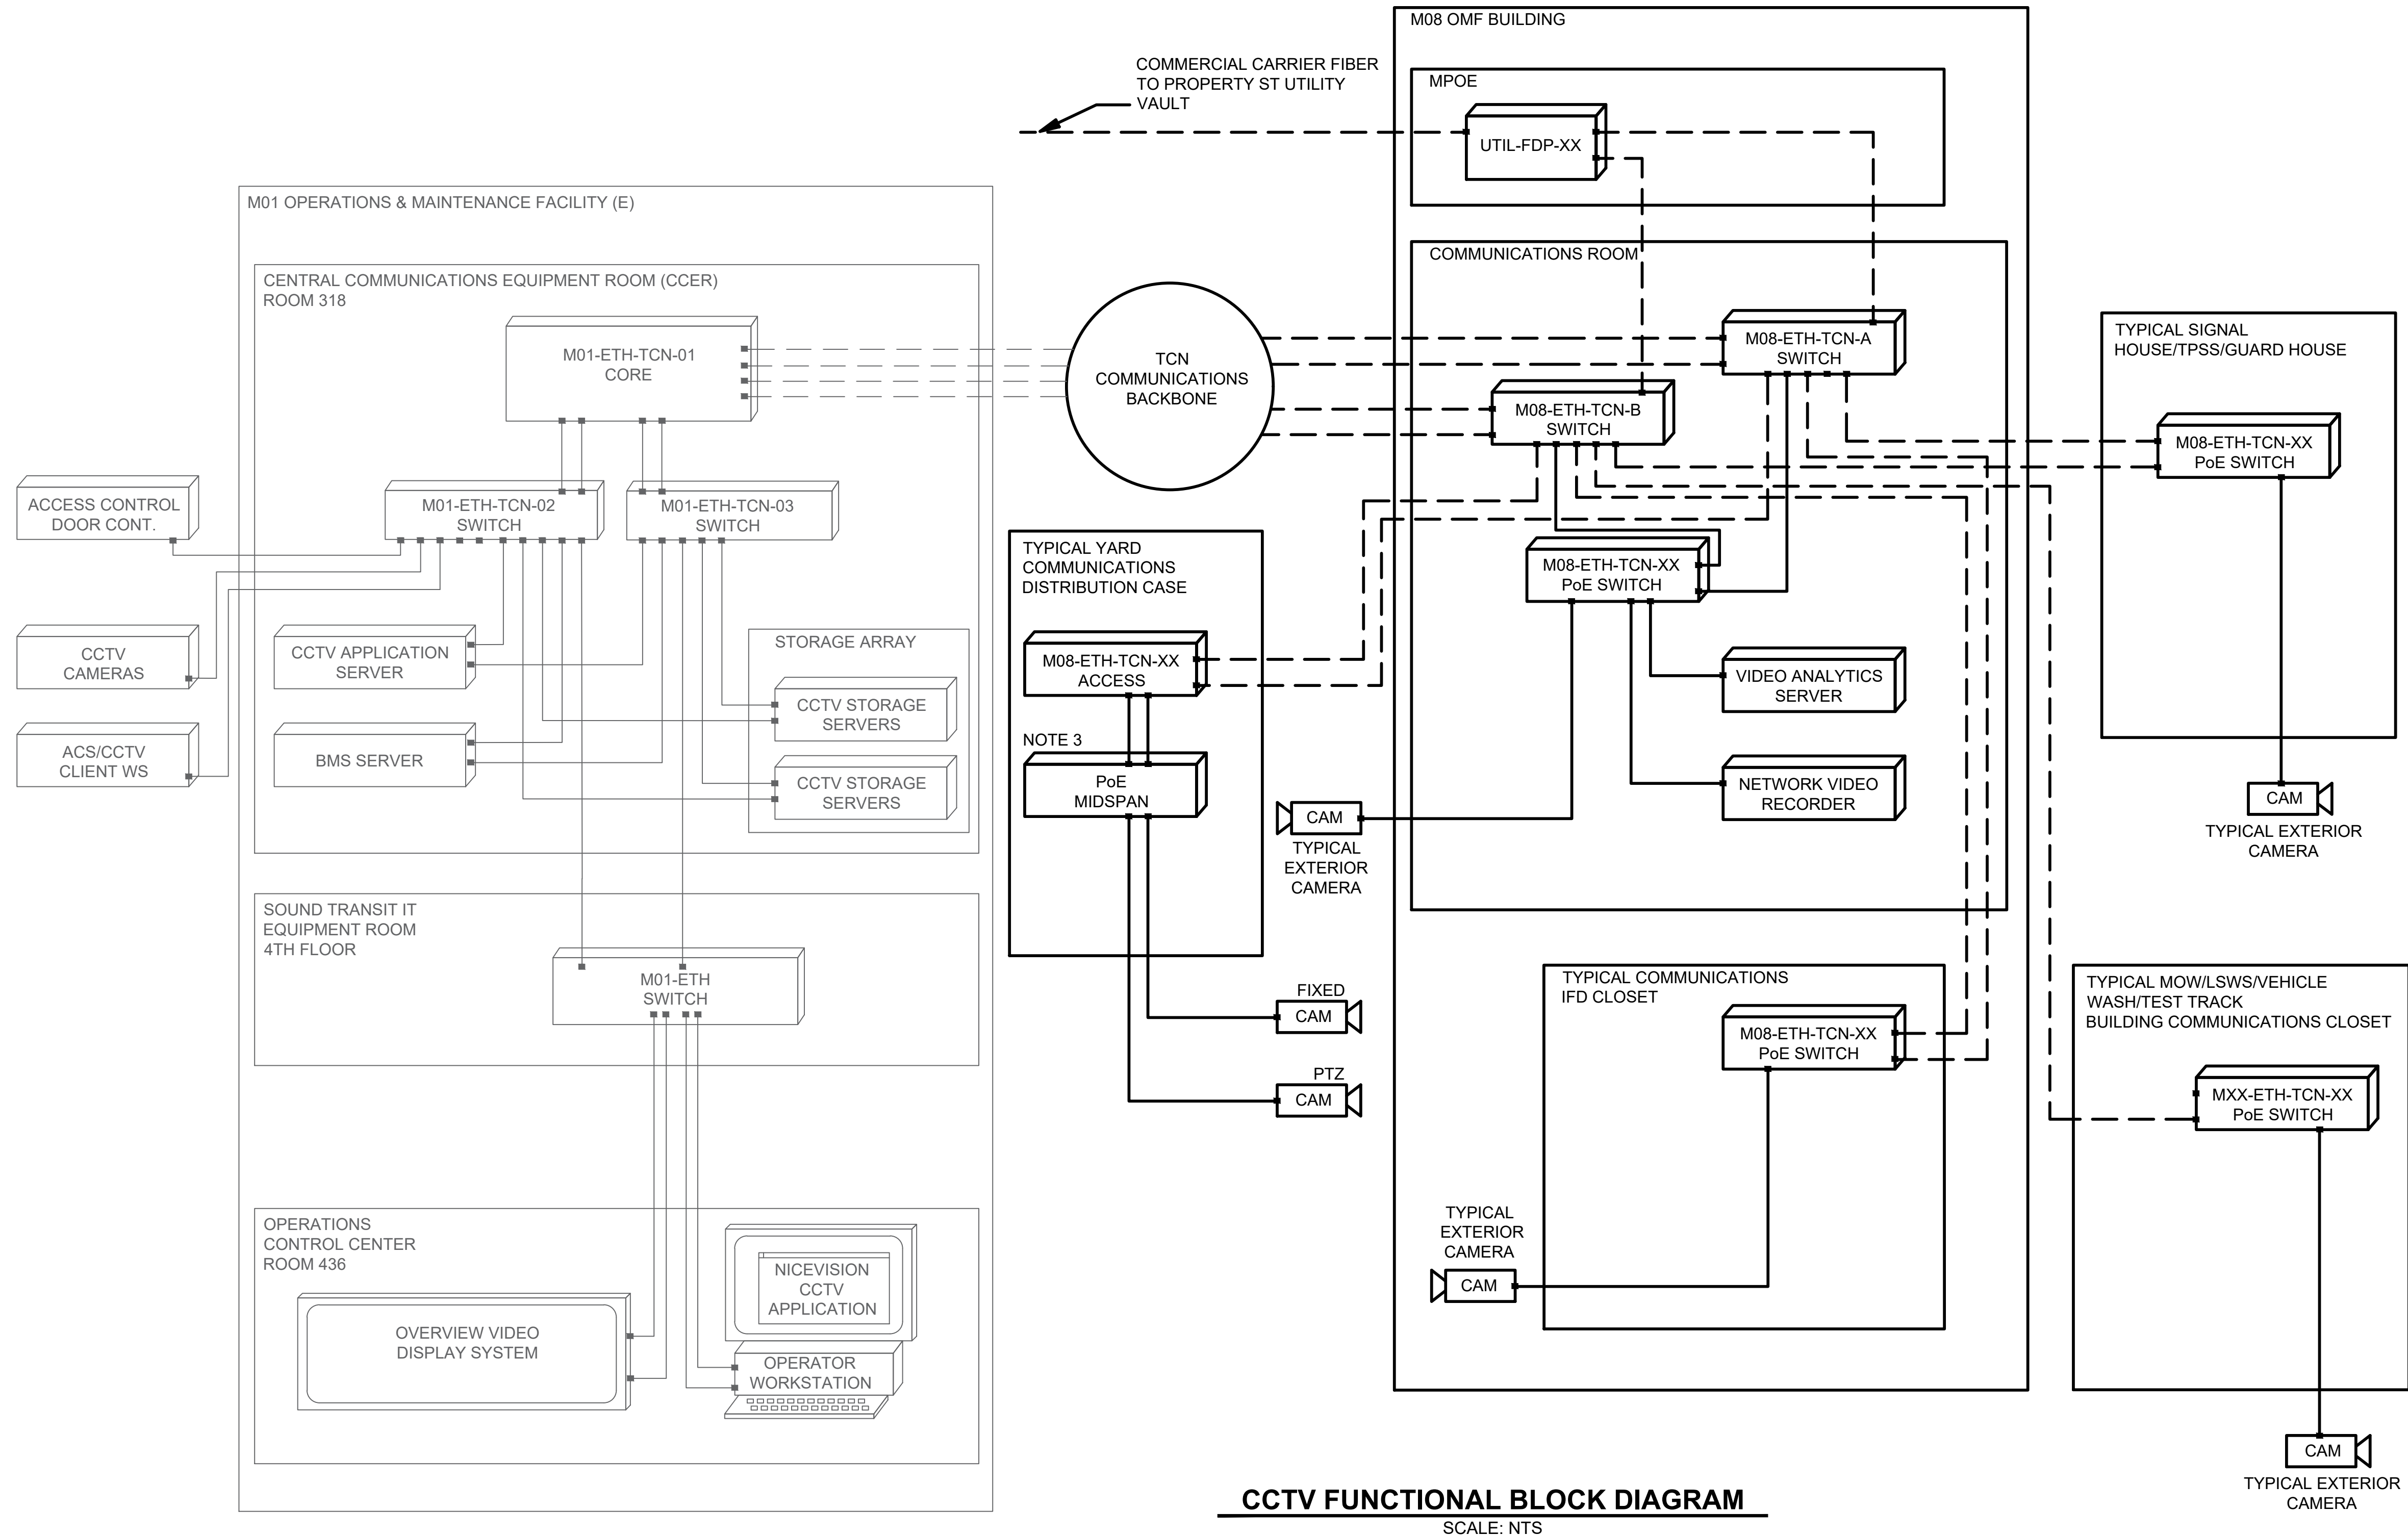

NOTES:

- CONNECT TO EXISTING TCN BACKBONE IN COMMUNICATIONS ROOM. REVIEW AND CONFIRM SOFTWARE APPLICATIONS AND VERSIONS WITH ST.
- TYPICAL CAMERA SHOWN REPRESENTS FIXED OR PAN-TILT-ZOOM IP CAMERAS.
- SEE JCD604 FOR COMMUNICATIONS DEVICES POWER ISOLATION ARCHITECTURE.
- MIDSPAN POWER INJECTOR MUST SUPPLY SUFFICIENT POWER PER PORT TO ACCOMMODATE ALL ATTACHED IP CAMERAS, INCLUDING PTZ AND HEATER FUNCTIONALITY.
- CONNECT TO EXISTING OMF HEADEND QOGNIFY/NICE VISION CCTV APPLICATION AND STORAGE SYSTEM. PROVIDE ADDITIONAL SOFTWARE LICENSES TO EXPAND QOGNIFY/NICE VISION APPLICATION. IT TO PROVIDE SOUND TRANSIT BACKUP CCTV STORAGE SYSTEM AT BACKUP DATA CENTER. ADD ADDITIONAL STORAGE EQUAL TO AMOUNT REQUIRED FOR FUTURE EXTENSION PLUS 25% SPARE.
- CONTRACTOR SHALL INSTALL NETWORK SWITCH EQUIPMENT PROVIDED AND CONFIGURED BY SOUND TRANSIT IT DEPT.
- FIBER DISTRIBUTION PANELS NOT SHOWN FOR CLARITY.
- CCTV AND BMS INTERFACE PROVIDES CAMERA SELECTION, VIEWING AND CONTROL.
- ICC - INTEGRATED COMMUNICATIONS CONSOLE DESKS HAVE CCTV VIEWING (10 DESKS AT 3 FACILITIES). OPTIONAL CCTV VIEWER MAY BE ADDED TO SECURITY PERSONNEL ROOM AT END OF LINE STATIONS.
- CCTV SYSTEM WEB SERVER MAY HAVE LIMITED CONTACT WITH 3RD PARTY, TO ALLOW VIEW CAPABILITIES, BASED ON AGREEMENTS WITH ST. WHEN APPLICABLE, COORDINATE FIREWALL SETTINGS WITH ST-IT.
- PLASTIC (NON-CONDUCTIVE) CASED CAMERA THAT HAS NO CONDUCTIVE SAFETY GROUND MAY BE POWERED BY NON-ISOLATED POE, AS PER DRAWING JCD604 "COMMUNICATION DEVICES POWER ISOLATION ARCHITECTURE: INJECTOR POE, DC SUPPLY, AND CAT6 SHIELD GROUNDING CABLES"
- QOGNIFY/NICE VISION CCTV APPLICATION SERVER AND BMS DESKTOP, LOCATED AT SCADA ROOM. OVERVIEW VIDEO AND DESKTOP BMS LOCATED AT OCC AND BACKUP-OCC.
- REFER TO SHEET JZN002 FOR SYMBOLS AND ABBREVIATIONS.



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for disclaimers regarding this drawing.

REFERENCE CONCEPT DRAWINGS

No.	DATE	DSN	CHK	APP	REVISION

DESIGNED BY:	Z. ZHANG
DRAWN BY:	Z. ZHANG
CHECKED BY:	P. PERREAULT
APPROVED BY:	J. SCHIMPF

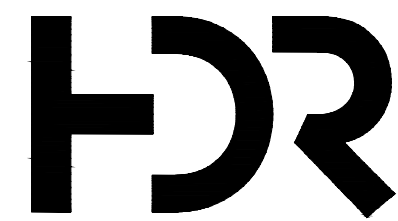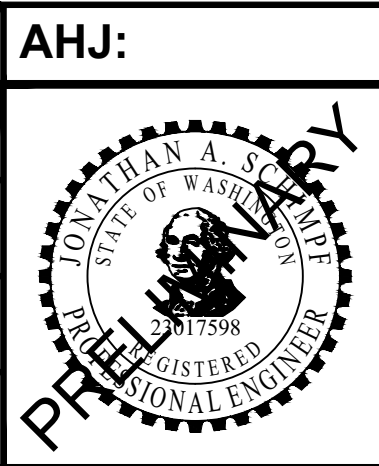

SUBMITTED BY:
PABLO LOPEZ-HILFIKER

DATE:
2/27/2024



BURNS ENGINEERING, INC. | 215 979-7700
TWO COMMERCE SQUARE, 2001 MARKET ST, SUITE 600
PHILADELPHIA, PA 19103

REVIEWED BY:

LINE IS 1" AT
FULL SCALE




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PACKAGE #
SCALE: NTS
FILENAME: OMFS-Y03-JCS009
CONTRACT No.: AE0030-17
DATE:

SOUND TRANSIT
PRELIMINARY ENGINEERING PLANS
OPERATIONS & MAINTENANCE FACILITY SOUTH

COMMUNICATION SYSTEM
ACCESS CONTROL SYSTEMS

DRAWING No.:	Y03-JCS009
FACILITY ID:	Y03, M08, S08
SHEET No.:	REV:
	0

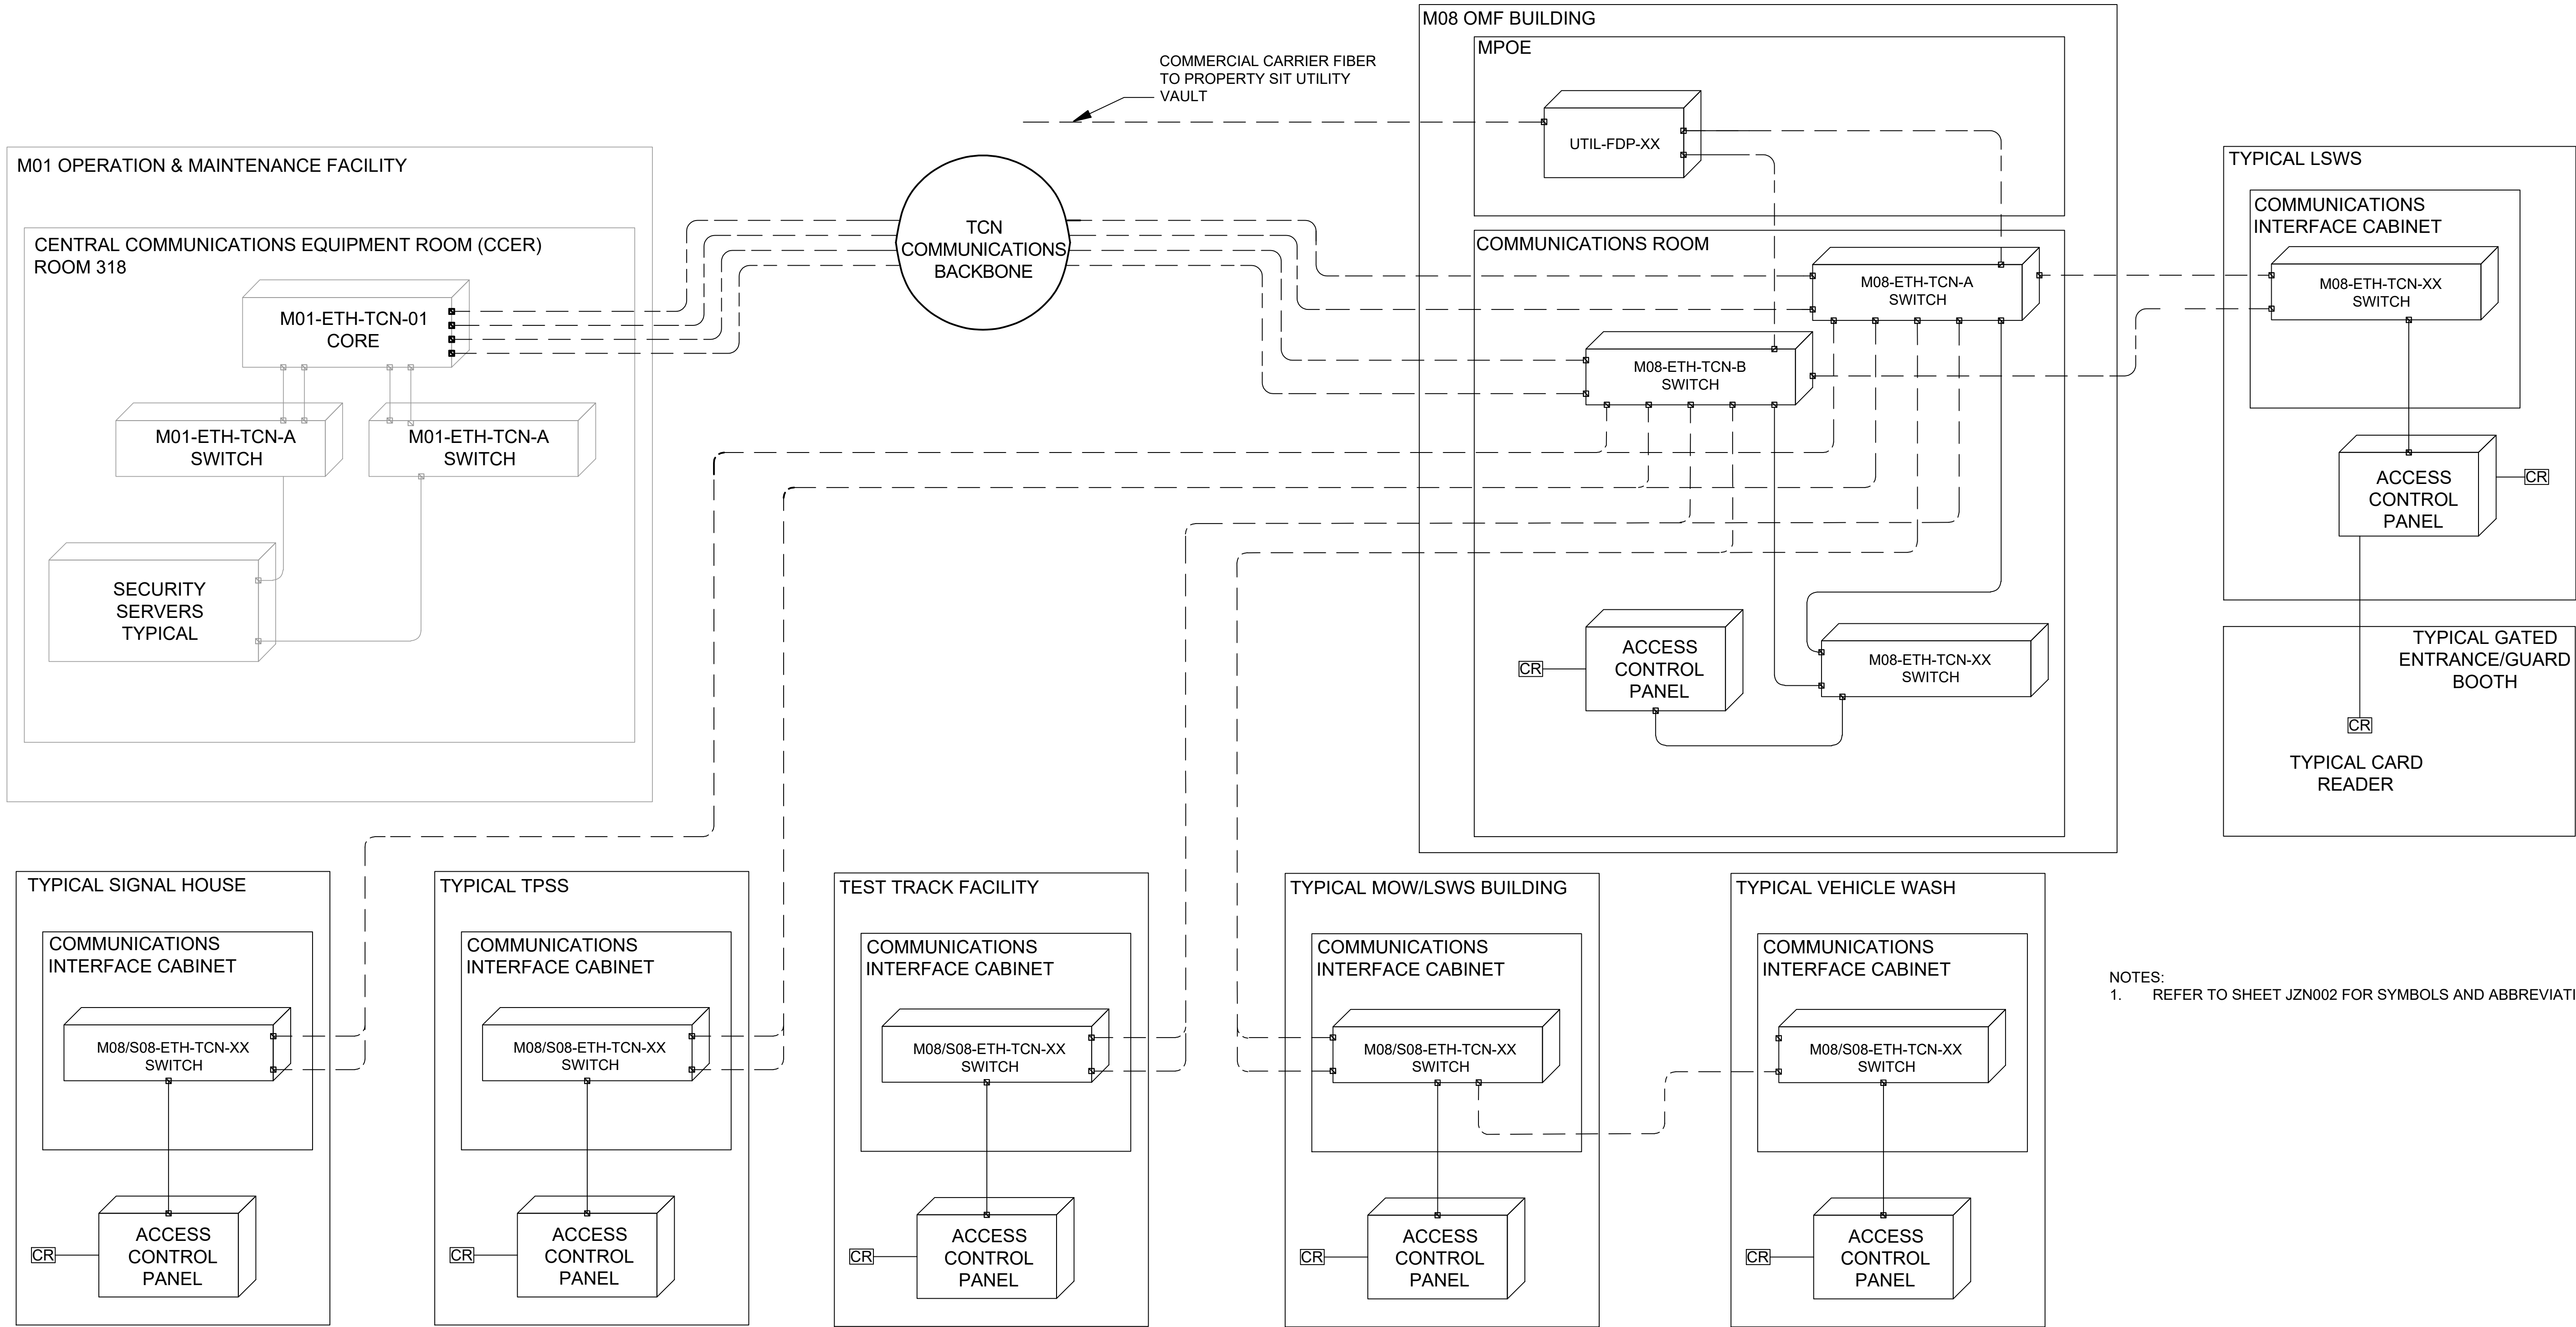

NOTES:
1. REFER TO SHEET JZN002 FOR SYMBOLS AND ABBREVIATIONS

LINETYPE LEGEND:

FIBER OPTIC CABLE


COPPER CABLE

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ENGINEERING**

**NOT FOR
CONSTRUCTION**

ACCESS CONTROL BLOCK DIAGRAM
SCALE: NTS

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NOTES:

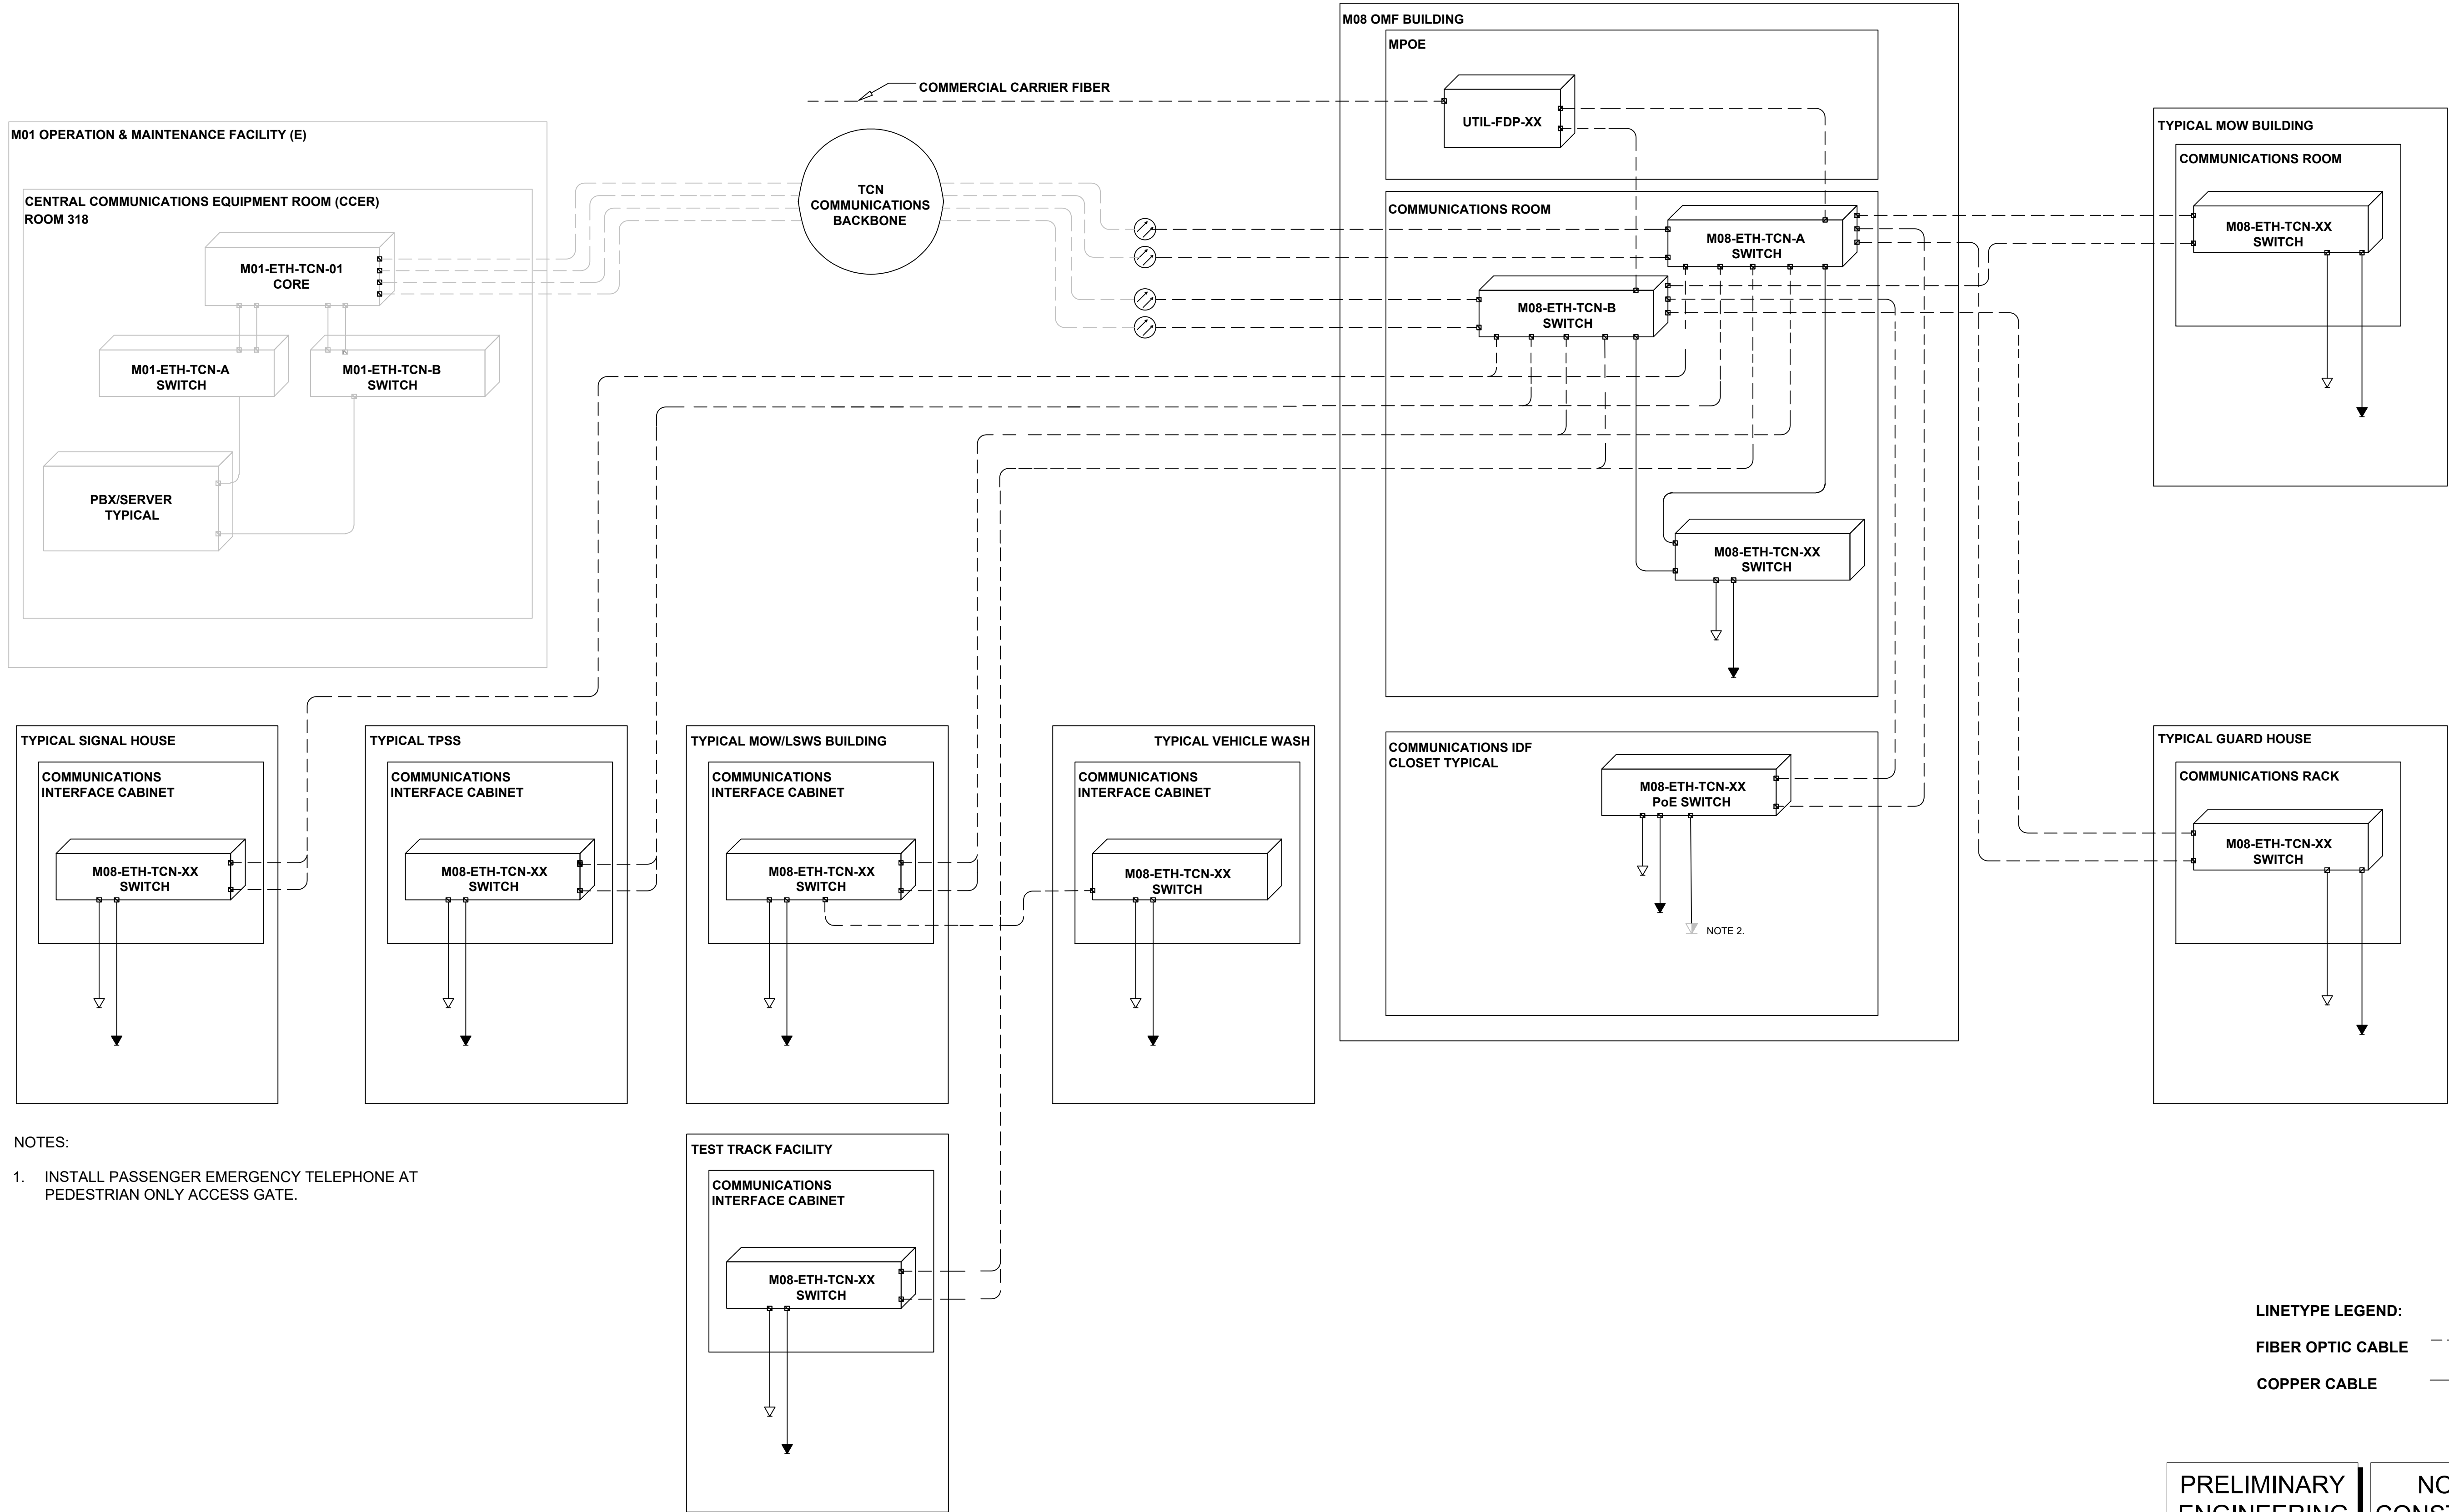1. INSTALL PASSENGER EMERGENCY TELEPHONE AT PEDESTRIAN ONLY ACCESS GATE.

LINETYPE LEGEND:

FIBER OPTIC CABLE

COPPER CABLE

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ENGINEERING

NOT FOR
CONSTRUCTION



Refer to the plan set COVER drawing
for disclaimers regarding this drawing.

REFERENCE CONCEPT DRAWINGS

No.	DATE	DSN	CHK	APP	REVISION

DESIGNED BY:
Z. ZHANG
DRAWN BY:
Z. ZHANG
CHECKED BY:
P. PERREAULT
APPROVED BY:
J. SCHIMPF

AHJ:

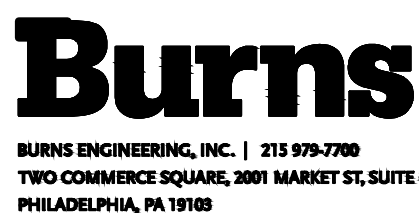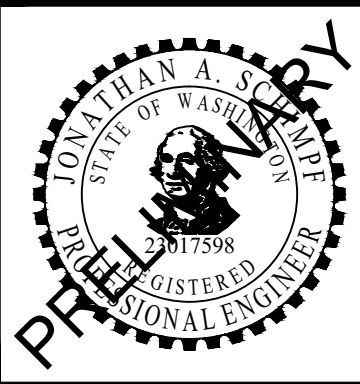

LINE IS 1" AT
FULL SCALE



SUBMITTED BY:
PABLO LOPEZ-HILFIKER

DATE:
2/27/2024

REVIEWED BY:

DATE:


PACKAGE #

SCALE:
NTS
FILENAME:
OMFS-Y03-JCS010
CONTRACT No.:
AE0030-17
DATE:

SOUND TRANSIT
PRELIMINARY ENGINEERING PLANS
OPERATIONS & MAINTENANCE FACILITY SOUTH
COMMUNICATION SYSTEM
TYPICAL TELECOM SYSTEMS
BLOCK DIAGRAM

DRAWING No.:
Y03-JCS010
FACILITY ID:
Y03, M08, S08
SHEET No.:
REV:
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- NOTES:
- COORDINATE MOUNTING METHODS FOR ANTENNA WITH CIVIL DESIGNER.
 - TERMINATE EACH CABLE ON A TERMINATION RATED FOR THE INTENDED USE.
 - DESIGN FOR ANY TEMPORARY REQUIREMENTS NEEDED FOR CONSTRUCTION PHASING USING A UTILITY CONNECTION AS NECESSARY. FINAL CONFIGURATION SHALL ALLOW THIRD PARTY MAINTENANCE MONITORING.
 - RADIO BNC TERMINATION.
 - CAT6 OR FIBER, AS REQUIRED BASED ON DISTANCE, FROM THE COMMUNICATIONS ROOM TO THE ELEVATOR MACHINE ROOM AND PROVIDE TRANSPORT VIA THE TCN TO ALL COMMUNICATION DEVICES SHOWN IN THE ELEVATOR.
 - ACCESS CONTROL CARD READER LOCATION(S) TO BE DETERMINED BASED ON STATION CONFIGURATION. ACCESS CONTROL CARD READER LOCATED AT EACH ENTRY TO ELEVATOR. READER SHALL ALLOW ENTRY TO CAB DURING NON-REVENUE HOURS. SHALL ALSO ALLOW FOR ACCESS TO SECURED FLOORS. ELEVATOR SHALL HAVE BMS REMOTE PERMISSION TO ACCESS ELEVATOR CAB AND SECURED FLOORS.
 - RECALL FUNCTIONALITY AS REQUIRED BY CODE. TYPICAL RECALL TRIGGER BY HEAT OR SMOKE IN ELEVATOR SHAFT, HEAT IN LOBBY OR SMOKE IN ELEVATOR MACH ROOM.
 - AS REQUIRED BY AUTHORITY HAVING JURISDICTION (AHJ).
 - COORDINATE WITH ST, AHJ AND ARCHITECTURE TO IDENTIFY ADDITIONAL REQUIREMENTS SUCH AS A FIRE DEPARTMENT RADIO INPUT JACK.
 - REFER TO JZN002 AND JZN004 FOR SYMBOLS AND ABBREVIATIONS.

ELEVATOR INTERFACING BLOCK DIAGRAM
SCALE: NTS

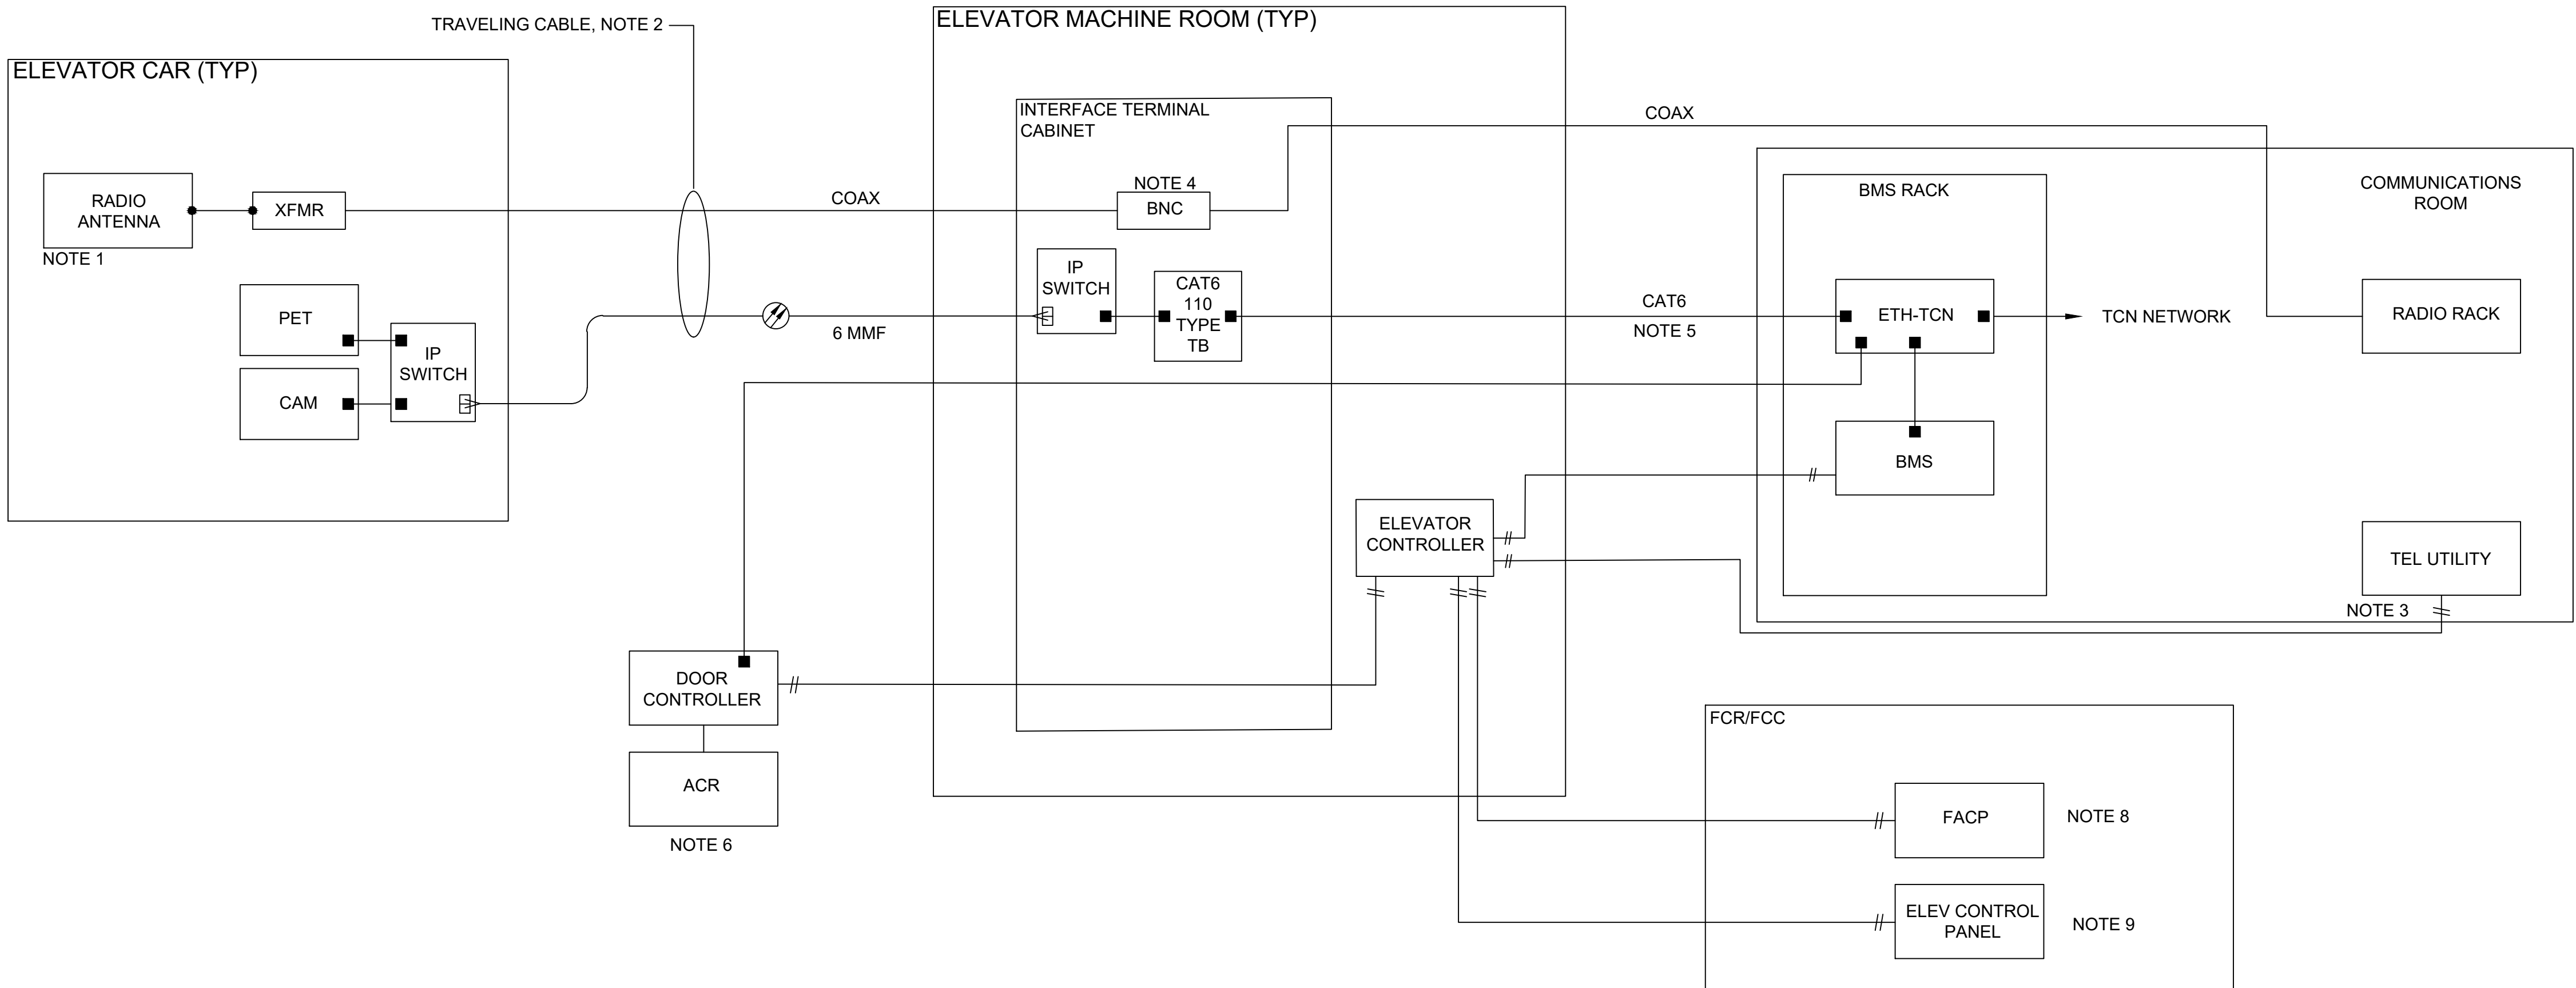Refer to the plan set COVER drawing
for disclaimers regarding this drawing.

PRELIMINARY
ENGINEERING

NOT FOR
CONSTRUCTION

REFERENCE CONCEPT DRAWINGS

No.	DATE	DSN	CHK	APP	REVISION

DESIGNED BY:	Z. ZHANG
DRAWN BY:	Z. ZHANG
CHECKED BY:	P. PERREAULT
APPROVED BY:	J. SCHIMPF

AHJ:					PACKAGE #								
									<div>SOUND TRANSIT PRELIMINARY ENGINEERING PLANS OPERATIONS & MAINTENANCE FACILITY SOUTH COMMUNICATION SYSTEM TYPICAL ELEVATOR INTERFACING BLOCK DIAGRAM</div>			DRAWING No.:	
												Y03-JCS011	
												FACILITY ID:	
												Y03, M08	
	SHEET No.:		REV:										
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SUBMITTED BY:		DATE:		REVIEWED BY:		DATE:							
PABLO LOPEZ-HILFIKER		2/27/2024											





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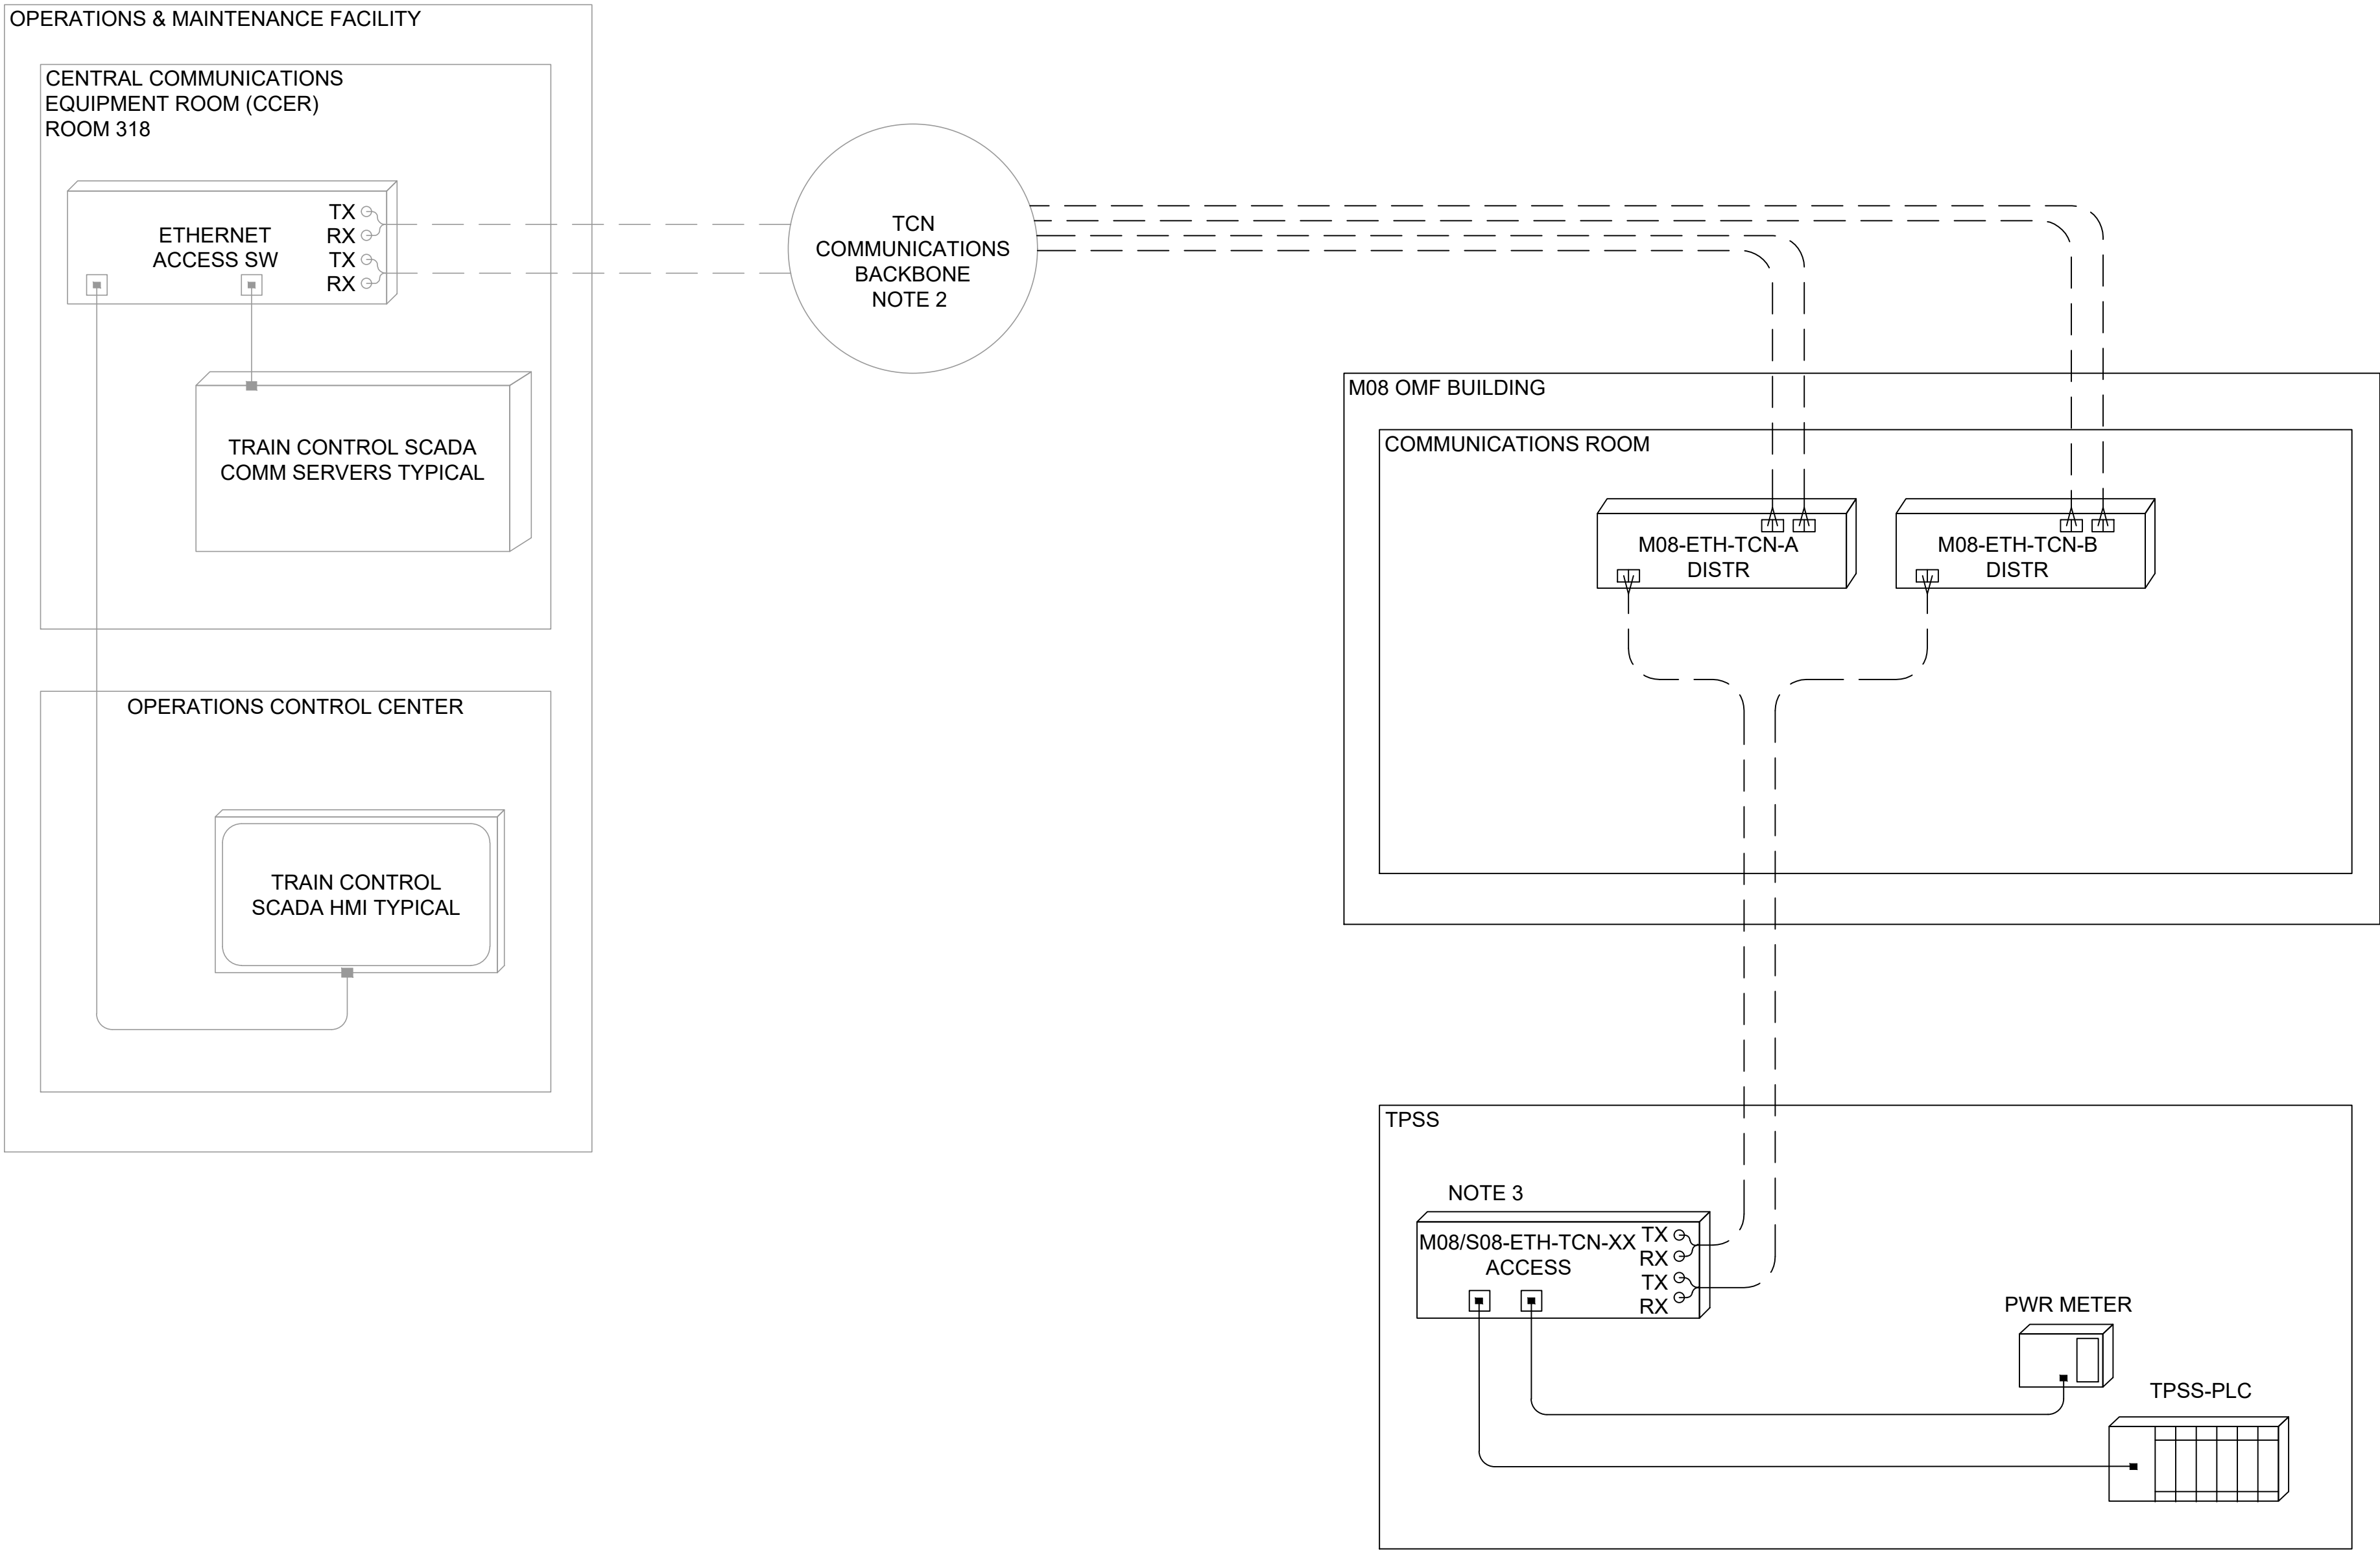
Refer to the plan set COVER drawing
for disclaimers regarding this drawing.

REFERENCE CONCEPT DRAWINGS

No.	DATE	DSN	CHK	APP	REVISION

DESIGNED BY:	Z. ZHANG
DRAWN BY:	Z. ZHANG
CHECKED BY:	P. PERREAULT
APPROVED BY:	J. SCHIMPF

AHJ:					PACKAGE #				
				SCALE:	SOUND TRANSIT PRELIMINARY ENGINEERING PLANS OPERATIONS & MAINTENANCE FACILITY SOUTH COMMUNICATION SYSTEM TYPICAL TPSS TCS SCADA INTERFACE BLOCK DIAGRAM	DRAWING No.:			
				FILENAME:		FACILITY ID:			
				CONTRACT No.:		Y03, S08			
				DATE:		SHEET No.: REV:			
SUBMITTED BY:		DATE:		REVIEWED BY:		0			
PABLO LOPEZ-HILFIKER		2/27/2024							

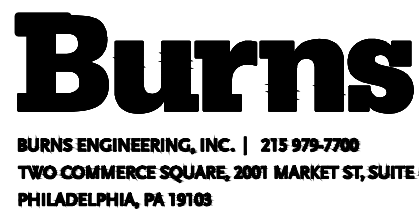


- NOTES:**
1. PROVIDE CAT6 PATCH PANEL, CAT6 PATCH CORD INTERCONNECTION, FIBER DISTRIBUTION PANEL, AND FIBER CABLE.
 2. CONNECT TCN EXPANSION TO EXISTING TCN BACKBONE.
 3. PROVIDE ACCESS SWITCHES SIZED TO ACCOMMODATE IP DEVICES. SWITCH CONFIGURATION PROVIDED BY SOUND TRANSIT IT DEPT.
 4. FIBER PATCH PANELS NOT SHOWN FOR CLARITY.

TPSS TCS SCADA INTERFACE BLOCK DIAGRAM
SCALE: NTS

PRELIMINARY ENGINEERING NOT FOR CONSTRUCTION

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- NOTES:**
1. PROVIDE CAT6 PATCH PANEL, CAT6 PATCH CORD INTERCONNECTION, FIBER PATCH CORDS, AND FIBER PATCH PANELS.
 2. CONNECT TCN EXPANSION TO EXISTING TCN COMMUNICATION BACKBONE.
 3. PROVIDE ACCESS SWITCHES SIZED TO ACCOMMODATE IP DEVICES. SWITCH CONFIGURATION PROVIDED BY SOUND TRANSIT IT DEPT.
 4. FIBER PATCH PANELS NOT SHOWN FOR CLARITY.

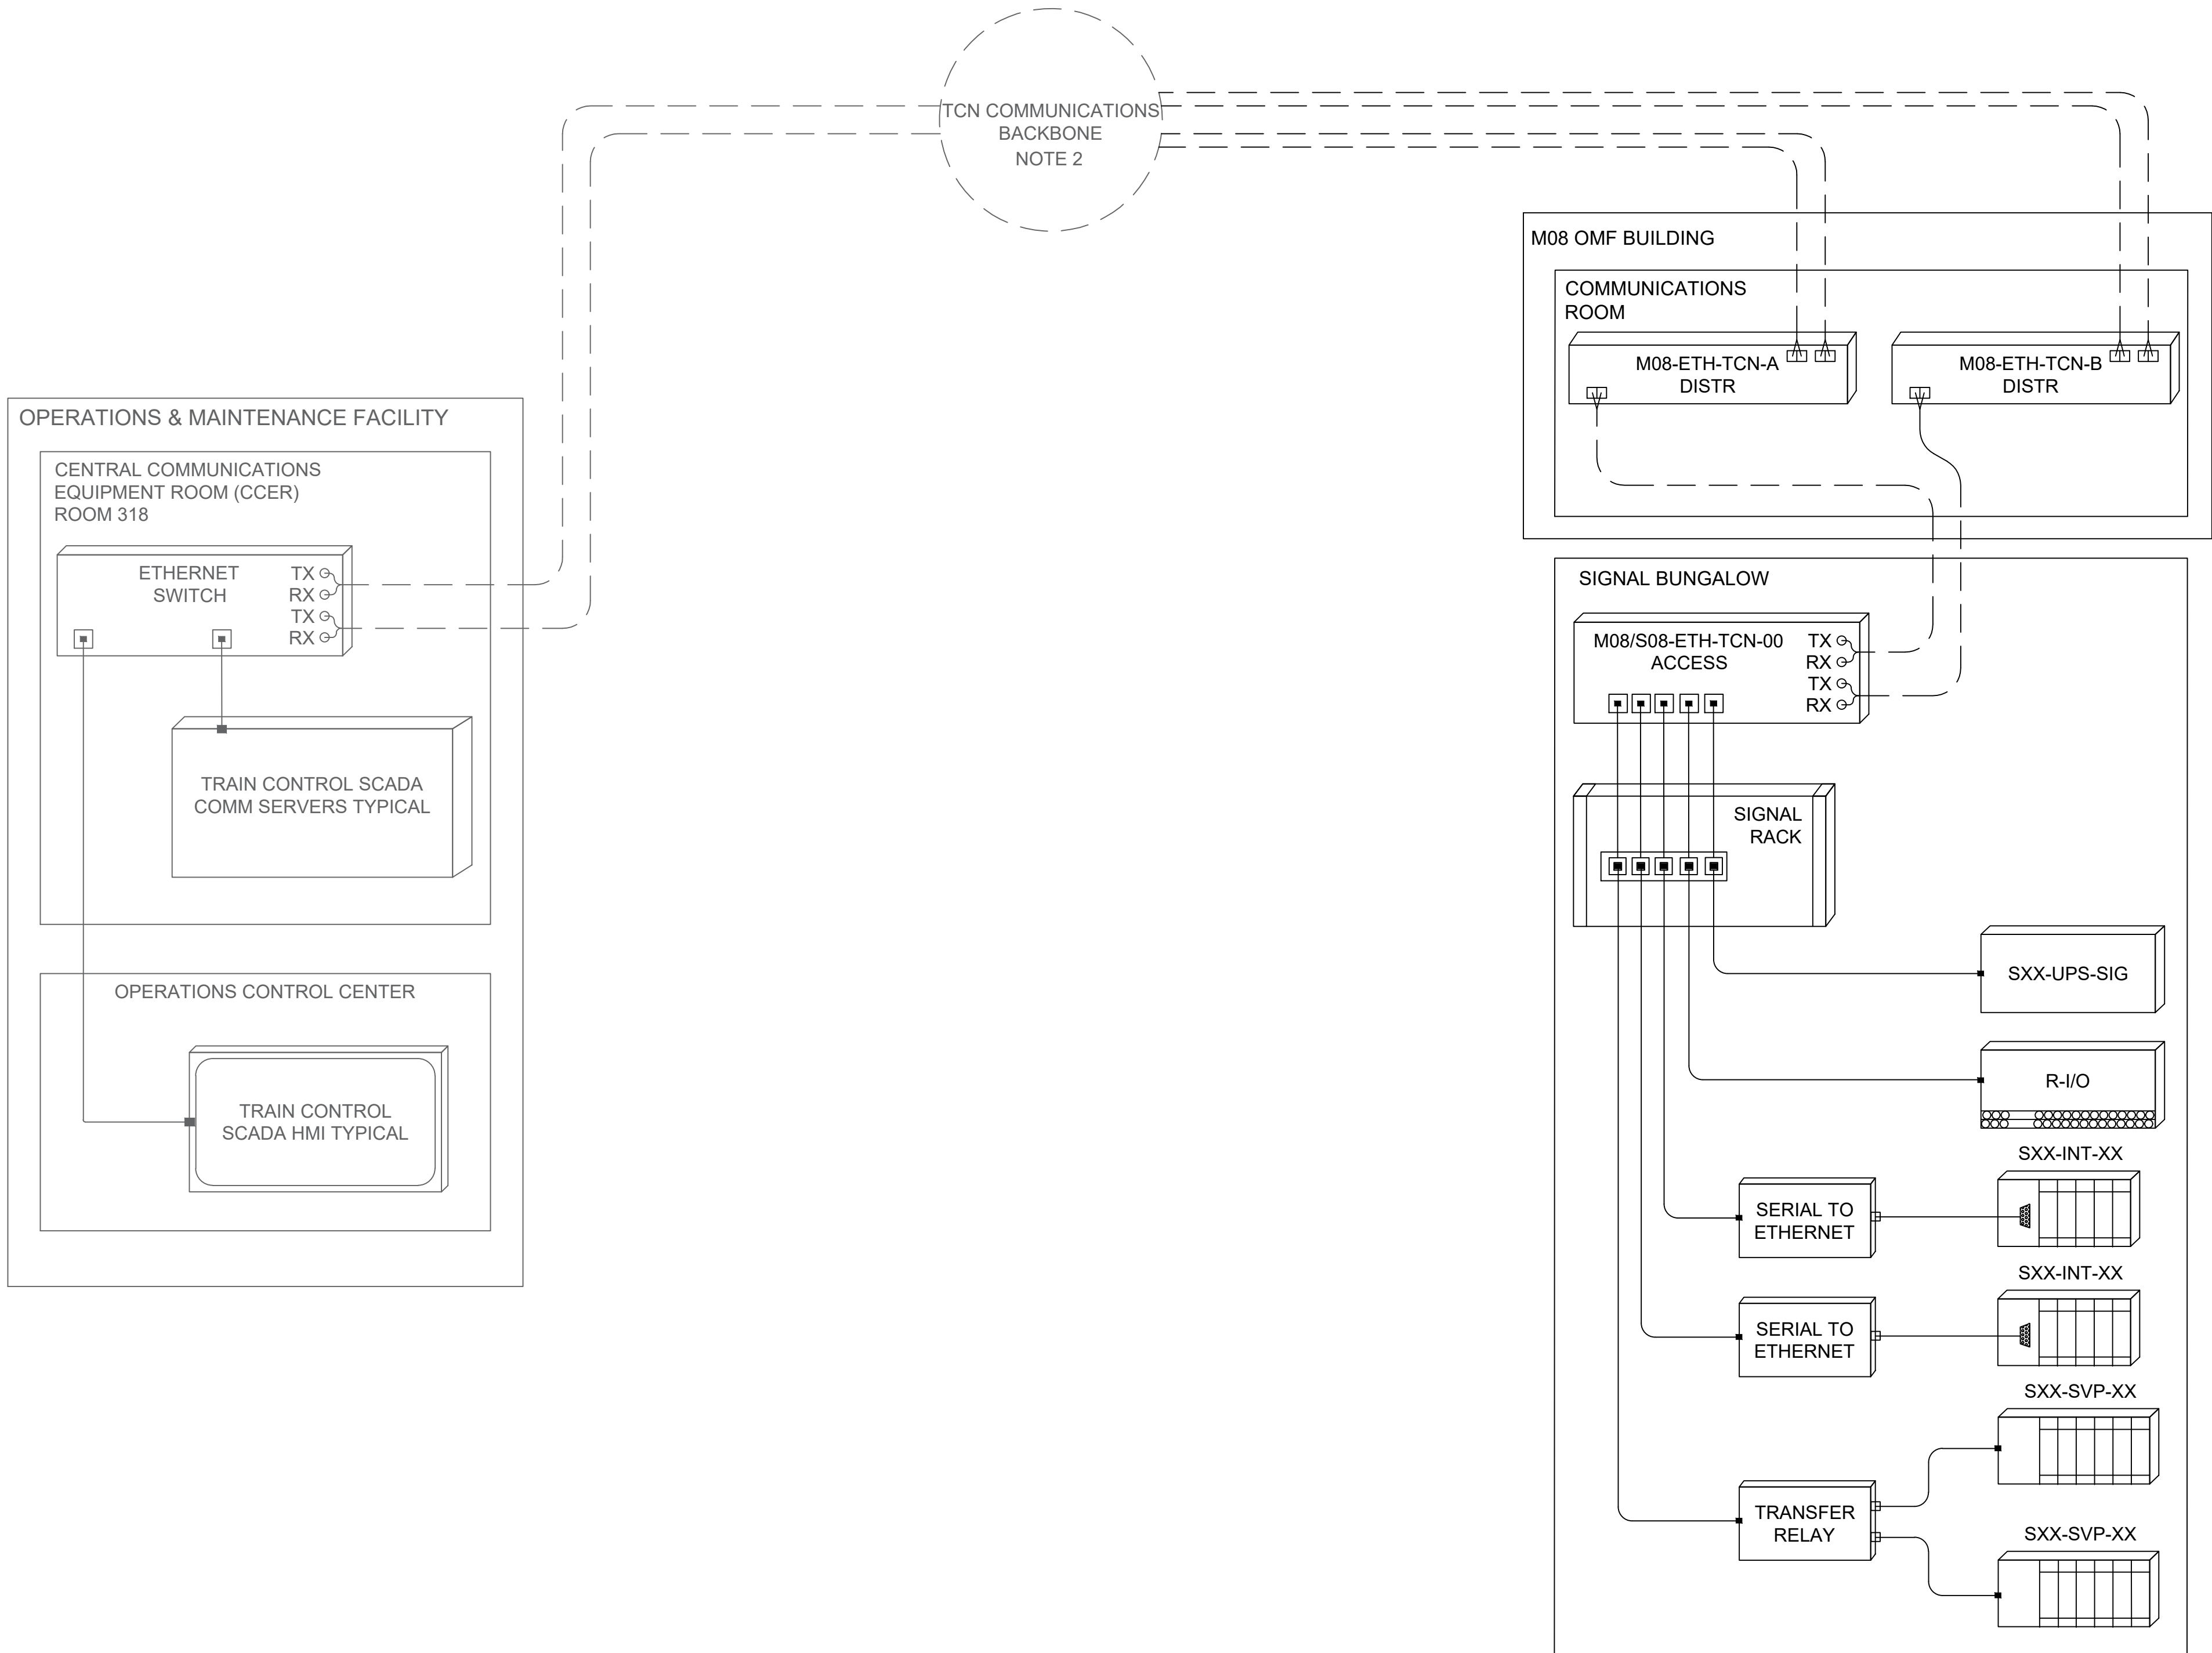SIGNAL TCS SCADA INTERFACE BLOCK DIAGRAM

SCALE: NTS

PRELIMINARY
ENGINEERING





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CONSTRUCTION

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for disclaimers regarding this drawing.

REFERENCE CONCEPT DRAWINGS

No.	DATE	DSN	CHK	APP	REVISION

DESIGNED BY:	Z. ZHANG
DRAWN BY:	Z. ZHANG
CHECKED BY:	P. PERREAULT
APPROVED BY:	J. SCHIMPF

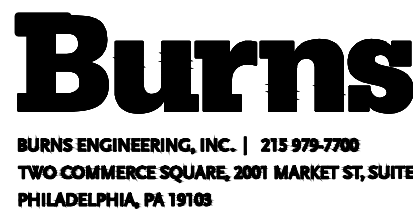AHJ:					PACKAGE #						
						<div>SCALE: NTS</div> <div>FILENAME: OMFS-Y03-JCS013</div> <div>CONTRACT No.: AE0030-17</div> <div>DATE:</div>		<div>SOUND TRANSIT PRELIMINARY ENGINEERING PLANS OPERATIONS & MAINTENANCE FACILITY SOUTH COMMUNICATION SYSTEM TYPICAL SIGNAL TCS SCADA INTERFACE BLOCK DIAGRAM</div>		DRAWING No.: Y03-JCS013	
										FACILITY ID: Y03, S08	
										SHEET No.: REV:	
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SUBMITTED BY: PABLO LOPEZ-HILFIKER		DATE: 2/27/2024	REVIEWED BY:		DATE:						



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Refer to the plan set COVER drawing
for disclaimers regarding this drawing.

REFERENCE CONCEPT DRAWINGS

No.	DATE	DSN	CHK	APP	REVISION

DESIGNED BY:	Z. ZHANG
DRAWN BY:	Z. ZHANG
CHECKED BY:	M. STAHLEY
APPROVED BY:	J. SCHIMPF

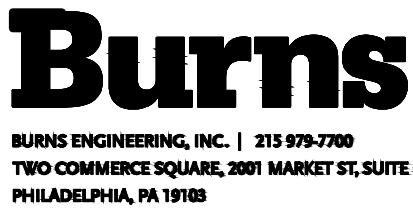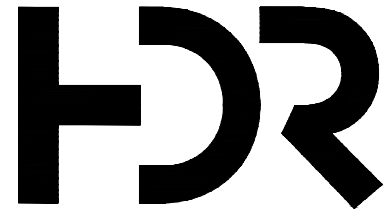

SUBMITTED BY:	DATE:	REVIEWED BY:	DATE:
PABLO LOPEZ-HILFIKER	2/27/2024		


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FILENAME: OMFS-Y03-JCD001
CONTRACT No.: AE-0030-17
DATE:

SOUND TRANSIT
PRELIMINARY ENGINEERING PLANS
OPERATIONS & MAINTENANCE FACILITY SOUTH

COMMUNICATION SYSTEM
TYPICAL COMMUNICATION DEVICES
CONDUIT REQUIREMENTS

DRAWING No.:	Y03-JCD001
FACILITY ID:	Y03, M08, S08
SHEET No.:	REV:
	0

- NOTES:**
- FOR ALL COPPER BASED IP CONNECTIONS THE CONTRACTOR SHALL DESIGN THE CONDUIT RUNS SO NO CABLING PULLS FROM A DESTINATION TO A SOURCE WILL BE MORE THAN 250 FEET.
 - POW-C - INDICATES POWER WILL TERMINATE ON A POWER PANEL ON THE COMMUNICATION UPS PANEL. ALL OTHER DEVICES ARE ON THE STATION POWER. RUN POWER CONDUIT TO THE APPLICABLE SOURCE.

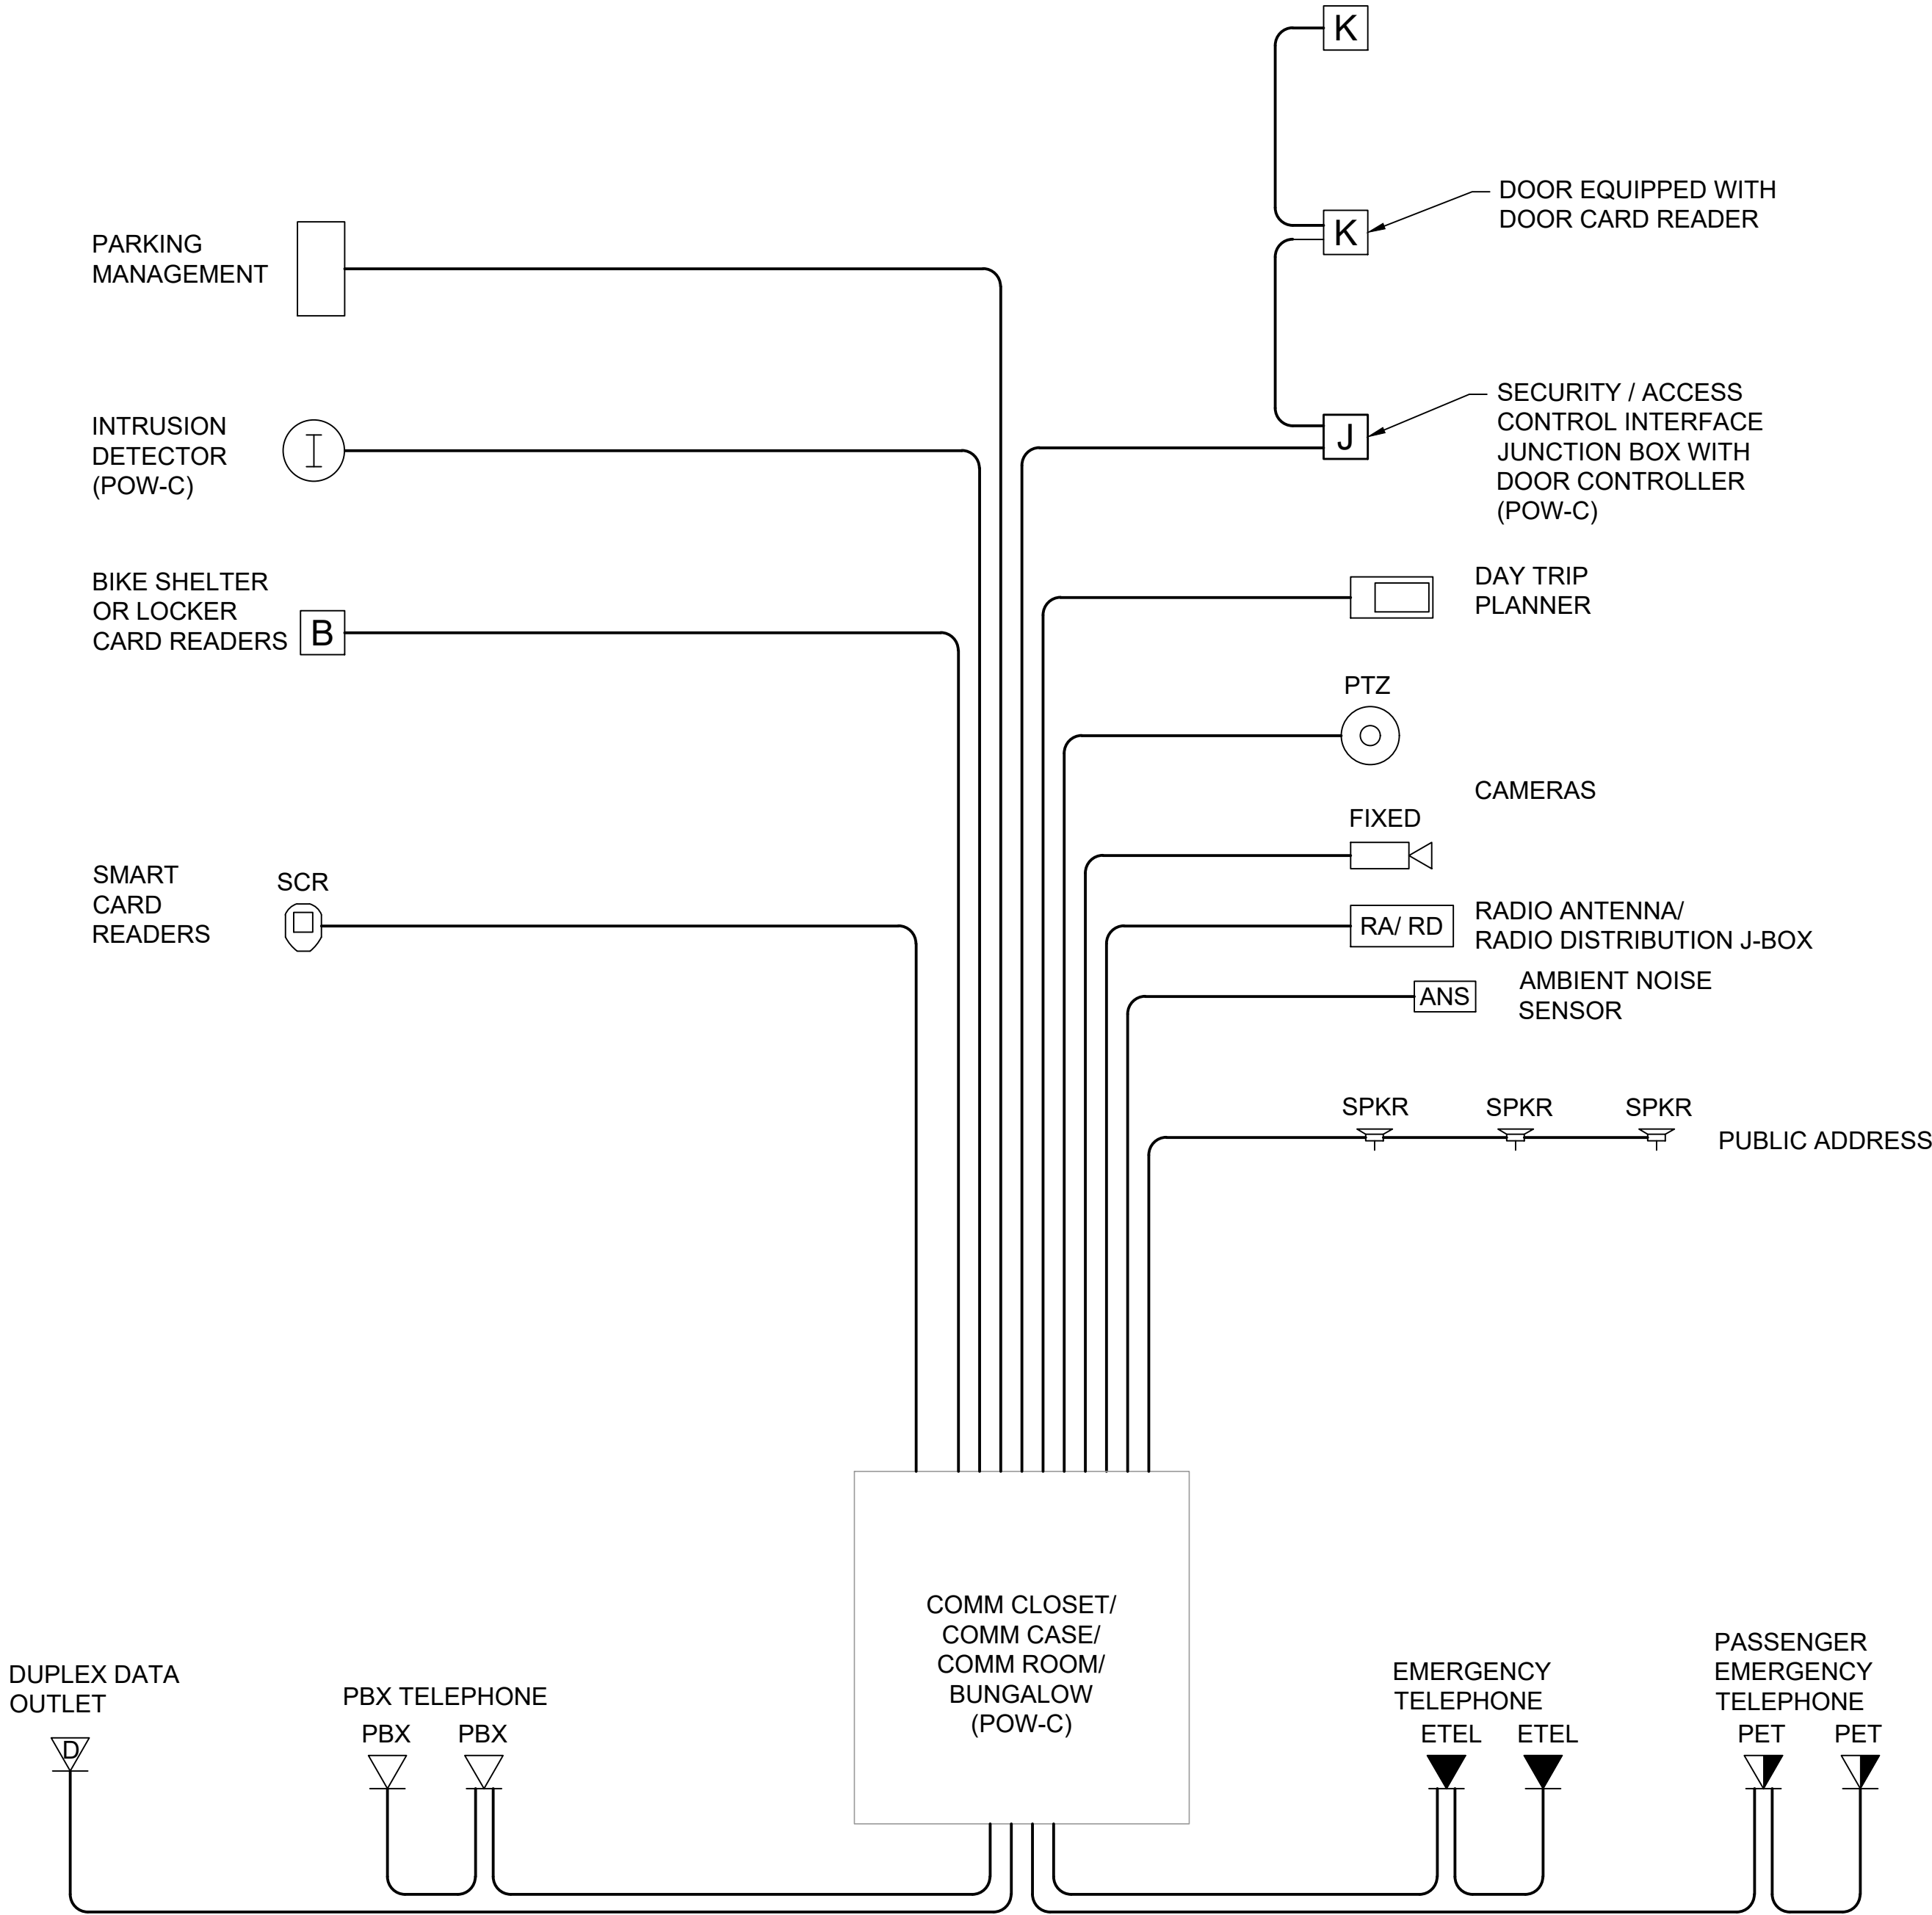



TYPICAL COMMUNICATIONS CONDUIT ROUTING
SCALE: NTS

COMMUNICATION DEVICES CONDUIT REQUIREMENTS			
COMMUNICATION DEVICE		RACEWAY SIZE	
SOURCE	DESTINATION	DATA	POWER
COMMUNICATIONS ROOM/ BUNGALOW OR DISTRIBUTION CABINET (CLOSEST CABINET)	EMERGENCY TELEPHONE	1"	NONE
COMMUNICATIONS ROOM/ BUNGALOW OR DISTRIBUTION CABINET (CLOSEST CABINET)	PASSENGER EMERGENCY TELEPHONE	1"	NONE
COMMUNICATIONS ROOM/ BUNGALOW OR DISTRIBUTION CABINET (CLOSEST CABINET)	PBX TELEPHONE	1"	NONE
COMMUNICATIONS ROOM/ BUNGALOW OR DISTRIBUTION CABINET (CLOSEST CABINET)	RJ-45 DATA OUTLET	1"	NONE
COMMUNICATIONS ROOM/ BUNGALOW OR DISTRIBUTION CABINET (CLOSEST CABINET)	VARIABLE MESSAGE SIGN W/TWO CAMERAS	1"	1.5"
COMMUNICATIONS ROOM/ BUNGALOW OR DISTRIBUTION CABINET (CLOSEST CABINET)	CAMERAS (NOT IN VARIABLE MESSAGE SIGN)	1"	NONE
COMMUNICATIONS ROOM/ BUNGALOW OR DISTRIBUTION CABINET (CLOSEST CABINET)	TVM	1"	1"
COMMUNICATIONS ROOM/ BUNGALOW OR DISTRIBUTION CABINET (CLOSEST CABINET)	BMS INTERFACE TERMINAL CABINET	AS REQD	NONE
COMMUNICATIONS ROOM/ BUNGALOW OR DISTRIBUTION CABINET (CLOSEST CABINET)	PUBLIC ADDRESS SPEAKER CIRCUITS	1"	NONE
COMMUNICATIONS ROOM/ BUNGALOW OR DISTRIBUTION CABINET (CLOSEST CABINET)	AMBIENT NOISE SENSING MICROPHONE	1"	NONE
COMMUNICATIONS ROOM/ BUNGALOW OR DISTRIBUTION CABINET (CLOSEST CABINET)	ACCESS CONTROL CARD DOOR CONTROLLER	1"	NONE
COMMUNICATIONS ROOM/ BUNGALOW OR DISTRIBUTION CABINET (CLOSEST CABINET)	GUIDEWAY INTRUSION DETECTION MONITOR	1"	NONE
COMMUNICATIONS ROOM/ BUNGALOW OR DISTRIBUTION CABINET (CLOSEST CABINET)	SECURITY GATE CONTROLS	1"	NONE
COMMUNICATIONS ROOM/ BUNGALOW OR DISTRIBUTION CABINET (CLOSEST CABINET)	TRIP PLANNERS	1"	1"
COMMUNICATIONS ROOM/ BUNGALOW OR DISTRIBUTION CABINET (CLOSEST CABINET)	BICYCLE SHELTER CARD READER	1"	1"
COMMUNICATIONS ROOM/ BUNGALOW OR DISTRIBUTION CABINET (CLOSEST CABINET)	BICYCLE LOCKER CARD READER	1"	1"
COMMUNICATIONS ROOM/ BUNGALOW OR DISTRIBUTION CABINET (CLOSEST CABINET)	COMMUNICATION DISTRIBUTION CABINET	3"	3"
COMMUNICATIONS ROOM OR BUNGALOW			
COMMUNICATIONS ROOM/ BUNGALOW OR DISTRIBUTION CABINET (CLOSEST CABINET)	PARKING MANAGEMENT	1"	1"
COMMUNICATIONS ROOM/ BUNGALOW OR DISTRIBUTION CABINET (CLOSEST CABINET)	RADIO ANTENNA/ DISTRIBUTION J-BOX	4"	
COMMUNICATIONS ROOM/ BUNGALOW OR DISTRIBUTION CABINET (CLOSEST CABINET)	GUIDEWAY INTRUSION DETECTION MONITOR	1"	1"
COMMUNICATIONS ROOM/ BUNGALOW OR DISTRIBUTION CABINET (CLOSEST CABINET)	SMART CARD READER	3/4"	1"

TYPICAL DUCTBANK REQUIREMENTS		
SOURCE	DESTINATION	CONDUITS
OMF	MAIN LINE INTERFACE POINT	6 X 4"
OMF	MAIN LINE INTERFACE POINT (ALTERNATIVE ROUTE)	6 X 4"
OMF	TPSS	2 X 4"
OMF	SIGNAL HOUSE	2 X 4"
OMF	COMMUNICATION DISTRIBUTION CASE	2 X 3"
OMF	GUARD HOUSE	2 X 4"
OMF	UTILITY VAULT	2 X 4"
OMF	MOW BUILDING	4 X 4"
OMF	LSWS	2 X 4"
OMF	LRV WASH BUILDING	2 X 4"
OMF	UTILITY VAULT (SERVICE PROVIDER)	2 X 4"
MOW	COMMUNICATION DISTRIBUTION CASE	2 X 4"
TPSS	TPSS	2 X 4"
TPSS	MAINLINE INTERFACE POINT	2 X 4"
SIGNAL HOUSE	SIGNAL HOUSE	2 X 4"
SIGNAL HOUSE	MAINLINE INTERFACE POINT	2 X 4"



PRELIMINARY
ENGINEERING

NOT FOR
CONSTRUCTION

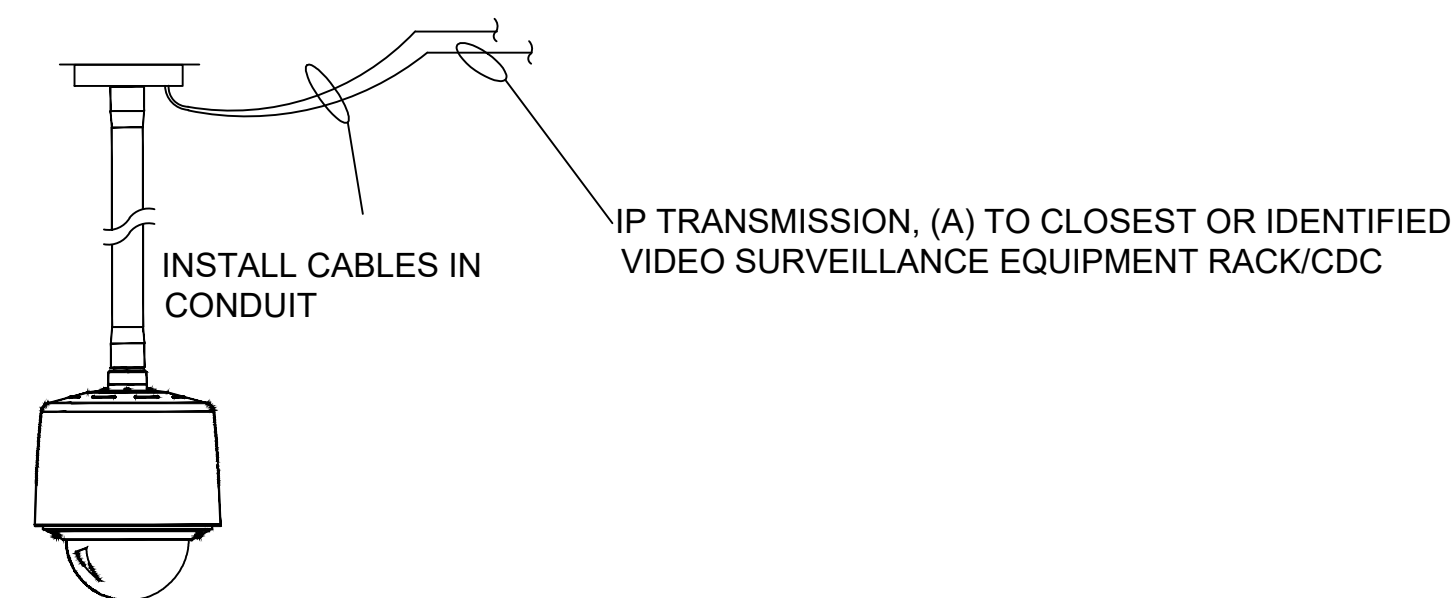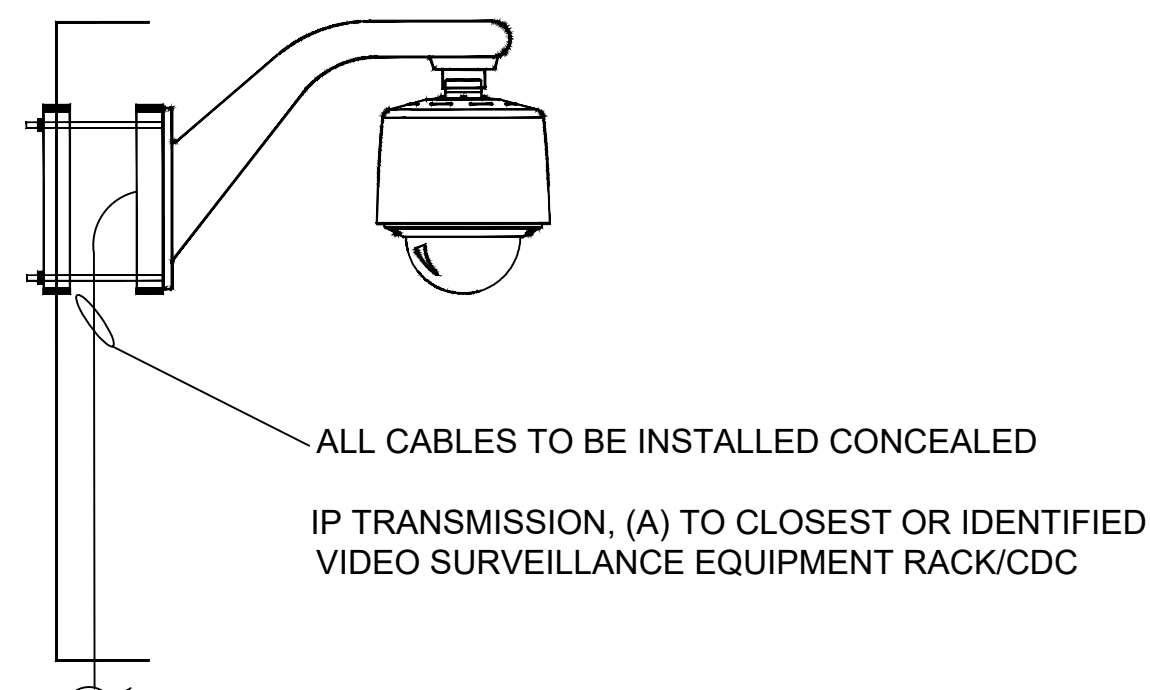



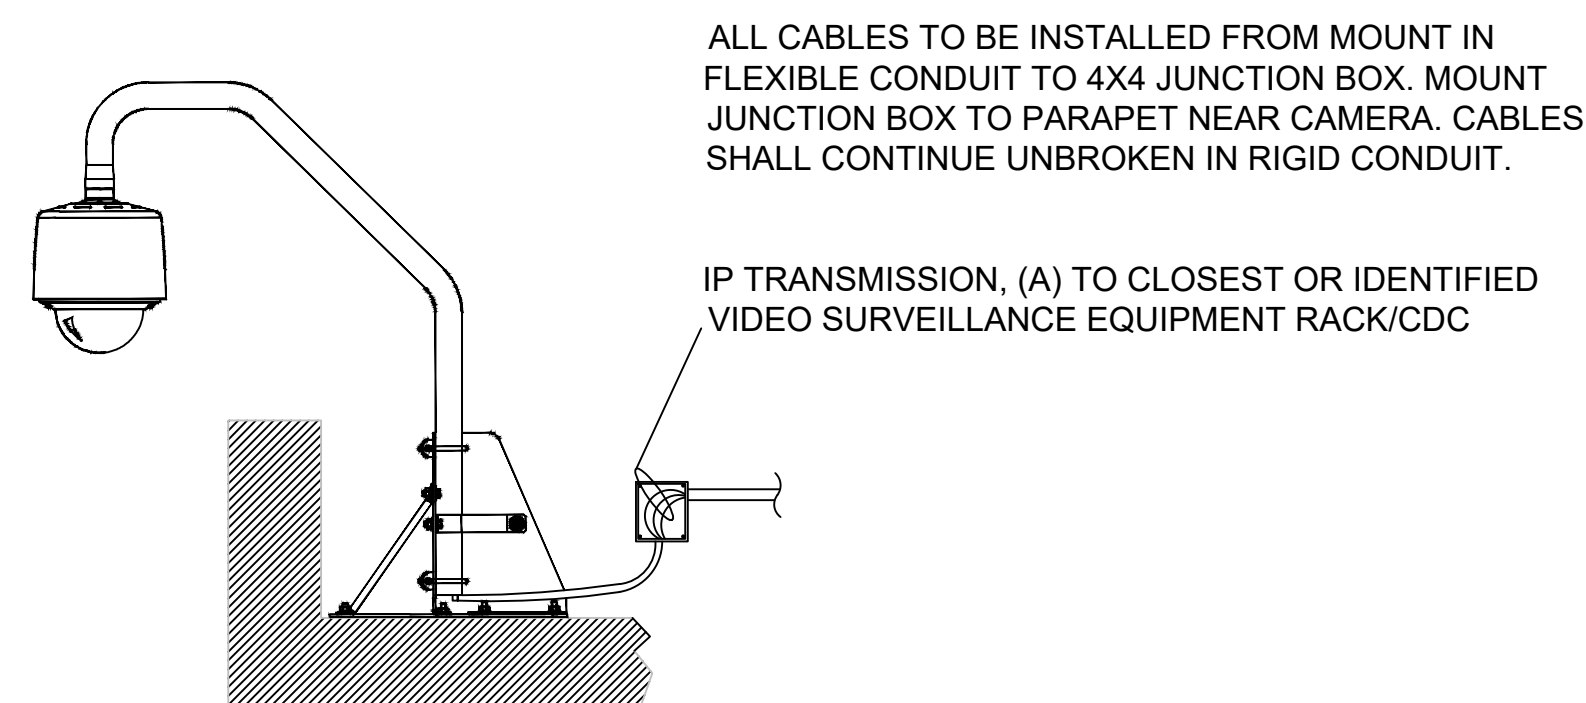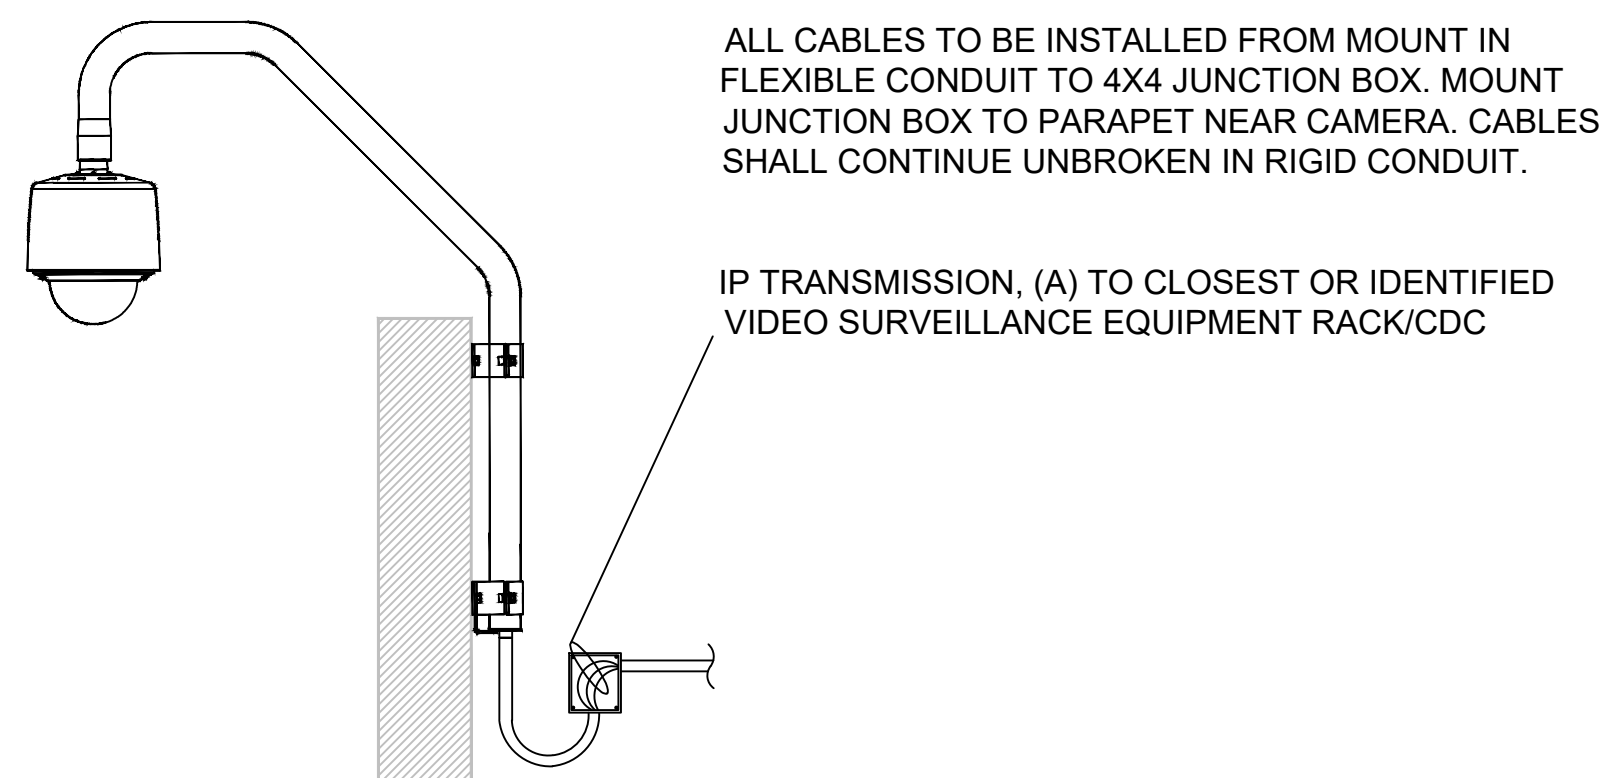

NOTES:

1. FOR IP VIDEO TRANSMISSION FROM DESIGNATED CAMERAS USE "WET LOCATIONS" RATED CAT6 SHIELDED CABLE SUITABLE FOR ETHERNET APPLICATIONS. SUCH AS BELDEN 1583A OR 7883A


PRELIMINARY
ENGINEERING

NOT FOR
CONSTRUCTION


Refer to the plan set COVER drawing
for disclaimers regarding this drawing.

Refer to the plan set COVER drawing for disclaimers regarding this drawing.										AHJ:										PACKAGE #																																							
REFERENCE CONCEPT DRAWINGS										DESIGNED BY: Z. ZHANG										SCALE: NTS FILENAME: OMFS-Y03-JCD002 CONTRACT No.: AE0030-17										SOUND TRANSIT PRELIMINARY ENGINEERING PLANS OPERATIONS & MAINTENANCE FACILITY SOUTH COMMUNICATION SYSTEM YARD CCTV SYSTEM DETAILS										DRAWING No.: Y03-JCD002																			
										DRAWN BY: Z. ZHANG																														FACILITY ID: Y03																			
										CHECKED BY: M. STAHLEY																														SHEET No.: REV:																			
										APPROVED BY: J. SCHIMPF																														0																			
										No. DATE DSN CHK APP REVISION																																																	
																																																											
										SUBMITTED BY: PABLO LOPEZ-HILFIFER										DATE: 2/27/2024										REVIEWED BY:										DATE:																			


02/22/24 | 8:47 PM | ZZHANG
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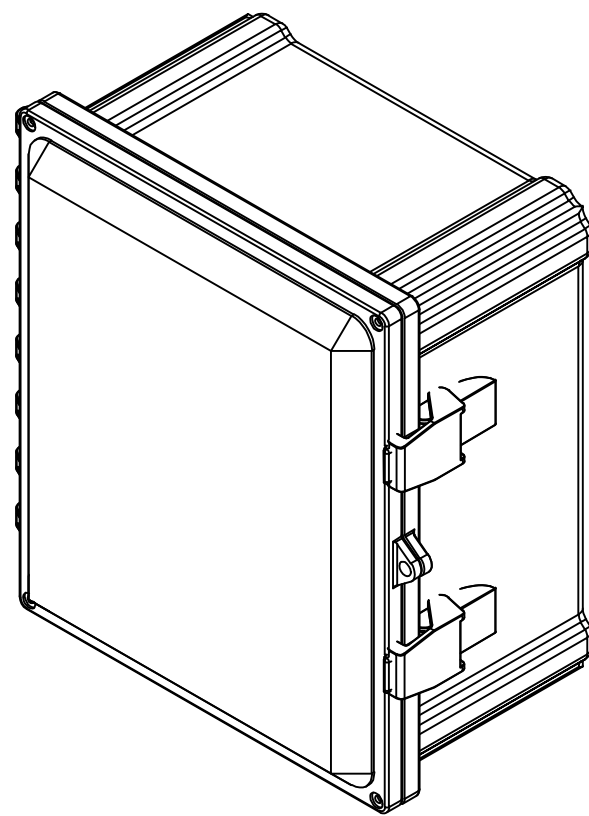
FRONT VIEW

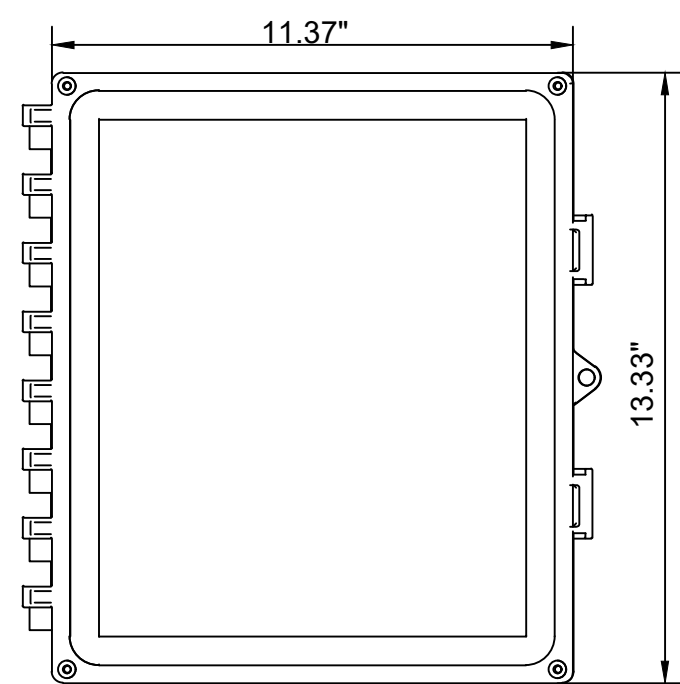


SIDE VIEW

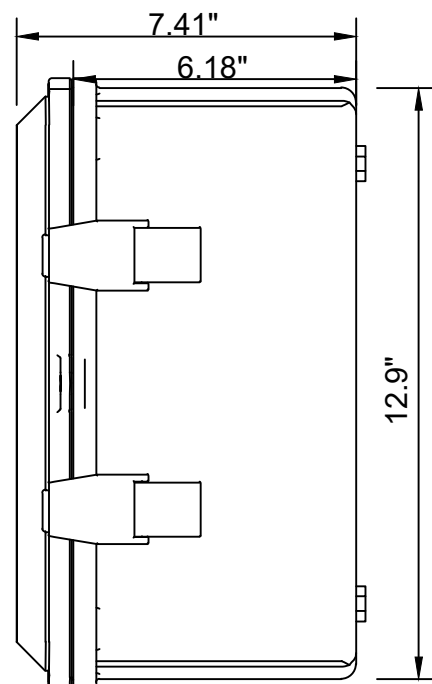

TOP VIEW

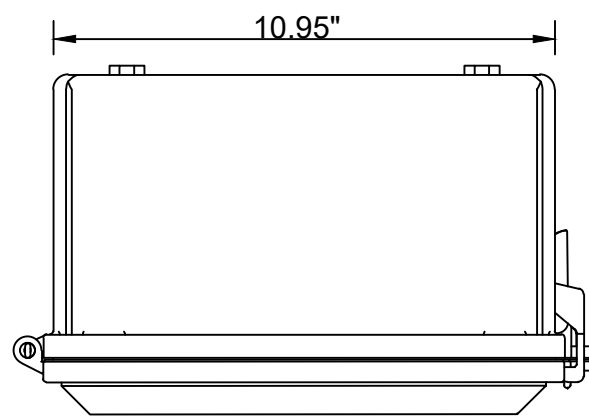


ISOMETRIC VIEW

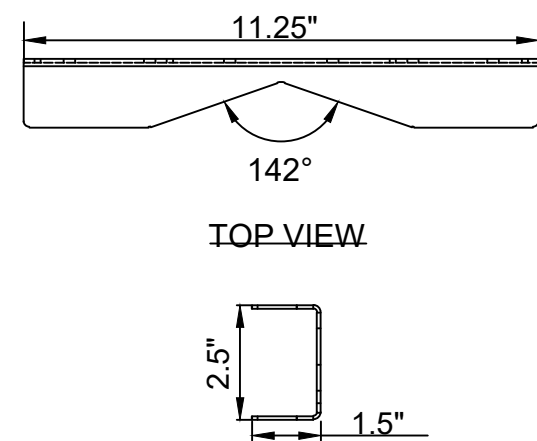

TOP VIEW

END VIEW

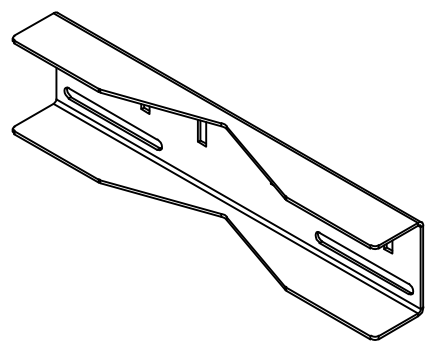

ISOMETRIC VIEW


NOTES:
1. DIMENSIONS ARE EXTERNAL DIMENSIONS. USABLE INTERNAL DIMENSIONS ARE 12" X 10" X 6".

POLE/WALL MOUNTED WAP ENCLOSURE

SCALE: 1/4" = 1"


WAP ENCLOSURE POLE MOUNT ADAPTER

SCALE:1/4" = 1"

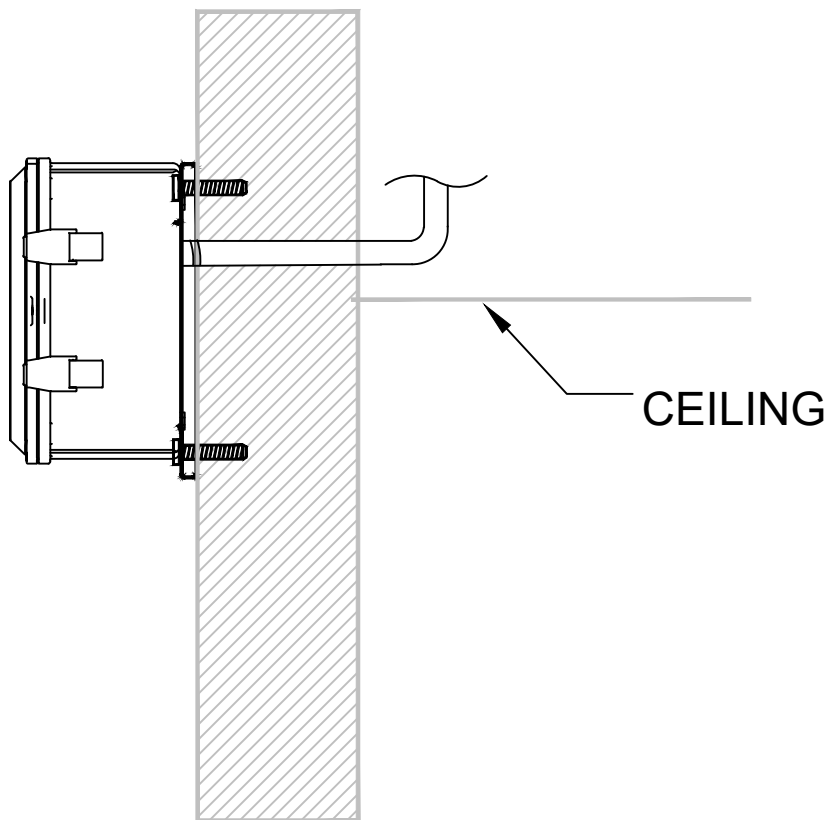

WAP ENCLOSURE - WALL MOUNT DETAIL

SCALE: NTS

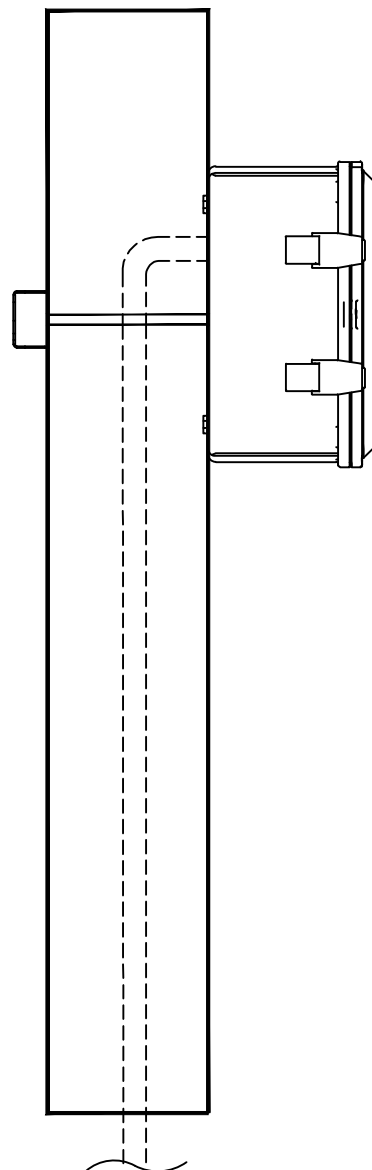

WALP ENCLOSURE - POLE MOUNT DETAIL

SCALE: NTS

PRELIMINARY
ENGINEERING

NOT FOR
CONSTRUCTION

Refer to the plan set COVER drawing
for disclaimers regarding this drawing.

REFERENCE CONCEPT DRAWINGS

No.	DATE	DSN	CHK	APP	REVISION

DESIGNED BY:	Z. ZHANG
DRAWN BY:	Z. ZHANG
CHECKED BY:	M. STAHLEY
APPROVED BY:	J. SCHIMPF

AHJ:					PACKAGE #								
								SCALE: NTS FILENAME: OMFS-Y03-JCD003 CONTRACT No.: AE0030-17 DATE:		SOUND TRANSIT PRELIMINARY ENGINEERING PLANS OPERATIONS & MAINTENANCE FACILITY SOUTH COMMUNICATION SYSTEM WIRELESS ACCESS POINT DETAILS		DRAWING No.: Y03-JCD003	
												FACILITY ID: Y03	
												SHEET No.: 0	
												REV: 0	
SUBMITTED BY: PABLO LOPEZ-HILFIKER		DATE: 2/27/2024		REVIEWED BY:		DATE:							


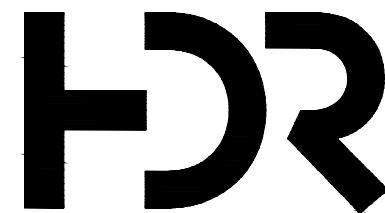

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Refer to the plan set COVER drawing
for disclaimers regarding this drawing.


REFERENCE CONCEPT DRAWINGS

No.	DATE	DSN	CHK	APP	REVISION

DESIGNED BY:	Z. ZHANG
DRAWN BY:	Z. ZHANG
CHECKED BY:	P. PERREAULT
APPROVED BY:	J. SCHIMPF

AHJ:					PACKAGE #					
	 Burns <small>BURNS ENGINEERING, INC. 215 979-7700 TWO COMMERCE SQUARE, 2001 MARKET ST, SUITE 600 PHILADELPHIA, PA 19103</small>			<div>LINE IS "A" FULL SCALE</div>		SCALE:	<div>SOUND TRANSIT PRELIMINARY ENGINEERING PLANS OPERATIONS & MAINTENANCE FACILITY SOUTH COMMUNICATION SYSTEM HIGH LEVEL RADIO SYSTEM BLOCK DIAGRAM</div>			DRAWING No.:
						NTS				Y03-JRS001
						FILENAME:				FACILITY ID:
						OMFS-Y03-JRS001				Y03, M08, S08
SUBMITTED BY:			DATE:	REVIEWED BY:	DATE:	SHEET No.:			REV:	
PABLO LOPEZ-HILFIKER			2/27/2024						0	

- NOTES:
- DAS - DISTRIBUTED ANTENNA SYSTEM
 - BDA - BI-DIRECTIONAL AMPLIFIER
 - KVCV - KING COUNTY VALLEY COMMUNICATIONS
 - NPSBN - NATIONWIDE PUBLIC SAFETY BROADBAND NETWORK

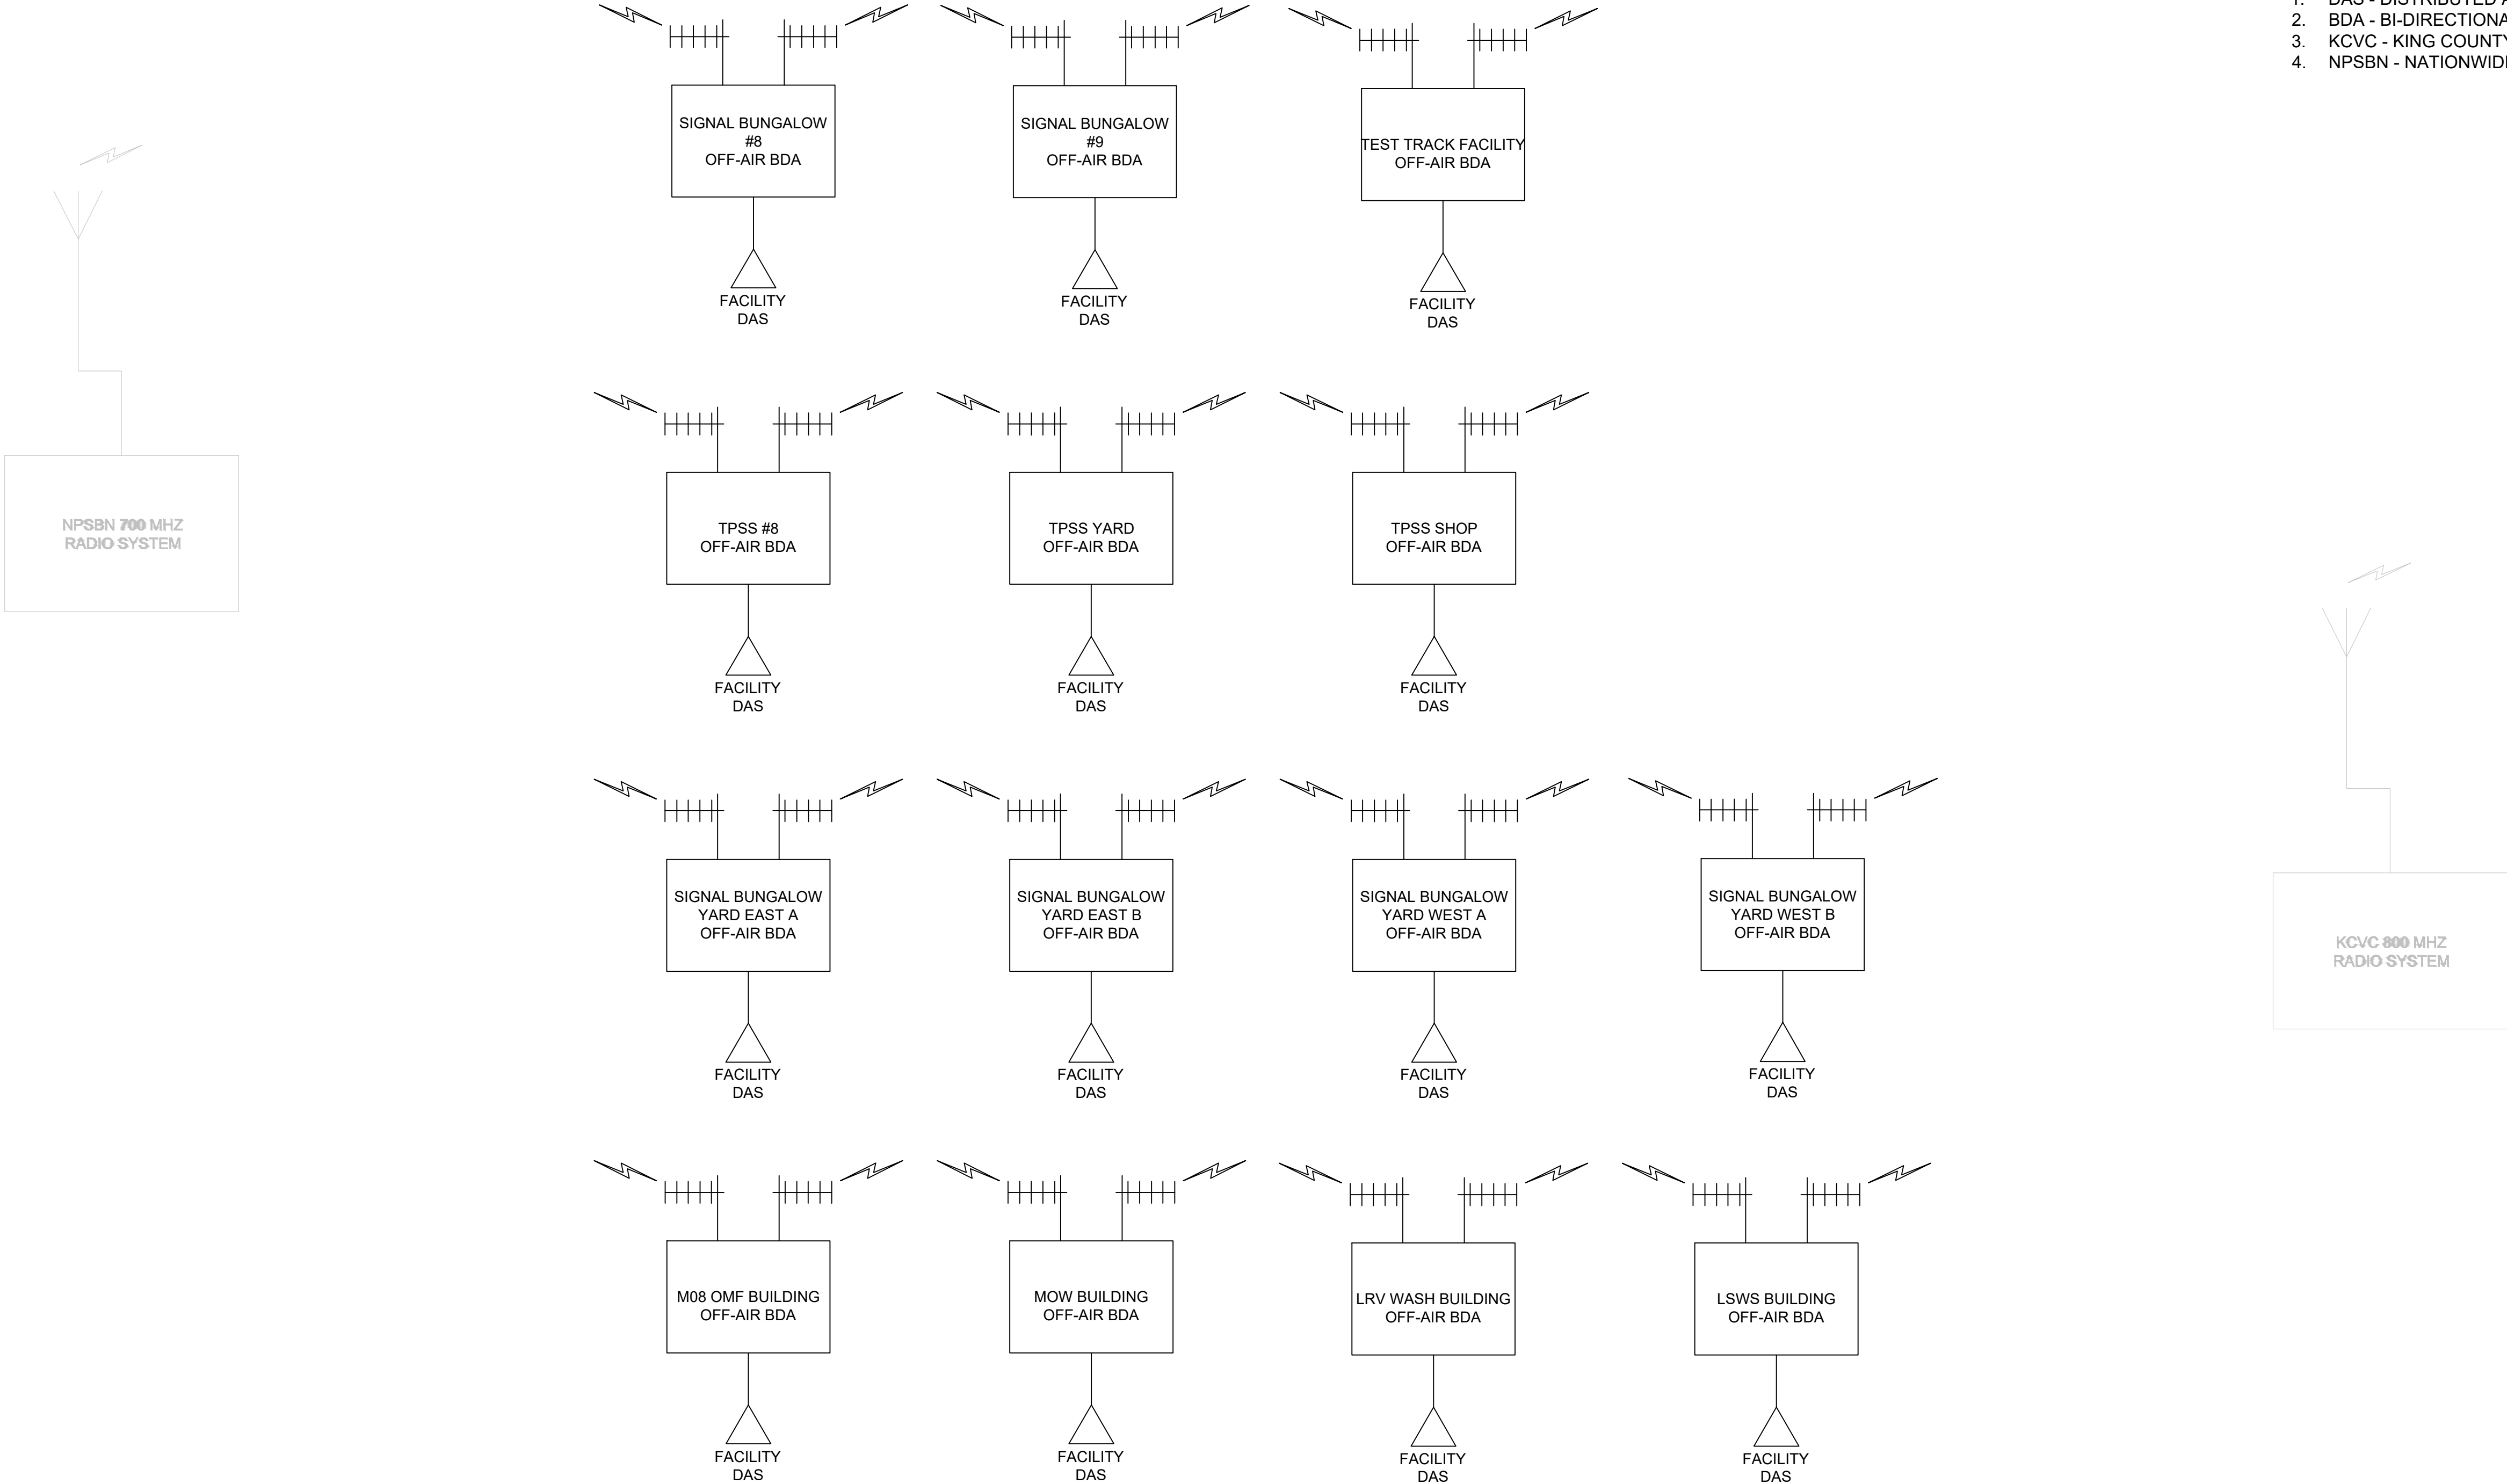

PRELIMINARY
ENGINEERING

NOT FOR
CONSTRUCTION


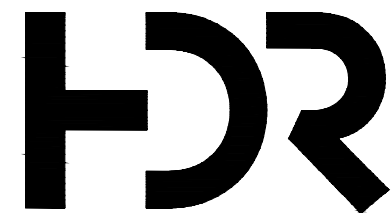


02/22/24 | 8:56 PM | ZZHANG
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Refer to the plan set COVER drawing
for disclaimers regarding this drawing.

REFERENCE CONCEPT DRAWINGS

No.	DATE	DSN	CHK	APP	REVISION

DESIGNED BY:	Z. ZHANG
DRAWN BY:	Z. ZHANG
CHECKED BY:	M. STAHLEY
APPROVED BY:	J. SCHIMPF

AHJ:					PACKAGE #							
							<div>SCALE: NTS</div> <div>FILENAME: OMFS-Y03-JBS001</div> <div>CONTRACT No.: AE0030-17</div> <div>DATE:</div>		<div>SOUND TRANSIT PRELIMINARY ENGINEERING PLANS OPERATIONS & MAINTENANCE FACILITY SOUTH</div> <div>COMMUNICATION SYSTEM BUILDING MANAGEMENT SYSTEM INTERFACE DIAGRAM</div>		DRAWING No.: Y03-JBS001	
											FACILITY ID: Y03	
											SHEET No.:	REV:
											0	
SUBMITTED BY: PABLO LOPEZ-HILFIKER		DATE: 2/27/2024		REVIEWED BY:		DATE:						

NOTES:

1. FINAL DESIGN SHALL COORDINATE WITH COMMUNICATION FOR PATCH PANEL SPACE FOR ALL BMS CONNECTIONS TO THE TELECOMMUNICATION NETWORK.
2. PROVIDE FATC WITH CONVENTIONAL ZONE INPUTS AS FOLLOWS:
 - a. X1 PER FLOW AND PRESSURE ALARM SWITCH,
 - b. X1 PER RISER SUPERVISORY VALVE,
 - c. X1 PER EACH UNIQUE INPUT NOT COVERED ABOVE.
3. ELECTRICAL METERING IN THIS ROOM TO HAVE CONNECTION TO BMS SYSTEM.
4. FINAL DESIGN TO PROVIDE FOR BMS WORKSTATION IN THIS AREA.
5. PROVIDE FULL WALL WIDTH (EAST WALL) X FLOOR-TO-CEILING WALL SPACE FOR FIRE ALARM/EVAC SYSTEM. PROVIDE EST4 PER SOUND TRANSIT STANDARDS. PROVIDE SMOKE DETECTOR AS REQUIRED BY NFPA 72.
6. PROVIDE 8' W X FLOOR-TO-CEILING WALL SPACE FOR ACCESS CONTROL PANELS AND POWER SUPPLIES. PROVIDE LENEL ACS PER SOUND TRANSIT STANDARDS.

GENERAL NOTES:


1. FINAL DESIGN SHALL PROVIDE FOR CONDUIT PATHWAY (1" MIN.) BETWEEN MECHANICAL BMS CONNECTIONS AND COMMUNICATION ROOM. ROUTING TO BE UNDERGROUND UNLESS NOT POSSIBLE BASED ON BUILDING CONSTRUCTION RESTRAINTS. ALL VISIBLE PATHWAYS MUST BE APPROVED BY ST. PATHWAYS CAN BE COMBINED FOR EFFICIENCY.
2. FINAL DESIGN TO PROVIDE FULL ADDRESSABLE FIRE ALARM SYSTEM.
3. FINAL DESIGN TO PROVIDE ACCESS CONTROL AT ENTRY DOORS, GATES, DESIGNATED INTERIOR DOORS.
4. FINAL DESIGN TO PROVIDE SECURITY CAMERA AT ENTRY POINTS, GATES, DESIGNATED INTERIOR AREAS.

FIRE ALARM/EVAC SYSTEM (FAEV):

1. PROVIDE MANUAL PULL STATION AT EACH EXIT.
2. PROVIDE SMOKE AND HEAT DETECTOR FOR EACH ELECTRICAL ROOM. SMOKE AND HEAT MUST BE ABLE TO BE UNIQUELY IDENTIFIED WHEN IN ALARM.
3. PROVIDE MONITOR MODULES FOR FIRE SUPPRESSION CONTROL PANELS (FSCP) FOR CLEAN AGENT IN EACH IT/MDF/IDF ROOM. MONITOR FOR ALARM, SUPERVISORY & TROUBLE FOR EACH FSCP.
4. COORDINATE WITH FIRE SUPPRESSION CONTRACTOR FOR PRE-ACTION REQUIREMENTS BY AHJ IN THE IT/MDF/IDF ROOMS.
5. FINAL DESIGN TO HAVE FACP PANEL LOCATION COORDINATED WITH CITY, STATE AND LOCAL AHJ AND SOUND TRANSIT.

6. PROVIDE EVAC (SPEAKER/STROBES & STROBES) THROUGHOUT ALL OCCUPIABLE AREAS OF BUILDING INCLUDING MAINTENANCE TRENCHES & MEZZANINES. SPEAKERS SHALL BE SET TO OBTAIN 15 dBA OVER AVERAGE AMBIENT CONDITIONS AND STROBES WILL PROVIDE COVERAGE AS PRESCRIBED IN CHAPTER 18 OF NFPA 72 (VERIFY VERSION W/AHJ).
7. PROVIDE RELAY INTERFACE TO OVERHEAD FANS TO SHUTDOWN FANS ON WATER FLOW.
8. PROVIDE LCD TYPE ANNUNCIATOR IN EACH BUILDING VESTIBULE, MDF ROOM & FIRE SPRINKLER RISER ROOM.
9. PROVIDE LCD TYPE ANNUNCIATOR AND EVAC REMOTE MICROPHONE AT PRIMARY FIRE DEPT./FIRST RESPONDER ENTRY POINT.

KEY PLAN - M08

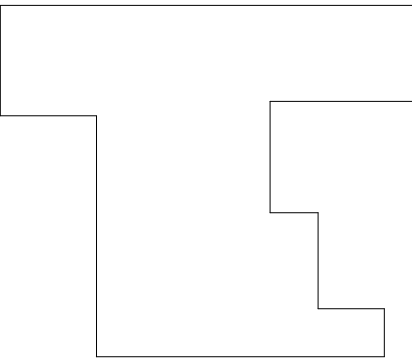

ACCESS CONTROL SYSTEM (ACS):


1. PROVIDE ACS CARD READER AT EACH PERIMETER PERSONNEL DOOR (SINGLE AND/OR DOUBLE DOORS). COORDINATE WITH DOOR HARDWARE SUPPLIER TO HAVE DOOR FUNCTION AS A "CARD IN/FREE EXIT" (CI/FE) DOOR.
2. BASIC REQUIREMENTS OF ACS DOOR ARE TO HAVE:
 - a. CARD READER PER SOUND TRANSIT STANDARD
 - b. DOOR CONTACT
 - c. REQUEST-TO-EXIT (INTEGRAL TO DOOR HARDWARE UNLESS ELECTRIC STRIKE IS REQUIRED, THEN USE SENSOR).
 - d. ELECTRIFIED LOCKING HARDWARE (BY DIV. 8)

VIDEO MANAGEMENT & CAMERAS (VMS):

1. PROVIDE CAMERAS (PER SOUND TRANSIT STANDARDS & COORDINATE MOUNTING HEIGHT W/SOUND TRANSIT) AS FOLLOWS:
2. EXTERIOR:
 - a. - PTZ AT EACH CORNER ON BUILDING.
 - b. - FIXED CAMERAS FOR TRAIN INGRESS AND EGRESS APRON AREAS WITH COVERAGE ADEQUATE TO PROVIDE "RECOGNITION" OF PERSONNEL WALKING THROUGH THESE AREAS.
 - c. - FIXED CAMERAS FOR BUILDING EXTERIOR; GENERAL OBSERVATION FOR PEDESTRIANS AND VEHICLES IMMEDIATELY ADJACENT IN SIDEWALKS AND ROADWAY. COORDINATE WITH SOUND TRANSIT TO PROGRAM "ALARM ALGORITHMS" TO ACTIVATE PTZ "CALL-UP".
 - d. - FIXED CAMERAS AT BUILDING ENTRY POINTS (ACS DOORS) WITH COVERAGE ADEQUATE TO PROVIDE "RECOGNITION" OF PERSONNEL ENTERING DOORS.
3. INTERIOR:
 - a. - FIXED CAMERAS AT BUILDING ENTRY POINTS (ACS DOORS) WITH COVERAGE ADEQUATE TO PROVIDE IDENTIFICATION" OF PERSONNEL ENTERING DOORS.
 - b. - FIXED CAMERAS AT CRITICAL INFRASTRUCTURE ROOMS SUCH AS ELECTRICAL, IT, MDF & IDF ROOMS. (ACS DOORS) WITH COVERAGE ADEQUATE TO PROVIDE IDENTIFICATION" OF PERSONNEL ENTERING DOORS.


OMF 1ST FINISH FLOOR

SCALE: 1" = 30'-0"

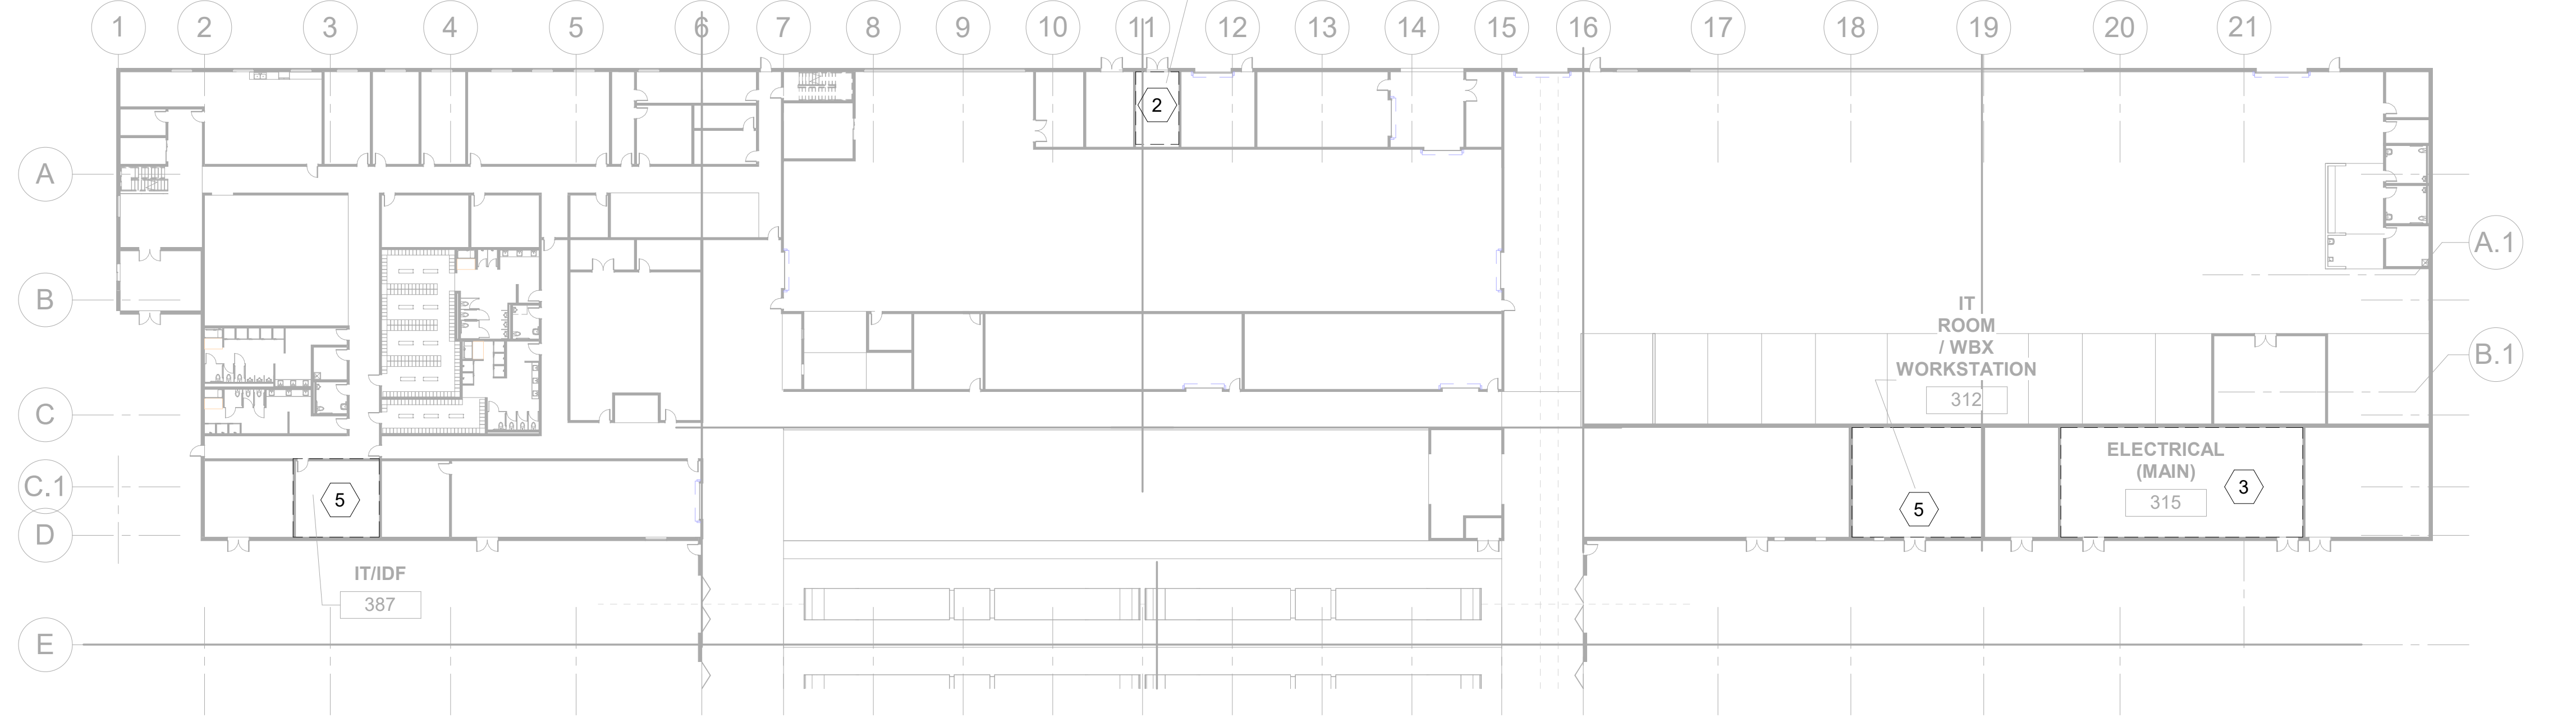

OMF 2ND FINISH FLOOR

SCALE: 1" = 30'-0"

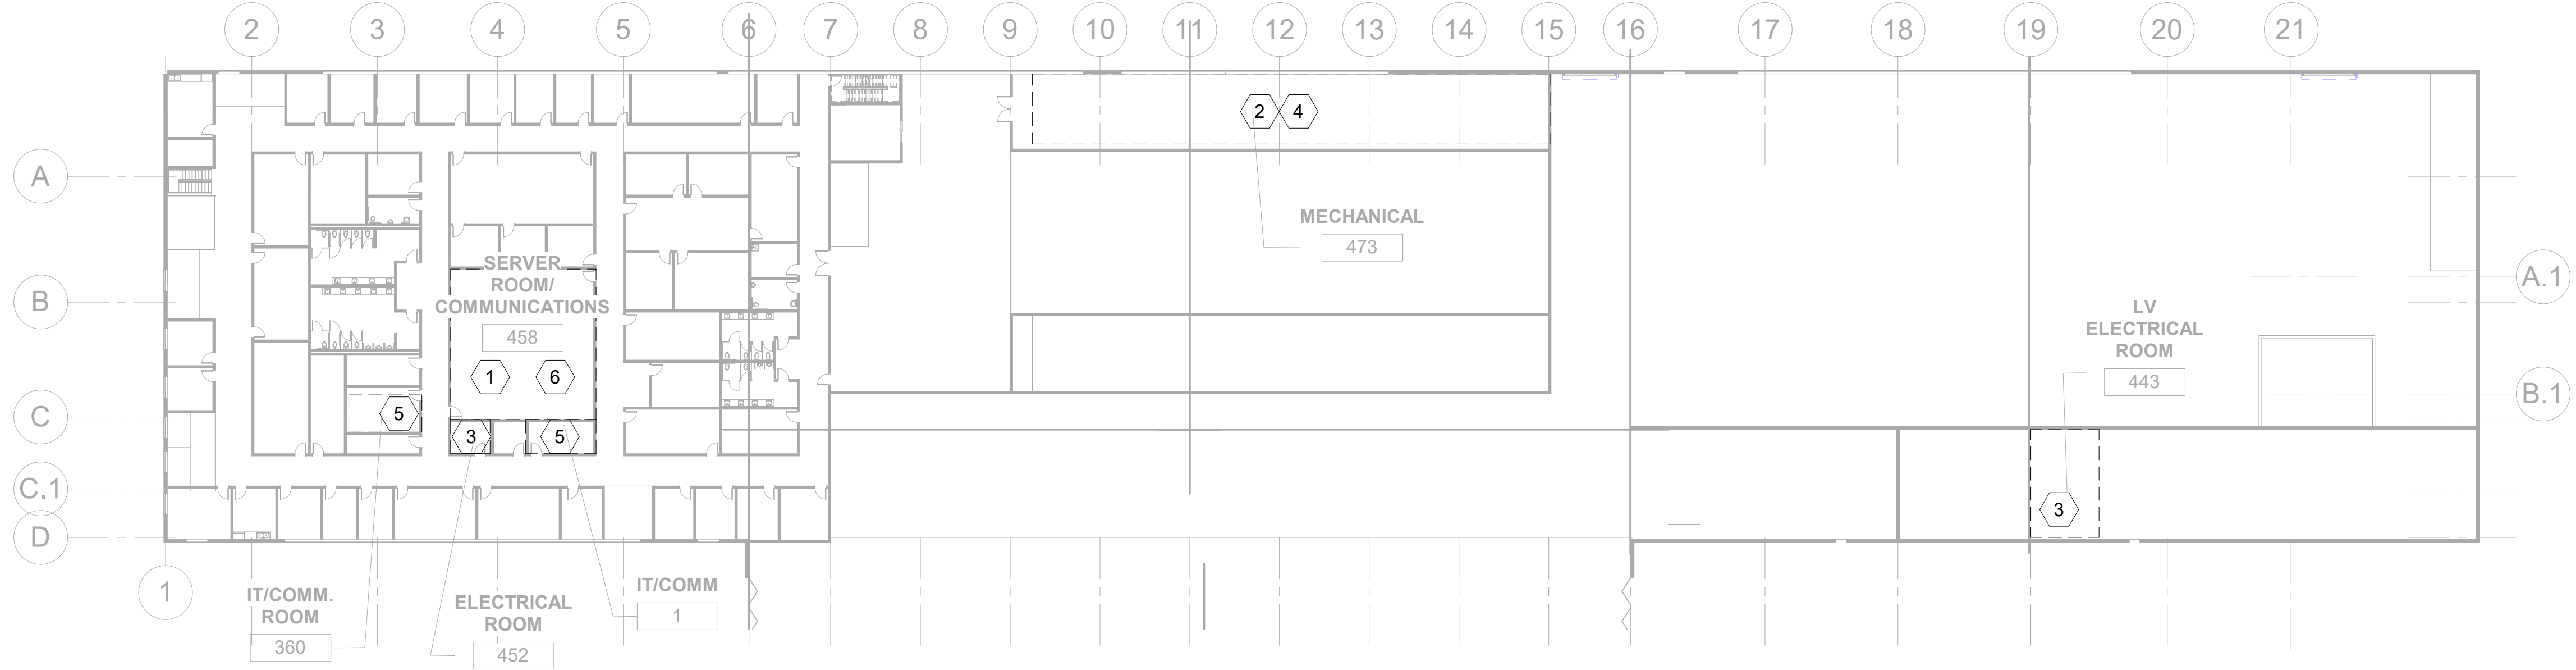


Refer to the plan set COVER drawing for disclaimers regarding this drawing.

REFERENCE CONCEPT DRAWINGS

No.	DATE	DSN	CHK	APP	REVISION

AHJ:	
DESIGNED BY:	D. MILLER
DRAWN BY:	B. DAVIS
CHECKED BY:	R. HARRISON
APPROVED BY:	P. LOPEZ-HILFIKER

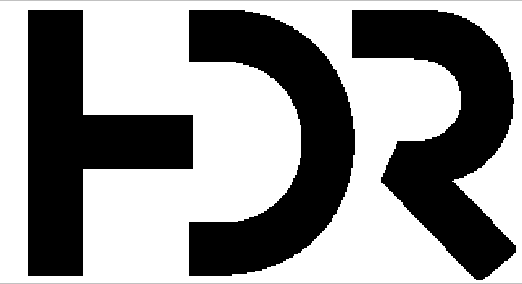

SUBMITTED BY:	DATE:	REVIEWED BY:
PABLO LOPEZ-HILFIKER		

PACKAGE #

	SCALE: 1" = 30'-0"
	FILENAME: OMFS-M08-B-v2022
	CONTRACT No.: AE0030-17
	SUBMITTAL DATE:

SOUND TRANSIT
PRELIMINARY ENGINEERING PLANS
OPERATIONS & MAINTANCE FACILITY SOUTH

BMS SYSTEMS
FLOOR PLAN - LEVEL 1

DRAWING No.:	M08-BPP101
FACILITY ID:	M08
SHEET No:	REV:

GENERAL NOTES:

1. FINAL DESIGN SHALL PROVIDE FOR CONDUIT PATHWAY (1" MIN.) BETWEEN MECHANICAL BMS CONNECTIONS AND COMMUNICATION ROOM. ROUTING TO BE UNDERGROUND UNLESS NOT POSSIBLE BASED ON BUILDING CONSTRUCTION RESTRAINTS. ALL VISIBLE PATHWAYS MUST BE APPROVED BY ST. PATHWAYS CAN BE COMBINED FOR EFFICIENCY.
2. FINAL DESIGN TO PROVIDE FULL ADDRESSABLE FIRE ALARM SYSTEM.
3. FINAL DESIGN TO PROVIDE ACCESS CONTROL AT ENTRY DOORS, GATES, DESIGNATED INTERIOR DOORS.
4. FINAL DESIGN TO PROVIDE SECURITY CAMERA AT ENTRY POINTS, GATES, DESIGNATED INTERIOR AREAS.

FIRE ALARM/EVAC SYSTEM (FAEV):

1. PROVIDE MANUAL PULL STATION AT EACH EXIT.
2. PROVIDE SMOKE AND HEAT DETECTOR FOR EACH ELECTRICAL ROOM. SMOKE AND HEAT MUST BE ABLE TO BE UNIQUELY IDENTIFIED WHEN IN ALARM.
3. PROVIDE MONITOR MODULES FOR FIRE SUPPRESSION CONTROL PANELS (FSCP) FOR CLEAN AGENT IN EACH IT/MDF/IDF ROOM. MONITOR FOR ALARM, SUPERVISORY & TROUBLE FOR EACH FSCP.
4. COORDINATE WITH FIRE SUPPRESSION CONTRACTOR FOR PRE-ACTION REQUIREMENTS BY AHJ IN THE IT/MDF/IDF ROOMS.
5. FINAL DESIGN TO HAVE FACP PANEL LOCATION COORDINATED WITH CITY, STATE AND LOCAL AHJ AND SOUND TRANSIT.
6. PROVIDE EVAC (SPEAKER/STROBES & STROBES) THROUGHOUT ALL OCCUPIABLE AREAS OF BUILDING INCLUDING MAINTENANCE TRENCHES & MEZZANINES. SPEAKERS SHALL BE SET TO OBTAIN 15 dBA OVER AVERAGE AMBIENT CONDITIONS AND STROBES WILL PROVIDE COVERAGE AS PRESCRIBED IN CHAPTER 18 OF NFPA 72 (VERIFY VERSION W/AHJ).
7. PROVIDE RELAY INTERFACE TO OVERHEAD FANS TO SHUTDOWN FANS ON WATER FLOW.
8. PROVIDE LCD TYPE ANNUNCIATOR IN EACH BUILDING VESTIBULE, MDF ROOM & FIRE SPRINKLER RISER ROOM.
9. PROVIDE LCD TYPE ANNUNCIATOR AND EVAC REMOTE MICROPHONE AT PRIMARY FIRE DEPT./FIRST RESPONDER ENTRY POINT.

ACCESS CONTROL SYSTEM (ACS):

1. PROVIDE ACS CARD READER AT EACH PERIMETER PERSONNEL DOOR (SINGLE AND/OR DOUBLE DOORS). COORDINATE WITH DOOR HARDWARE SUPPLIER TO HAVE DOOR FUNCTION AS A "CARD IN/FREE EXIT" (CI/FE) DOOR.
2. BASIC REQUIREMENTS OF ACS DOOR ARE TO HAVE:

a. CARD READER PER SOUND TRANSIT STANDARD

b. DOOR CONTACT

c. REQUEST-TO-EXIT (INTEGRAL TO DOOR HARDWARE UNLESS ELECTRIC STRIKE IS REQUIRED, THEN USE SENSOR).

d. ELECTRIFIED LOCKING HARDWARE (BY DIV. 8)

VIDEO MANAGEMENT & CAMERAS (VMS):

1. PROVIDE CAMERAS (PER SOUND TRANSIT STANDARDS & COORDINATE MOUNTING HEIGHT W/SOUND TRANSIT) AS FOLLOWS:
2. EXTERIOR:

a. - PTZ AT EACH CORNER ON BUILDING.

b. - FIXED CAMERAS FOR TRAIN INGRESS AND EGRESS APRON AREAS WITH COVERAGE ADEQUATE TO PROVIDE "RECOGNITION" OF PERSONNEL WALKING THROUGH THESE AREAS.


c. - FIXED CAMERAS FOR BUILDING EXTERIOR; GENERAL OBSERVATION FOR PEDESTRIANS AND VEHICLES IMMEDIATELY ADJACENT IN SIDEWALKS AND ROADWAY. COORDINATE WITH SOUND TRANSIT TO PROGRAM "ALARM ALGORITHMS" TO ACTIVATE PTZ "CALL-UP".

d. - FIXED CAMERAS AT BUILDING ENTRY POINTS (ACS DOORS) WITH COVERAGE ADEQUATE TO PROVIDE "RECOGNITION" OF PERSONNEL ENTERING DOORS.
3. INTERIOR:

a. - FIXED CAMERAS AT BUILDING ENTRY POINTS (ACS DOORS) WITH COVERAGE ADEQUATE TO PROVIDE IDENTIFICATION" OF PERSONNEL ENTERING DOORS.

b. - FIXED CAMERAS AT CRITICAL INFRASTRUCTURE ROOMS SUCH AS ELECTRICAL, IT, MDF & IDF ROOMS. (ACS DOORS) WITH COVERAGE ADEQUATE TO PROVIDE IDENTIFICATION" OF PERSONNEL ENTERING DOORS.

KEY PLAN - M08W

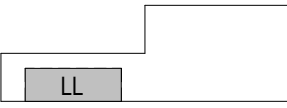


NOTES:

1. FINAL DESIGN SHALL COORDINATE WITH COMMUNICATION FOR PATCH PANEL SPACE FOR ALL BMS CONNECTIONS TO THE TELECOMMUNICATION NETWORK.
2. PROVIDE FATC WITH CONVENTIONAL ZONE INPUTS AS FOLLOWS:

a. X1 PER FLOW AND PRESSURE ALARM SWITCH,

b. X1 PER RISER SUPERVISORY VALVE,


c. X1 PER EACH UNIQUE INPUT NOT COVERED ABOVE.
3. ELECTRICAL METERING IN THIS ROOM TO HAVE CONNECTION TO BMS SYSTEM.

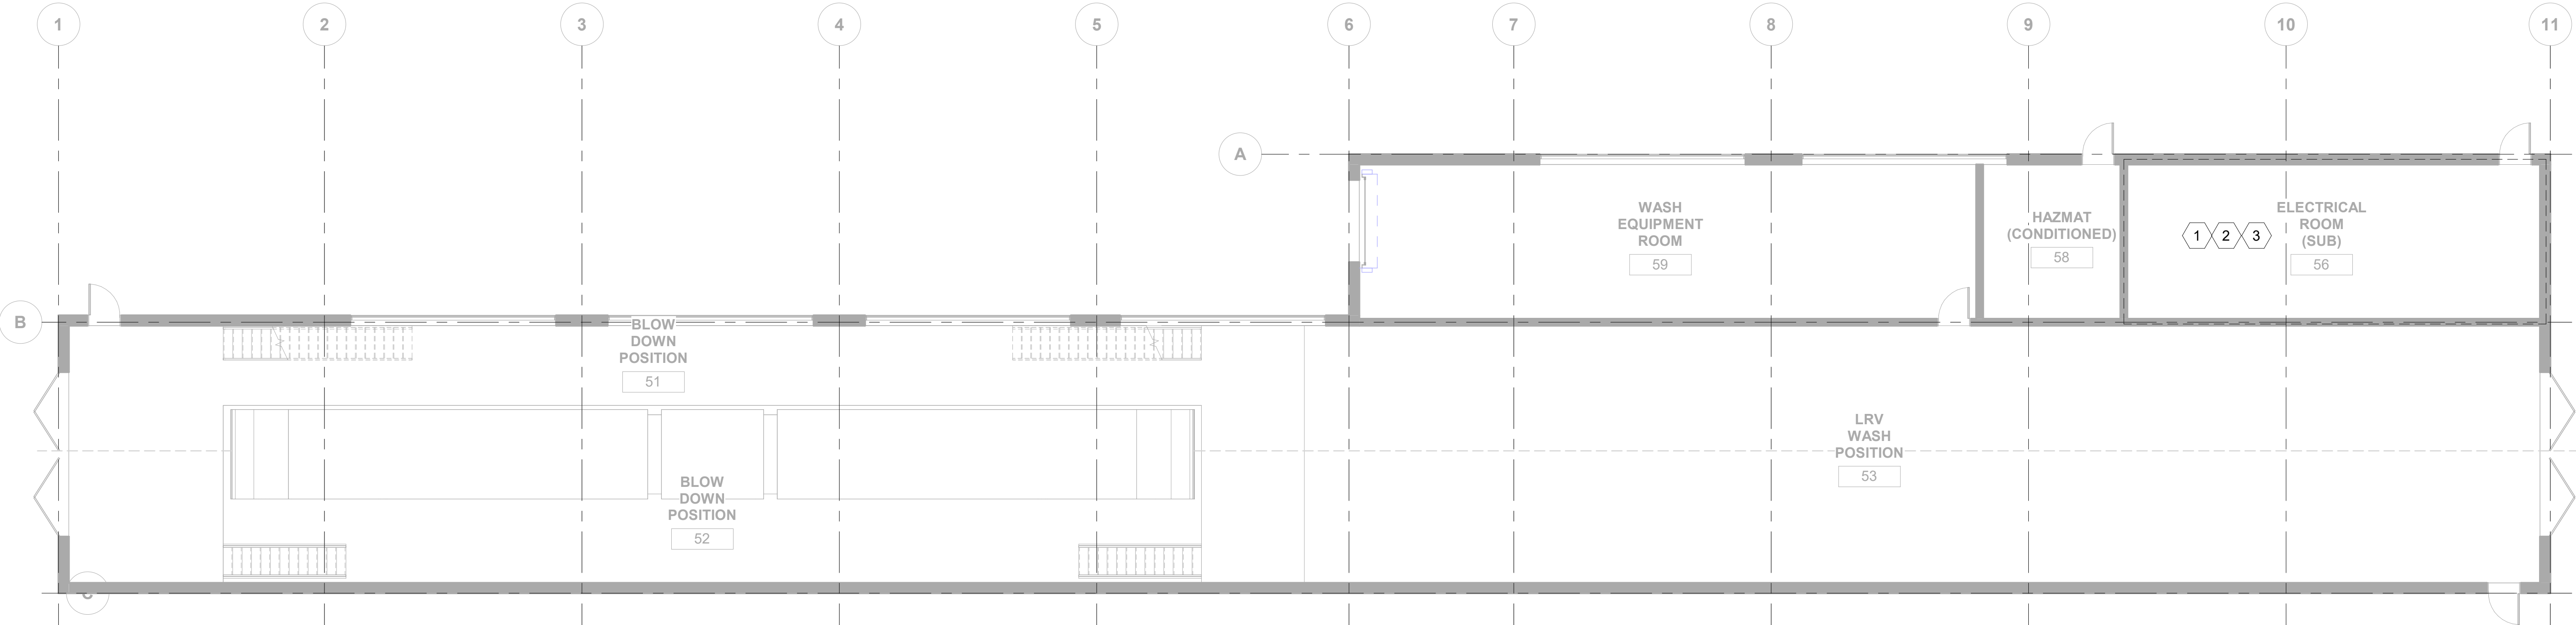

Level 1

SCALE: 1/8" = 1'-0"

1

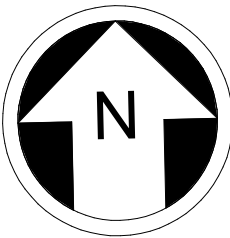



NOT FOR CONSTRUCTION

Refer to the plan set COVER drawing for disclaimers regarding this drawing.

REFERENCE CONCEPT DRAWINGS

No.	DATE	DSN	CHK	APP	REVISION

AHJ:					PACKAGE #				
DESIGNED BY: D. MILLER			LINE IS 1" AT FULL SCALE	SCALE: 1/8" = 1'-0"	SOUND TRANSIT PRELIMINARY ENGINEERING PLANS OPERATIONS & MAINTENANCE FACILITY SOUTH BMS SYSTEMS FLOOR PLAN - LEVEL 1	DRAWING No.:			
DRAWN BY: B. DAVIS				FILENAME: OMFS-M08W-B-v2022		M08W-BPP101			
CHECKED BY: R. HARRISON				CONTRACT No.: AE0030-17		FACILITY ID:			
APPROVED BY: P. LOPEZ-HILFIKER				SUBMITTAL DATE:		08W			
SUBMITTED BY: PABLO LOPEZ-HILFIKER		DATE:	REVIEWED BY:	DATE:	SHEET No: REV:				

NOTES:

- 1. FINAL DESIGN SHALL COORDINATE WITH COMMUNICATION FOR PATCH PANEL SPACE FOR ALL BMS CONNECTIONS TO THE TELECOMMUNICATION NETWORK.
- 2. PROVIDE FATC WITH CONVENTIONAL ZONE INPUTS AS FOLLOWS:
 - a. X1 PER FLOW AND PRESSURE ALARM SWITCH,
 - b. X1 PER RISER SUPERVISORY VALVE,
 - c. X1 PER EACH UNIQUE INPUT NOT COVERED ABOVE.
- 3. ELECTRICAL METERING IN THIS ROOM TO HAVE CONNECTION TO BMS SYSTEM.
- 4. PROVIDE FULL WALL WIDTH (EAST WALL) X FLOOR-TO-CEILING WALL SPACE FOR FIRE ALARM/EVAC SYSTEM. PROVIDE EST4 PER SOUND TRANSIT STANDARDS. PROVIDE SMOKE DETECTOR AS REQUIRED BY NFPA 72.
- 5. PROVIDE 8' W X FLOOR-TO-CEILING WALL SPACE FOR ACCESS CONTROL PANELS AND POWER SUPPLIES. PROVIDE LENEL ACS PER SOUND TRANSIT STANDARDS.

GENERAL NOTES:

- 1. FINAL DESIGN SHALL PROVIDE FOR CONDUIT PATHWAY (1" MIN.) BETWEEN MECHANICAL BMS CONNECTIONS AND COMMUNICATION ROOM. ROUTING TO BE UNDERGROUND UNLESS NOT POSSIBLE BASED ON BUILDING CONSTRUCTION RESTRAINTS. ALL VISIBLE PATHWAYS MUST BE APPROVED BY ST. PATHWAYS CAN BE COMBINED FOR EFFICIENCY.
 - 2. FINAL DESIGN TO PROVIDE FULL ADDRESSABLE FIRE ALARM SYSTEM.
 - 3. FINAL DESIGN TO PROVIDE ACCESS CONTROL AT ENTRY DOORS, GATES, DESIGNATED INTERIOR DOORS.
 - 4. FINAL DESIGN TO PROVIDE SECURITY CAMERA AT ENTRY POINTS, GATES, DESIGNATED INTERIOR AREAS.
- FIRE ALARM/EVAC SYSTEM (FAEV):
- 1. PROVIDE MANUAL PULL STATION AT EACH EXIT.
 - 2. PROVIDE SMOKE AND HEAT DETECTOR FOR EACH ELECTRICAL ROOM. SMOKE AND HEAT MUST BE ABLE TO BE UNIQUELY IDENTIFIED WHEN IN ALARM.
 - 3. PROVIDE MONITOR MODULES FOR FIRE SUPPRESSION CONTROL PANELS (FSCP) FOR CLEAN AGENT IN EACH IT/MDF/IDF ROOM. MONITOR FOR ALARM, SUPERVISORY & TROUBLE FOR EACH FSCP.
 - 4. COORDINATE WITH FIRE SUPPRESSION CONTRACTOR FOR PRE-ACTION REQUIREMENTS BY AHJ IN THE IT/MDF/IDF ROOMS.
 - 5. FINAL DESIGN TO HAVE FACP PANEL LOCATION COORDINATED WITH CITY, STATE AND LOCAL AHJ AND SOUND TRANSIT.
 - 6. PROVIDE EVAC (SPEAKER/STROBES & STROBES) THROUGHOUT ALL OCCUPIABLE AREAS OF BUILDING INCLUDING MAINTENANCE TRENCHES & MEZZANINES. SPEAKERS SHALL BE SET TO OBTAIN 15 dBA OVER AVERAGE AMBIENT CONDITIONS AND STROBES WILL PROVIDE COVERAGE AS PRESCRIBED IN CHAPTER 18 OF NFPA 72 (VERIFY VERSION W/AHJ).
 - 7. PROVIDE RELAY INTERFACE TO OVERHEAD FANS TO SHUTDOWN FANS ON WATER FLOW.
 - 8. PROVIDE LCD TYPE ANNUNCIATOR IN EACH BUILDING VESTIBULE, MDF ROOM & FIRE SPRINKLER RISER ROOM.
 - 9. PROVIDE LCD TYPE ANNUNCIATOR AND EVAC REMOTE MICROPHONE AT PRIMARY FIRE DEPT./FIRST RESPONDER ENTRY POINT.



ACCESS CONTROL SYSTEM (ACS):

- 1. PROVIDE ACS CARD READER AT EACH PERIMETER PERSONNEL DOOR (SINGLE AND/OR DOUBLE DOORS). COORDINATE WITH DOOR HARDWARE SUPPLIER TO HAVE DOOR FUNCTION AS A "CARD IN/FREE EXIT" (CI/FE) DOOR.
- 2. BASIC REQUIREMENTS OF ACS DOOR ARE TO HAVE:
 - a. CARD READER PER SOUND TRANSIT STANDARD
 - b. DOOR CONTACT
 - c. REQUEST-TO-EXIT (INTEGRAL TO DOOR HARDWARE UNLESS ELECTRIC STRIKE IS REQUIRED, THEN USE SENSOR).
 - d. ELECTRIFIED LOCKING HARDWARE (BY DIV. 8)

VIDEO MANAGEMENT & CAMERAS (VMS):

- 1. PROVIDE CAMERAS (PER SOUND TRANSIT STANDARDS & COORDINATE MOUNTING HEIGHT W/SOUND TRANSIT) AS FOLLOWS:
- 2. EXTERIOR:
 - a. - PTZ AT EACH CORNER ON BUILDING.
 - b. - FIXED CAMERAS FOR TRAIN INGRESS AND EGRESS APRON AREAS WITH COVERAGE ADEQUATE TO PROVIDE "RECOGNITION" OF PERSONNEL WALKING THROUGH THESE AREAS.
 - c. - FIXED CAMERAS FOR BUILDING EXTERIOR: GENERAL OBSERVATION FOR PEDESTRIANS AND VEHICLES IMMEDIATELY ADJACENT IN SIDEWALKS AND ROADWAY. COORDINATE WITH SOUND TRANSIT TO PROGRAM "ALARM ALGORITHMS" TO ACTIVATE PTZ "CALL-UP".
 - d. - FIXED CAMERAS AT BUILDING ENTRY POINTS (ACS DOORS) WITH COVERAGE ADEQUATE TO PROVIDE "RECOGNITION" OF PERSONNEL ENTERING DOORS.
- 3. INTERIOR:
 - a. - FIXED CAMERAS AT BUILDING ENTRY POINTS (ACS DOORS) WITH COVERAGE ADEQUATE TO PROVIDE IDENTIFICATION" OF PERSONNEL ENTERING DOORS.
 - b. - FIXED CAMERAS AT CRITICAL INFRASTRUCTURE ROOMS SUCH AS ELECTRICAL, IT, MDF & IDF ROOMS. (ACS DOORS) WITH COVERAGE ADEQUATE TO PROVIDE IDENTIFICATION" OF PERSONNEL ENTERING DOORS.

KEY PLAN - M09

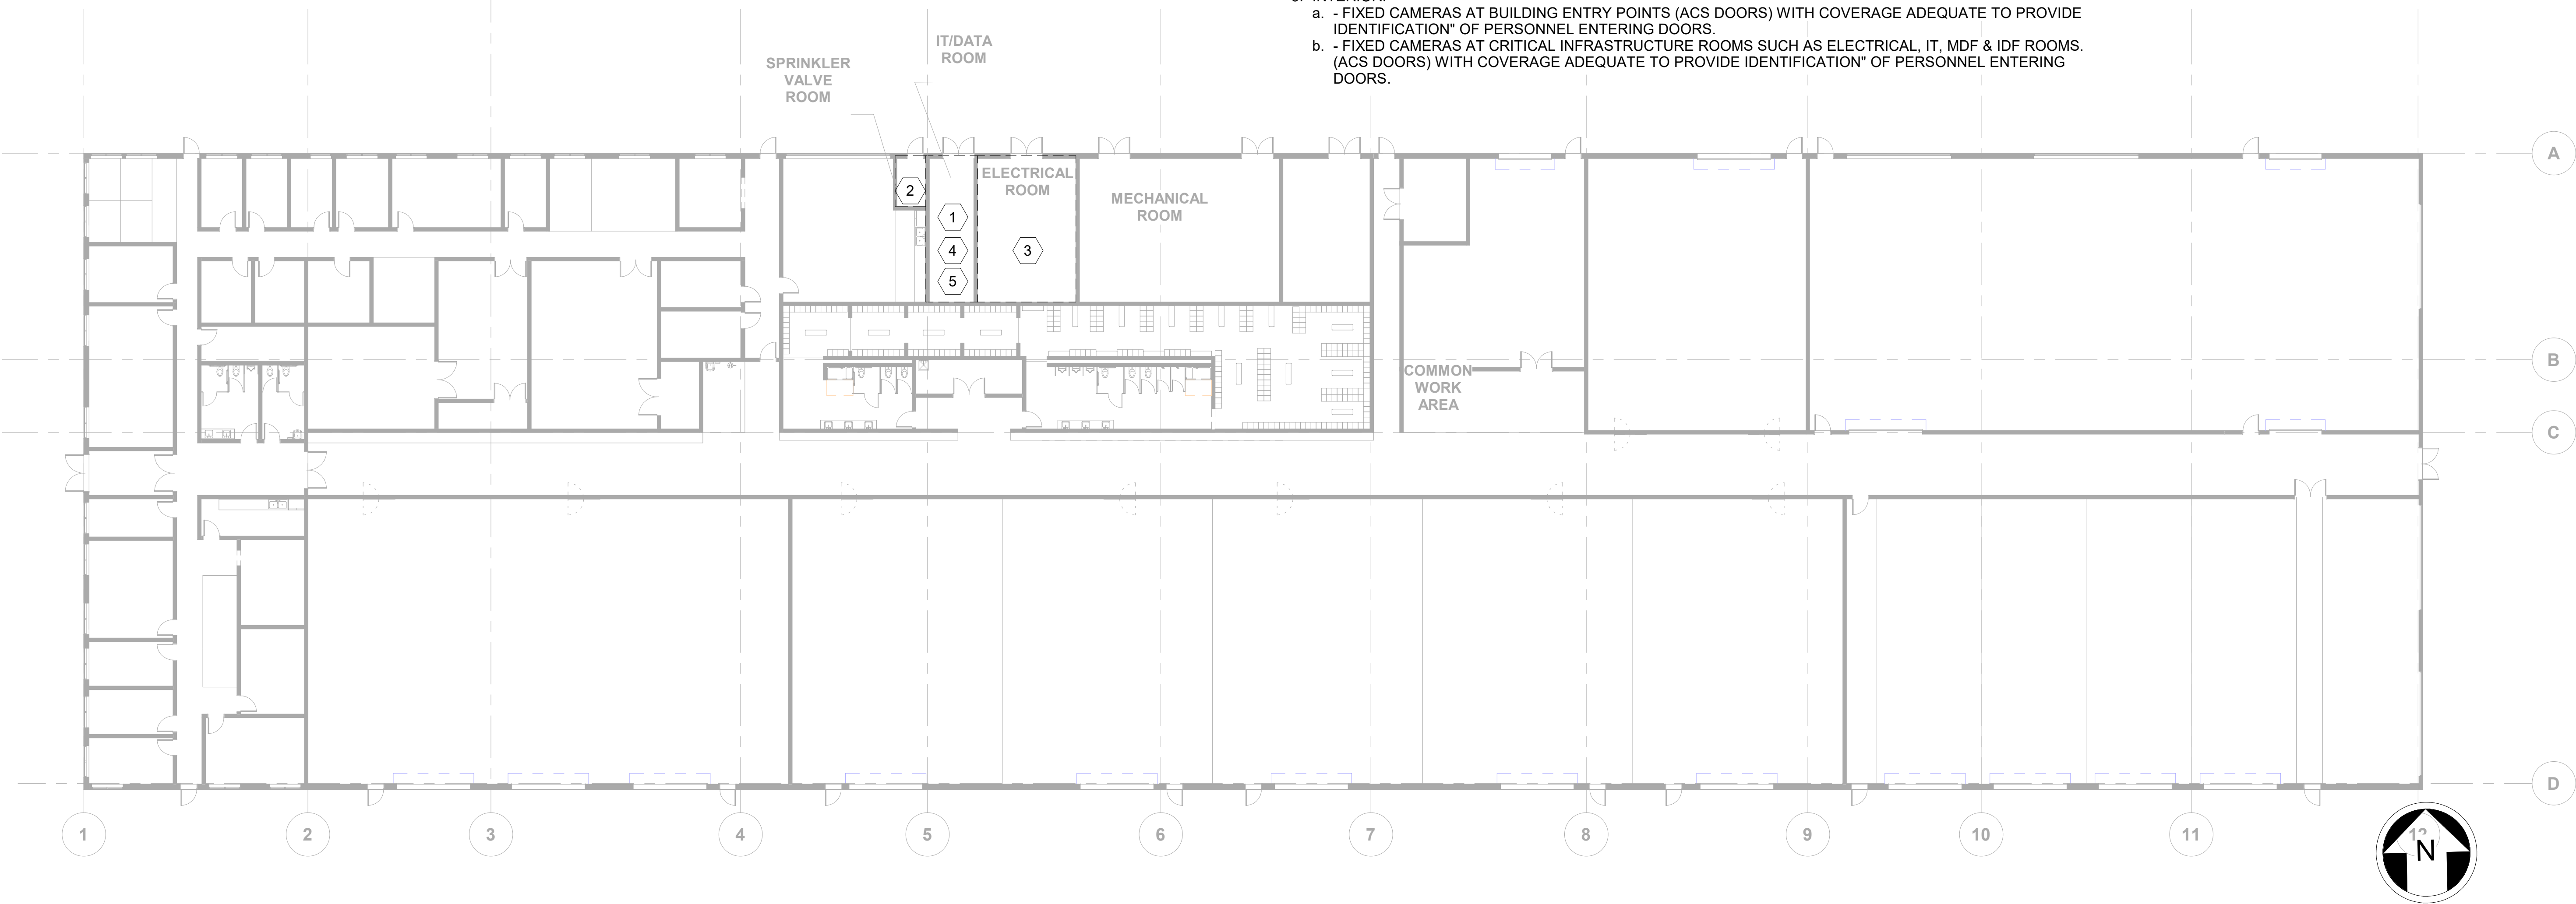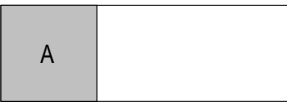

M09 - GRADE LEVEL

SCALE: 1/16" = 1'-0"

1





NOT FOR CONSTRUCTION

Refer to the plan set COVER drawing for disclaimers regarding this drawing.

REFERENCE CONCEPT DRAWINGS

No.	DATE	DSN	CHK	APP	REVISION



AHJ:					PACKAGE #				
DESIGNED BY: D. MILLER			LINE IS 1" AT FULL SCALE	SCALE: 1/16" = 1'-0"	<div>SOUND TRANSIT PRELIMINARY ENGINEERING PLANS OPERATIONS & MAINTANCE FACILITY SOUTH</div>	DRAWING No.: M09-BPP101			
DRAWN BY: B. DAVIS				FILENAME: OMFS-M09-B-v2022			FACILITY ID: M09		
CHECKED BY: R. HARRISON				CONTRACT No.: AE0030-17				SHEET No: REV:	
APPROVED BY: P. LOPEZ-HILFIKER				SUBMITTAL DATE:					
SUBMITTED BY: PABLO LOPEZ-HILFIKER				DATE:			REVIEWED BY:	DATE:	BMS SYSTEMS FLOOR PLAN - LEVEL 1


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Refer to the plan set COVER drawing
for disclaimers regarding this drawing.

REFERENCE CONCEPT DRAWINGS


No.	DATE	DSN	CHK	APP	REVISION

AHJ:					PACKAGE #				
DESIGNED BY: D.MILLER	<div><div>LINE IS 1" AT FULL SCALE</div><div> SOUNDTRANSIT</div></div>			SCALE: 1' 1/8" = 1'-0"		<div>SOUND TRANSIT</div> <div>PRELIMINARY ENGINEERING PLANS</div> <div>OPERATIONS & MAINTANCE FACILITY SOUTH</div> <div><div>BMS SYSTEMS</div><div>FLOOR PLAN - LEVEL 1</div></div>		DRAWING No.: M09W-BPP101	
DRAWN BY: B.DAVIS				FILENAME: OMFS-M09W-B-v2022				FACILITY ID: M09W	
CHECKED BY: R.HARRISON				CONTRACT No.: AE0030-17				SHEET No: REV:	
APPROVED BY: P. LOPEZ-HILFIKER				SUBMITTED BY: PABLO LOPEZ-HILFIKER				DATE:	

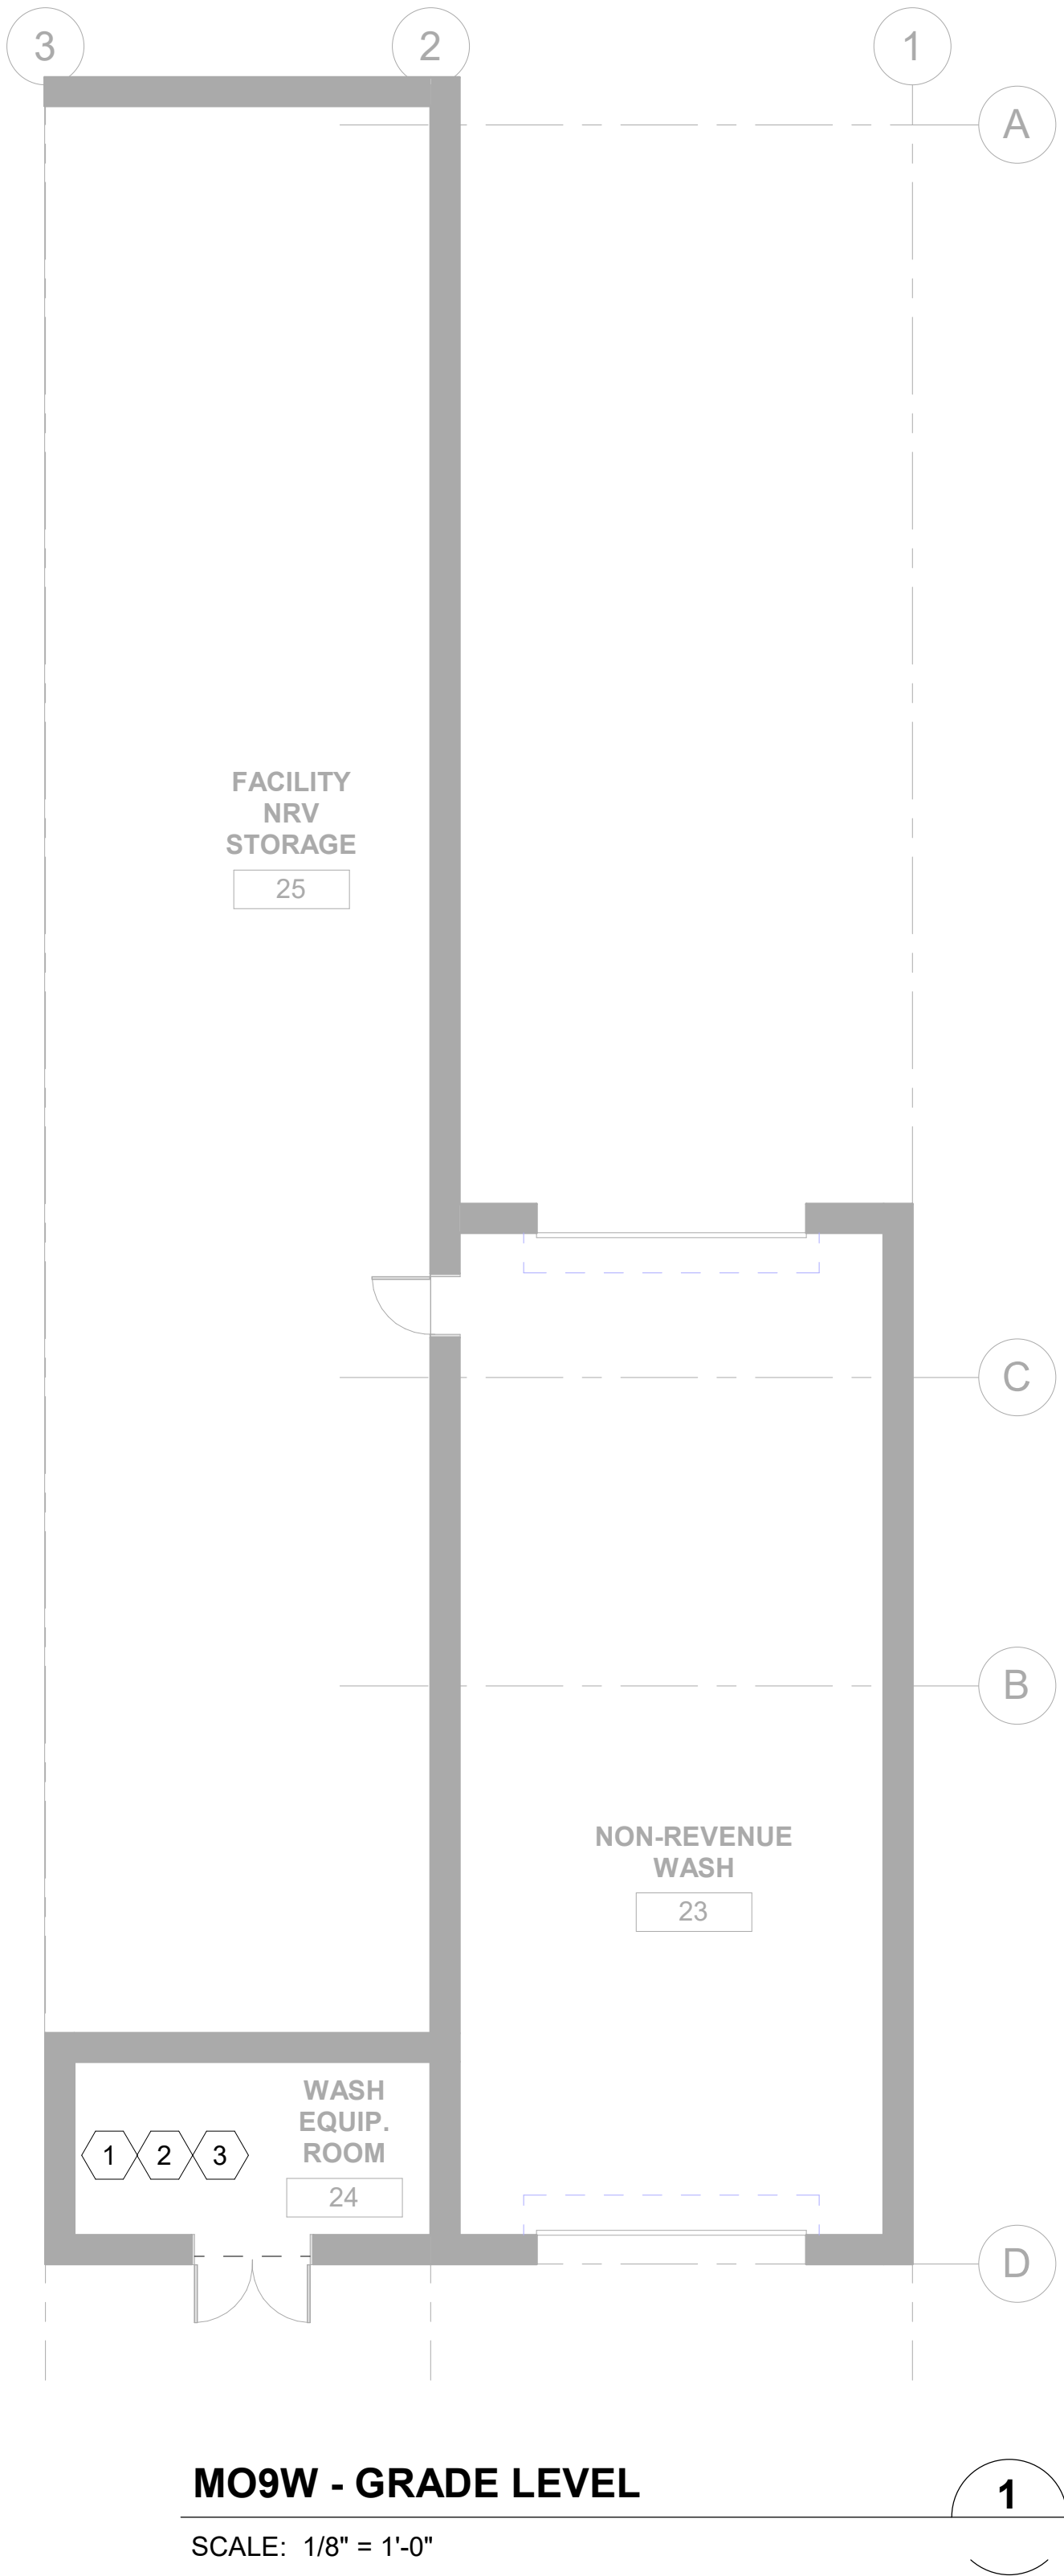


- GENERAL NOTES:
- FINAL DESIGN SHALL PROVIDE FOR CONDUIT PATHWAY (1" MIN.) BETWEEN MECHANICAL BMS CONNECTIONS AND COMMUNICATION ROOM. ROUTING TO BE UNDERGROUND UNLESS NOT POSSIBLE BASED ON BUILDING CONSTRUCTION RESTRAINTS. ALL VISIBLE PATHWAYS MUST BE APPROVED BY ST. PATHWAYS CAN BE COMBINED FOR EFFICIENCY.
 - FINAL DESIGN TO PROVIDE FULL ADDRESSABLE FIRE ALARM SYSTEM.
 - FINAL DESIGN TO PROVIDE ACCESS CONTROL AT ENTRY DOORS, GATES, DESIGNATED INTERIOR DOORS.
 - FINAL DESIGN TO PROVIDE SECURITY CAMERA AT ENTRY POINTS, GATES, DESIGNATED INTERIOR AREAS.
- FIRE ALARM/EVAC SYSTEM (FAEV):
- PROVIDE MANUAL PULL STATION AT EACH EXIT.
 - PROVIDE SMOKE AND HEAT DETECTOR FOR EACH ELECTRICAL ROOM. SMOKE AND HEAT MUST BE ABLE TO BE UNIQUELY IDENTIFIED WHEN IN ALARM.
 - PROVIDE MONITOR MODULES FOR FIRE SUPPRESSION CONTROL PANELS (FSCP) FOR CLEAN AGENT IN EACH IT/MDF/IDF ROOM. MONITOR FOR ALARM, SUPERVISORY & TROUBLE FOR EACH FSCP.
 - COORDINATE WITH FIRE SUPPRESSION CONTRACTOR FOR PRE-ACTION REQUIREMENTS BY AHJ IN THE IT/MDF/IDF ROOMS.
 - FINAL DESIGN TO HAVE FACP PANEL LOCATION COORDINATED WITH CITY, STATE AND LOCAL AHJ AND SOUND TRANSIT.
 - PROVIDE EVAC (SPEAKER/STROBES & STROBES) THROUGHOUT ALL OCCUPIABLE AREAS OF BUILDING INCLUDING MAINTENANCE TRENCHES & MEZZANINES. SPEAKERS SHALL BE SET TO OBTAIN 15 dBA OVER AVERAGE AMBIENT CONDITIONS AND STROBES WILL PROVIDE COVERAGE AS PRESCRIBED IN CHAPTER 18 OF NFPA 72 (VERIFY VERSION W/AHJ).
 - PROVIDE RELAY INTERFACE TO OVERHEAD FANS TO SHUTDOWN FANS ON WATER FLOW.
 - PROVIDE LCD TYPE ANNUNCIATOR IN EACH BUILDING VESTIBULE, MDF ROOM & FIRE SPRINKLER RISER ROOM.
 - PROVIDE LCD TYPE ANNUNCIATOR AND EVAC REMOTE MICROPHONE AT PRIMARY FIRE DEPT./FIRST RESPONDER ENTRY POINT.
- ACCESS CONTROL SYSTEM (ACS):
- PROVIDE ACS CARD READER AT EACH PERIMETER PERSONNEL DOOR (SINGLE AND/OR DOUBLE DOORS). COORDINATE WITH DOOR HARDWARE SUPPLIER TO HAVE DOOR FUNCTION AS A "CARD IN/FREE EXIT" (CI/FE) DOOR.
 - BASIC REQUIREMENTS OF ACS DOOR ARE TO HAVE:
 - CARD READER PER SOUND TRANSIT STANDARD
 - DOOR CONTACT
 - REQUEST-TO-EXIT (INTEGRAL TO DOOR HARDWARE UNLESS ELECTRIC STRIKE IS REQUIRED, THEN USE SENSOR).
 - ELECTRIFIED LOCKING HARDWARE (BY DIV. 8)
- VIDEO MANAGEMENT & CAMERAS (VMS):
- PROVIDE CAMERAS (PER SOUND TRANSIT STANDARDS & COORDINATE MOUNTING HEIGHT W/SOUND TRANSIT) AS FOLLOWS:
 - PTZ AT EACH CORNER ON BUILDING.
 - FIXED CAMERAS FOR TRAIN INGRESS AND EGRESS APRON AREAS WITH COVERAGE ADEQUATE TO PROVIDE "RECOGNITION" OF PERSONNEL WALKING THROUGH THESE AREAS.
 - FIXED CAMERAS FOR BUILDING EXTERIOR; GENERAL OBSERVATION FOR PEDESTRIANS AND VEHICLES IMMEDIATELY ADJACENT IN SIDEWALKS AND ROADWAY. COORDINATE WITH SOUND TRANSIT TO PROGRAM "ALARM ALGORITHMS" TO ACTIVATE PTZ "CALL-UP".
 - FIXED CAMERAS AT BUILDING ENTRY POINTS (ACS DOORS) WITH COVERAGE ADEQUATE TO PROVIDE "RECOGNITION" OF PERSONNEL ENTERING DOORS.
 - INTERIOR:
 - FIXED CAMERAS AT BUILDING ENTRY POINTS (ACS DOORS) WITH COVERAGE ADEQUATE TO PROVIDE IDENTIFICATION" OF PERSONNEL ENTERING DOORS.
 - FIXED CAMERAS AT CRITICAL INFRASTRUCTURE ROOMS SUCH AS ELECTRICAL, IT, MDF & IDF ROOMS. (ACS DOORS) WITH COVERAGE ADEQUATE TO PROVIDE IDENTIFICATION" OF PERSONNEL ENTERING DOORS.

KEY PLAN - M09W

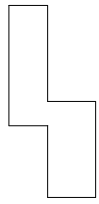

- NOTES:
- FINAL DESIGN SHALL COORDINATE WITH COMMUNICATION FOR PATCH PANEL SPACE FOR ALL BMS CONNECTIONS TO THE TELECOMMUNICATION NETWORK.
 - PROVIDE FATC WITH CONVENTIONAL ZONE INPUTS AS FOLLOWS:
 - X1 PER FLOW AND PRESSURE ALARM SWITCH,
 - X1 PER RISER SUPERVISORY VALVE,
 - X1 PER EACH UNIQUE INPUT NOT COVERED ABOVE.
 - ELECTRICAL METERING IN THIS ROOM TO HAVE CONNECTION TO BMS SYSTEM.

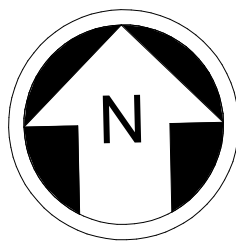

NOT FOR
CONSTRUCTION

NOTES:

1. FINAL DESIGN SHALL COORDINATE WITH COMMUNICATION FOR PATCH PANEL SPACE FOR ALL BMS CONNECTIONS TO THE TELECOMMUNICATIONS NETWORK.
2. PROVIDE FATC WITH CONVENTIONAL ZONE INPUTS AS FOLLOWS:
 - a. X1 PER FLOW AND PRESSURE ALARM SWITCH,
 - b. X1 PER RISER SUPERVISORY VALVE,
 - c. X1 PER EACH UNIQUE INPUT NOT COVERED ABOVE.
3. ELECTRICAL METERING IN THIS ROOM TO HAVE CONNECTION TO BMS SYSTEM.
4. PROVIDE FULL WALL WIDTH (EAST WALL) X FLOOR-TO-CEILING WALL SPACE FOR FIRE ALARM/EVAC SYSTEM. PROVIDE EST4 PER SOUND TRANSIT STANDARDS. PROVIDE SMOKE DETECTOR AS REQUIRED BY NFPA 72.
5. PROVIDE 8' W X FLOOR-TO-CEILING WALL SPACE FOR ACCESS CONTROL PANELS AND POWER SUPPLIES. PROVIDE LENEL ACS PER SOUND TRANSIT STANDARDS.

GENERAL NOTES:

1. FINAL DESIGN SHALL PROVIDE FOR CONDUIT PATHWAY (1" MIN.) BETWEEN MECHANICAL BMS CONNECTIONS AND COMMUNICATION ROOM. ROUTING TO BE UNDERGROUND UNLESS NOT POSSIBLE BASED ON BUILDING CONSTRUCTION RESTRAINTS. ALL VISIBLE PATHWAYS MUST BE APPROVED BY ST. PATHWAYS CAN BE COMBINED FOR EFFICIENCY.
2. FINAL DESIGN TO PROVIDE FULL ADDRESSABLE FIRE ALARM SYSTEM.
3. FINAL DESIGN TO PROVIDE ACCESS CONTROL AT ENTRY DOORS, GATES, DESIGNATED INTERIOR DOORS.
4. FINAL DESIGN TO PROVIDE SECURITY CAMERA AT ENTRY POINTS, GATES, DESIGNATED INTERIOR AREAS.

FIRE ALARM/EVAC SYSTEM (FAEV):


1. PROVIDE MANUAL PULL STATION AT EACH EXIT.
2. PROVIDE SMOKE AND HEAT DETECTOR FOR EACH ELECTRICAL ROOM. SMOKE AND HEAT MUST BE ABLE TO BE UNIQUELY IDENTIFIED WHEN IN ALARM.
3. PROVIDE MONITOR MODULES FOR FIRE SUPPRESSION CONTROL PANELS (FSCP) FOR CLEAN AGENT IN EACH IT/MDF/IDF ROOM. MONITOR FOR ALARM, SUPERVISORY & TROUBLE FOR EACH FSCP.

4. COORDINATE WITH FIRE SUPPRESSION CONTRACTOR FOR PRE-ACTION REQUIREMENTS BY AHJ IN THE IT/MDF/IDF ROOMS.
5. FINAL DESIGN TO HAVE FACP PANEL LOCATION COORDINATED WITH CITY, STATE AND LOCAL AHJ AND SOUND TRANSIT.
6. PROVIDE EVAC (SPEAKER/STROBES & STROBES) THROUGHOUT ALL OCCUPIABLE AREAS OF BUILDING INCLUDING MAINTENANCE TRENCHES & MEZZANINES. SPEAKERS SHALL BE SET TO OBTAIN 15 dBA OVER AVERAGE AMBIENT CONDITIONS AND STROBES WILL PROVIDE COVERAGE AS PRESCRIBED IN CHAPTER 18 OF NFPA 72 (VERIFY VERSION W/AHJ).
7. PROVIDE RELAY INTERFACE TO OVERHEAD FANS TO SHUTDOWN FANS ON WATER FLOW.
8. PROVIDE LCD TYPE ANNUNCIATOR IN EACH BUILDING VESTIBULE, MDF ROOM & FIRE SPRINKLER RISER ROOM.
9. PROVIDE LCD TYPE ANNUNCIATOR AND EVAC REMOTE MICROPHONE AT PRIMARY FIRE DEPT./FIRST RESPONDER ENTRY POINT.

ACCESS CONTROL SYSTEM (ACS):


1. PROVIDE ACS CARD READER AT EACH PERIMETER PERSONNEL DOOR (SINGLE AND/OR DOUBLE DOORS). COORDINATE WITH DOOR HARDWARE SUPPLIER TO HAVE DOOR FUNCTION AS A "CARD IN/FREE EXIT" (CI/FE) DOOR.
2. BASIC REQUIREMENTS OF ACS DOOR ARE TO HAVE:
 - a. CARD READER PER SOUND TRANSIT STANDARD
 - b. DOOR CONTACT
 - c. REQUEST-TO-EXIT (INTEGRAL TO DOOR HARDWARE UNLESS ELECTRIC STRIKE IS REQUIRED, THEN USE SENSOR).
 - d. ELECTRIFIED LOCKING HARDWARE (BY DIV. 8)

KEY PLAN - M09W

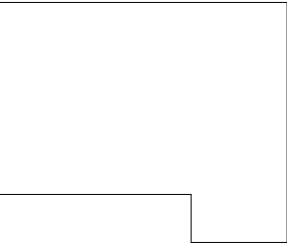

VIDEO MANAGEMENT & CAMERAS (VMS):

1. PROVIDE CAMERAS (PER SOUND TRANSIT STANDARDS & COORDINATE MOUNTING HEIGHT W/SOUND TRANSIT) AS FOLLOWS:
2. EXTERIOR:
 - a. - PTZ AT EACH CORNER ON BUILDING.
 - b. - FIXED CAMERAS FOR TRAIN INGRESS AND EGRESS APRON AREAS WITH COVERAGE ADEQUATE TO PROVIDE "RECOGNITION" OF PERSONNEL WALKING THROUGH THESE AREAS.
 - c. - FIXED CAMERAS FOR BUILDING EXTERIOR; GENERAL OBSERVATION FOR PEDESTRIANS AND VEHICLES IMMEDIATELY ADJACENT IN SIDEWALKS AND ROADWAY. COORDINATE WITH SOUND TRANSIT TO PROGRAM "ALARM ALGORITHMS" TO ACTIVATE PTZ "CALL-UP".
 - d. - FIXED CAMERAS AT BUILDING ENTRY POINTS (ACS DOORS) WITH COVERAGE ADEQUATE TO PROVIDE "RECOGNITION" OF PERSONNEL ENTERING DOORS.
3. INTERIOR:
 - a. - FIXED CAMERAS AT BUILDING ENTRY POINTS (ACS DOORS) WITH COVERAGE ADEQUATE TO PROVIDE IDENTIFICATION" OF PERSONNEL ENTERING DOORS.
 - b. - FIXED CAMERAS AT CRITICAL INFRASTRUCTURE ROOMS SUCH AS ELECTRICAL, IT, MDF & IDF ROOMS. (ACS DOORS) WITH COVERAGE ADEQUATE TO PROVIDE IDENTIFICATION" OF PERSONNEL ENTERING DOORS.

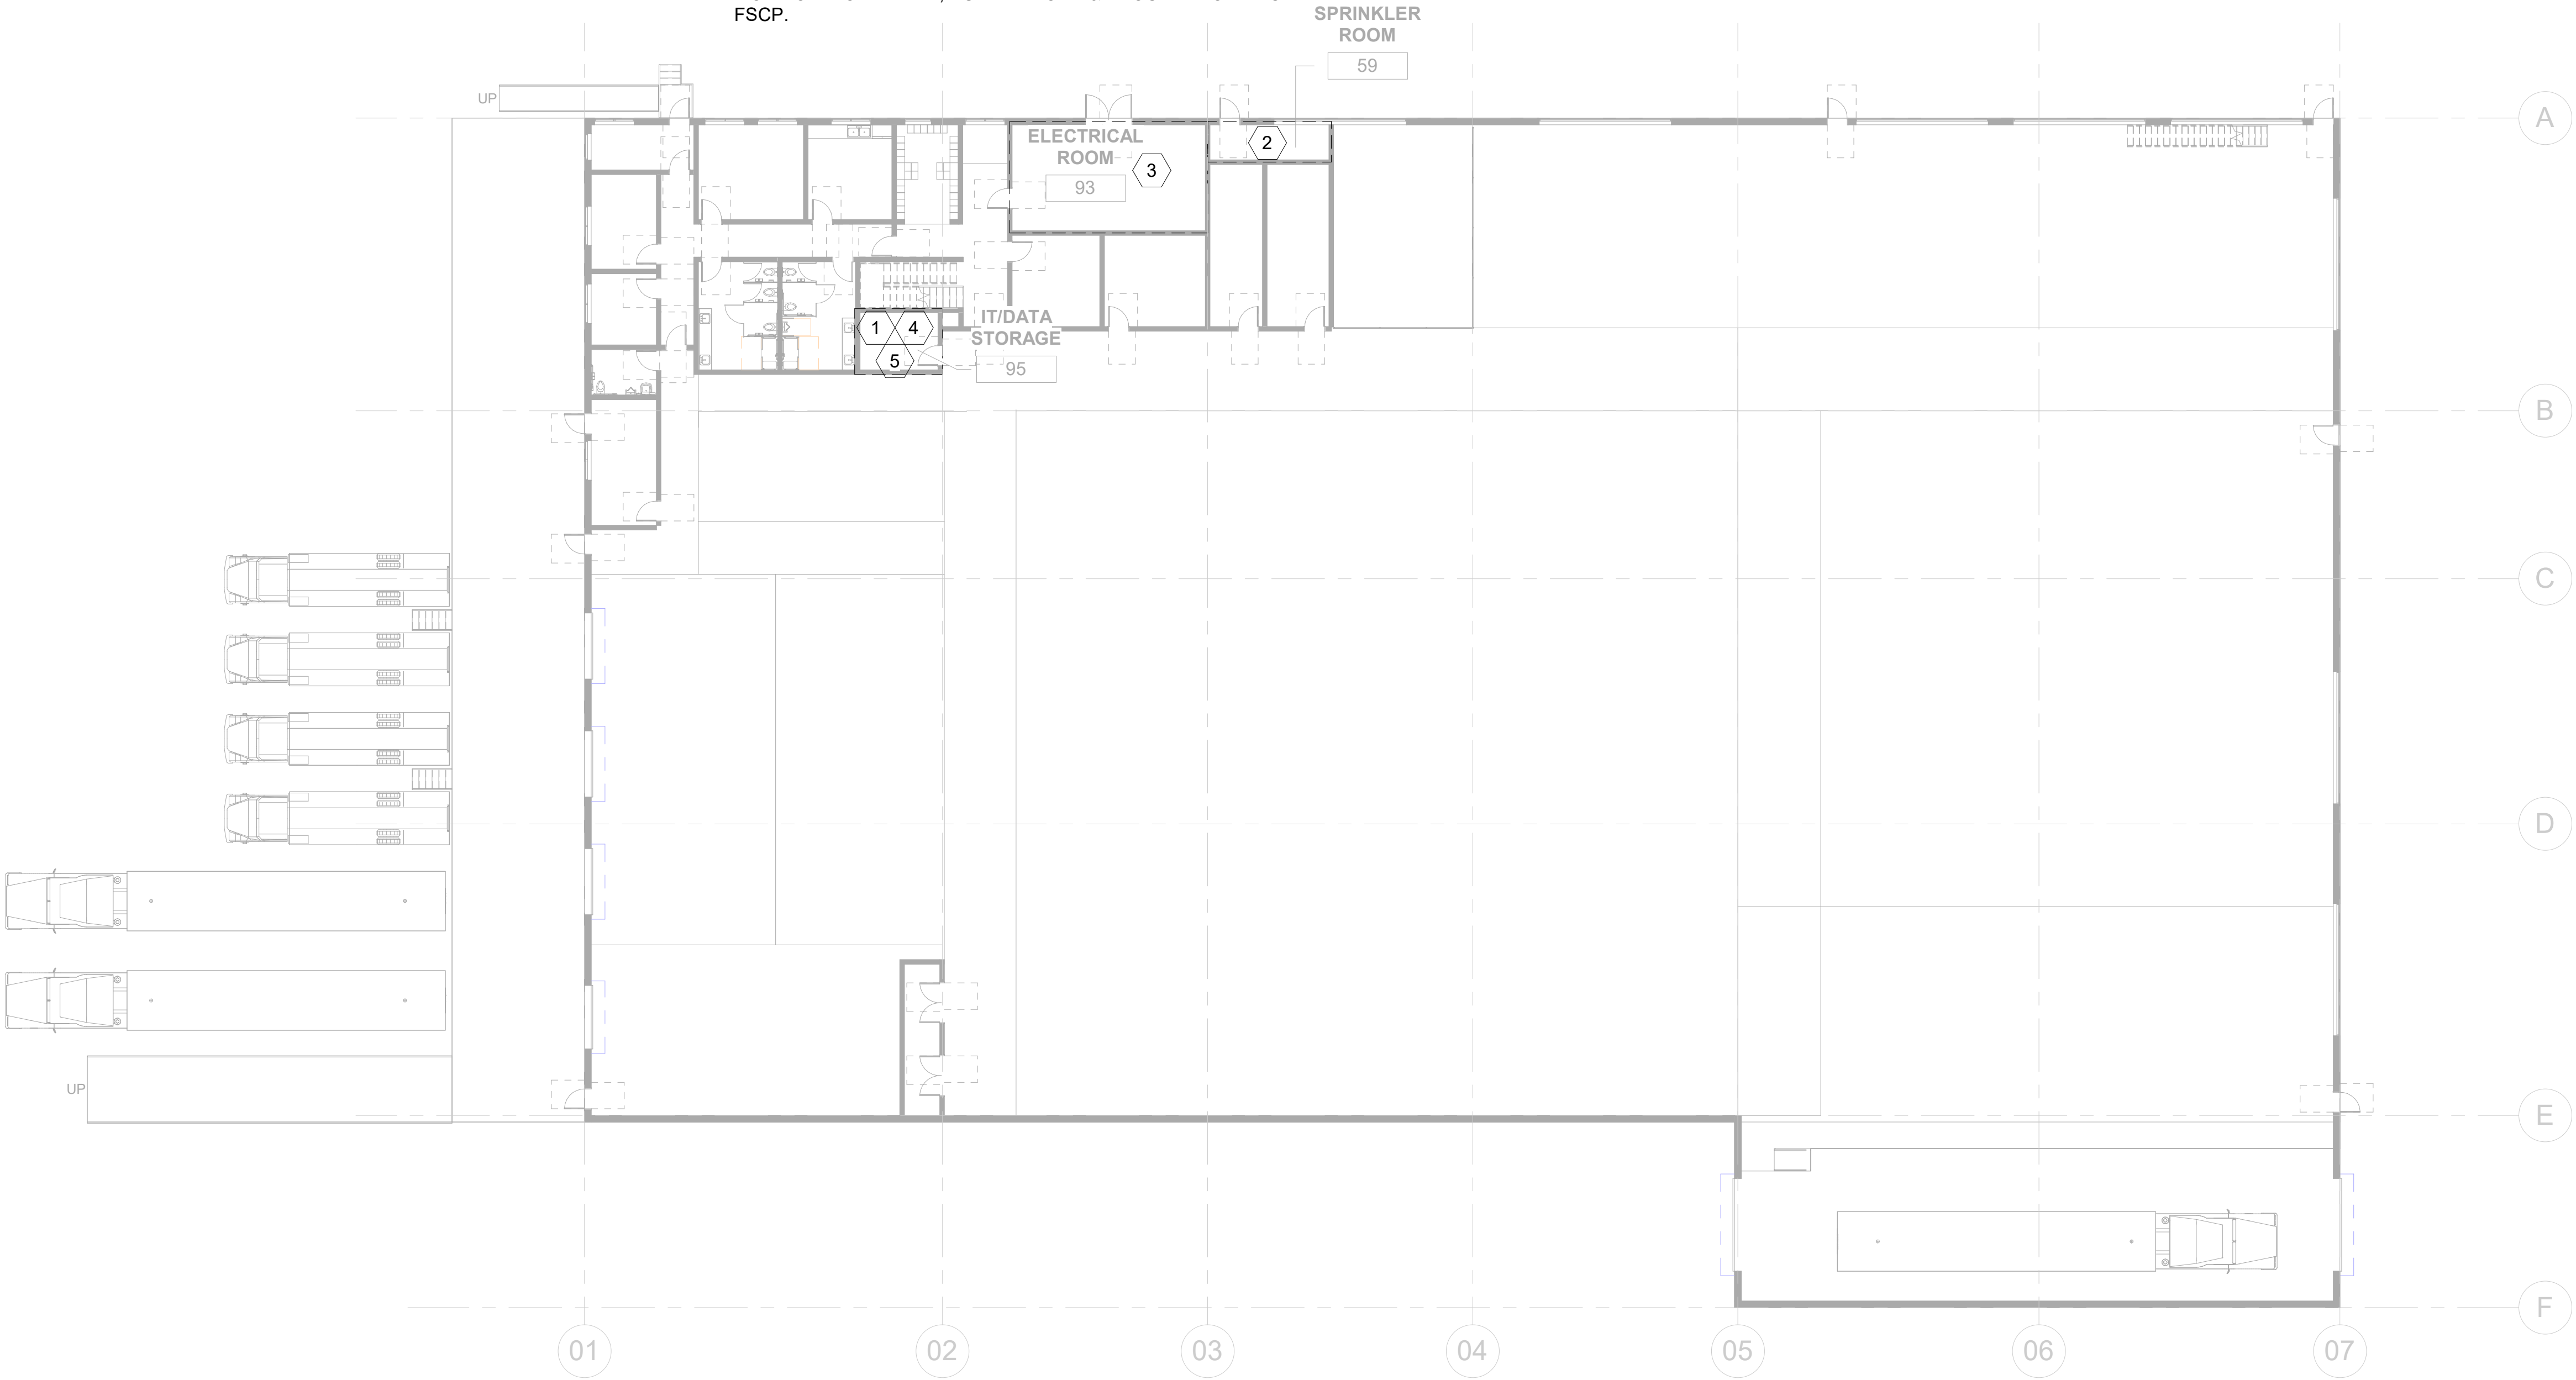



M10 - GRADE LEVEL

SCALE: 1/16" = 1'-0"

Refer to the plan set COVER drawing for disclaimers regarding this drawing.

REFERENCE CONCEPT DRAWINGS

No.	DATE	DSN	CHK	APP	REVISION

AHJ:					PACKAGE #				
DESIGNED BY: D.MILLER			LINE IS 1" AT FULL SCALE	SCALE: 1/16" = 1'-0"	SOUND TRANSIT PRELIMINARY ENGINEERING PLANS OPERATIONS & MAINTENANCE FACILITY SOUTH	DRAWING No.: M10-BPP101			
DRAWN BY: B.DAVIS				FILENAME: OMFS-M10-B-v2022		FACILITY ID: M10			
CHECKED BY: R.HARRISON				CONTRACT No.: AE0030-17		BMS SYSTEMS FLOOR PLAN	SHEET No: REV:		
APPROVED BY: P. LOPEZ-HILFIKER				DATE:					
SUBMITTED BY: PABLO LOPEZ-HILFIKER									
DATE:		REVIEWED BY:		DATE:	SUBMITTAL DATE:				