



02/23/24 | 12:49 PM | MSHEPPARD

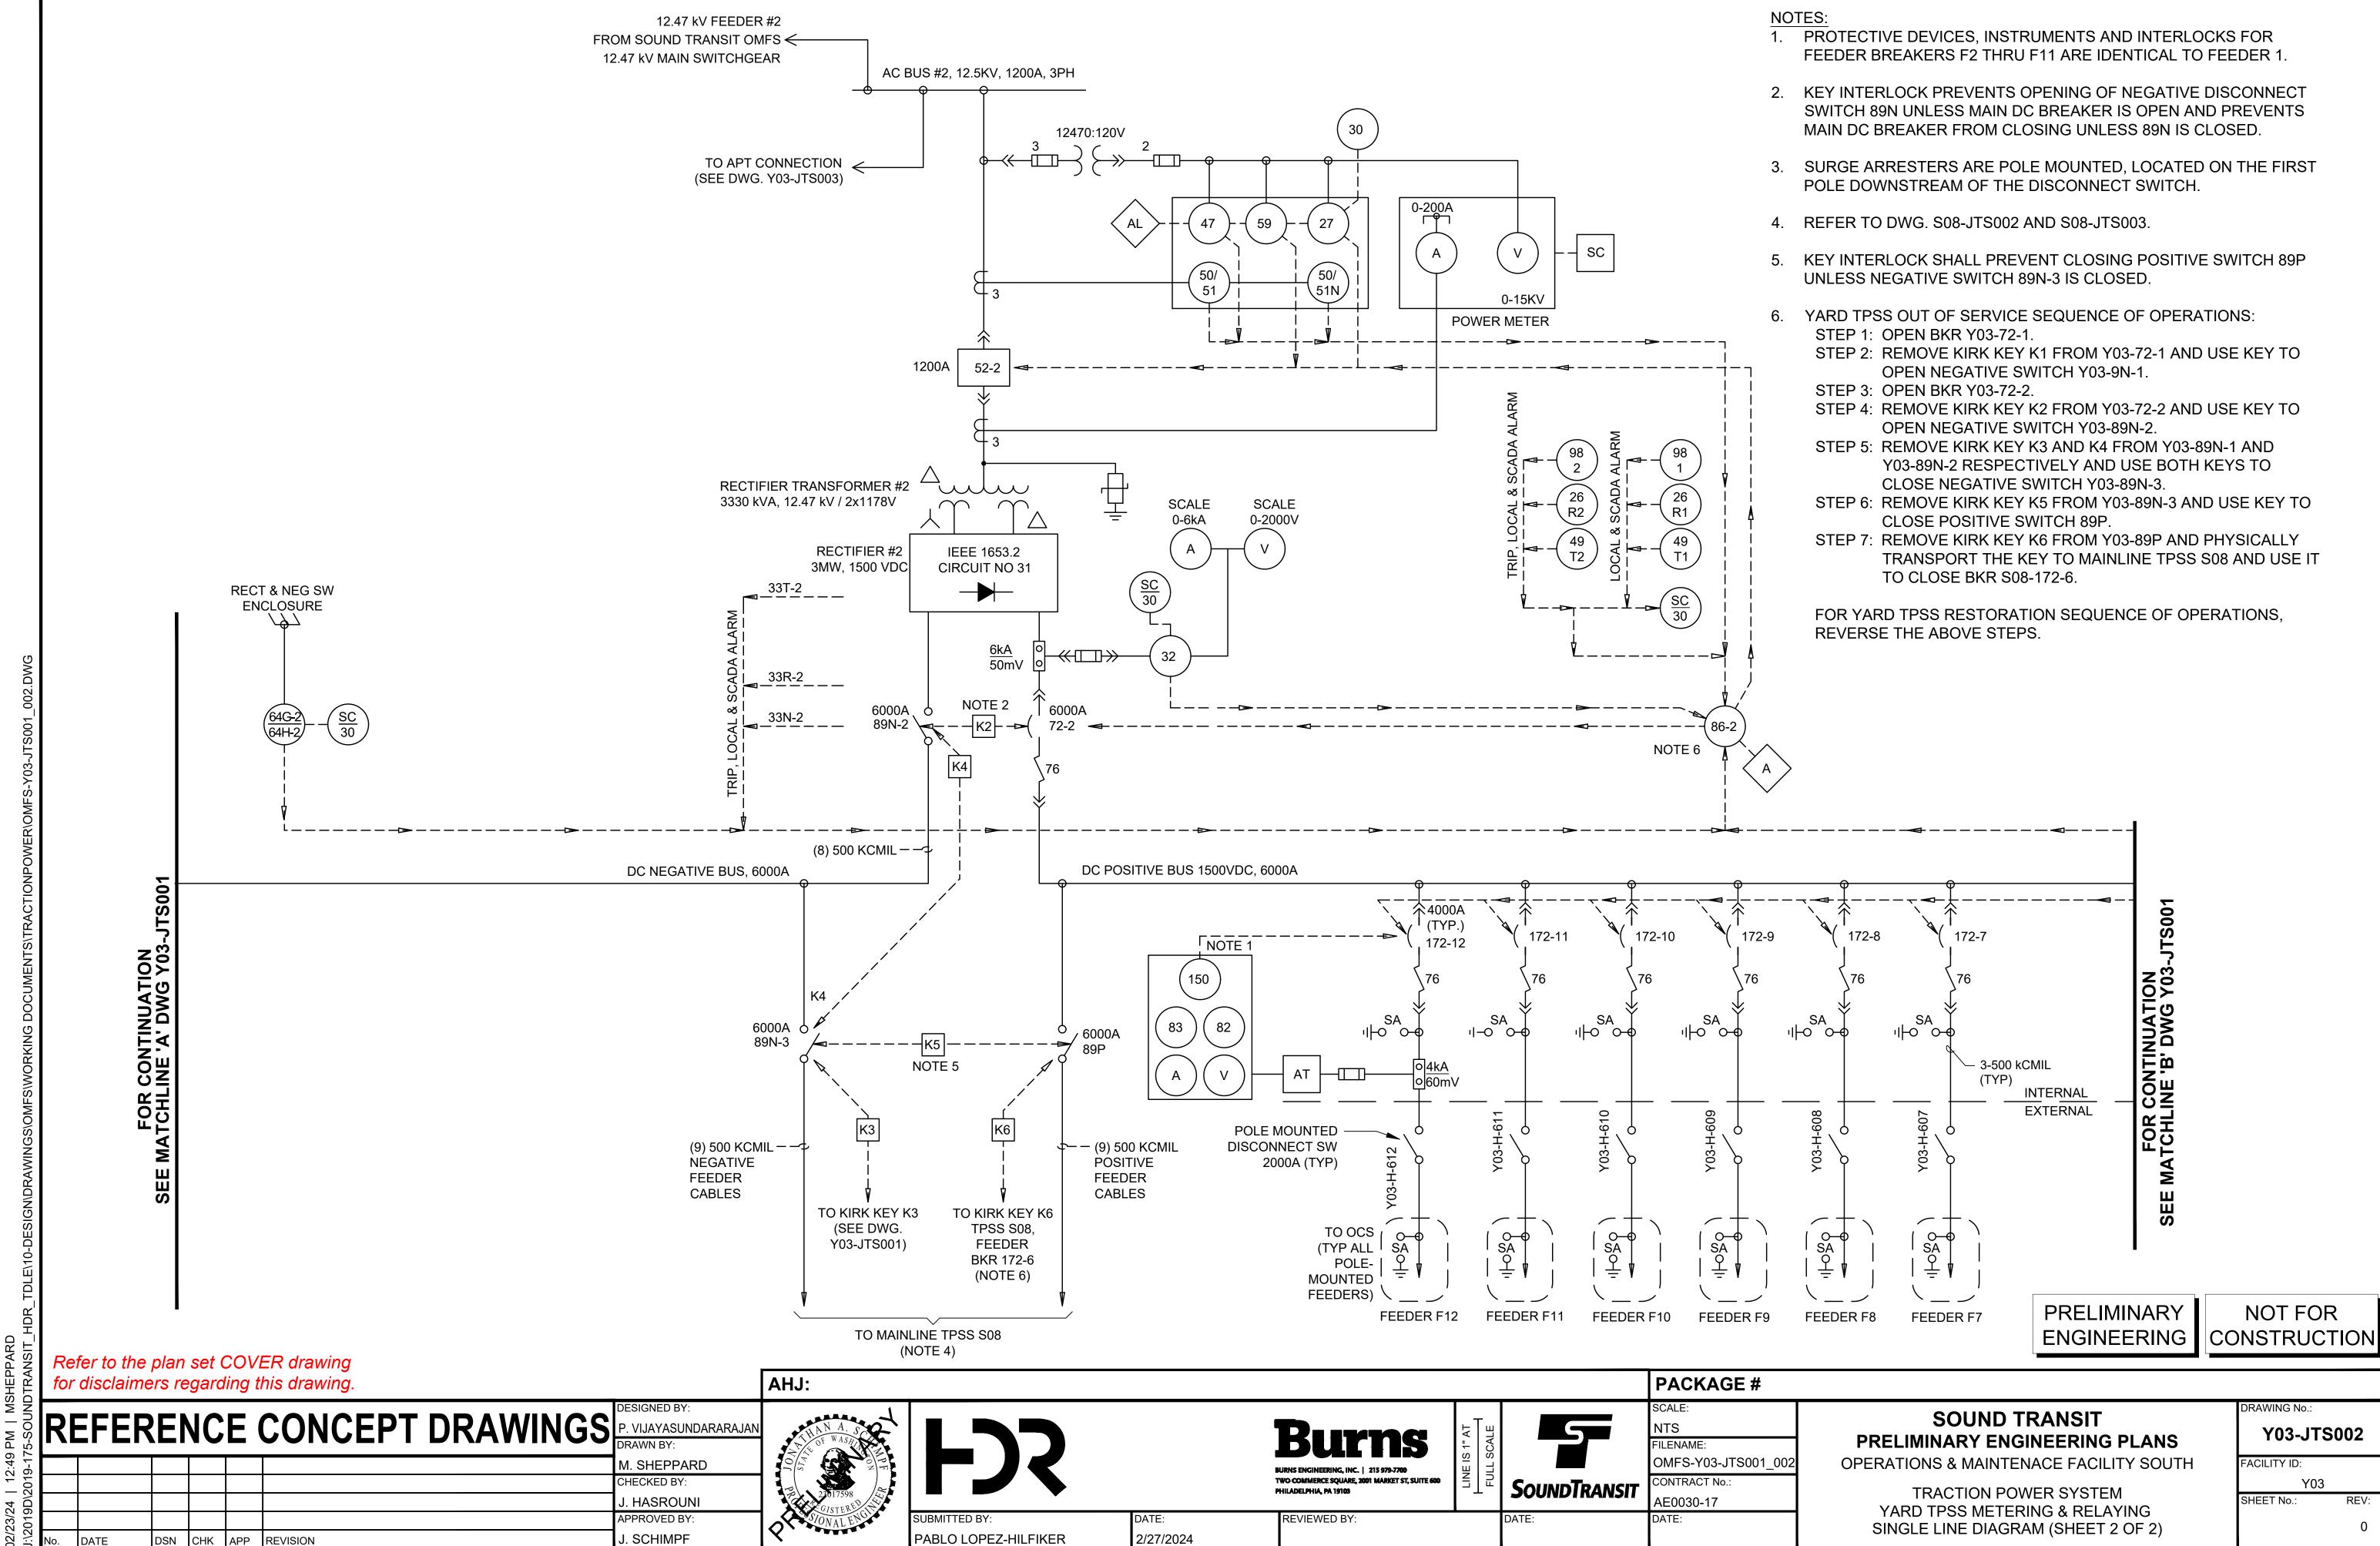

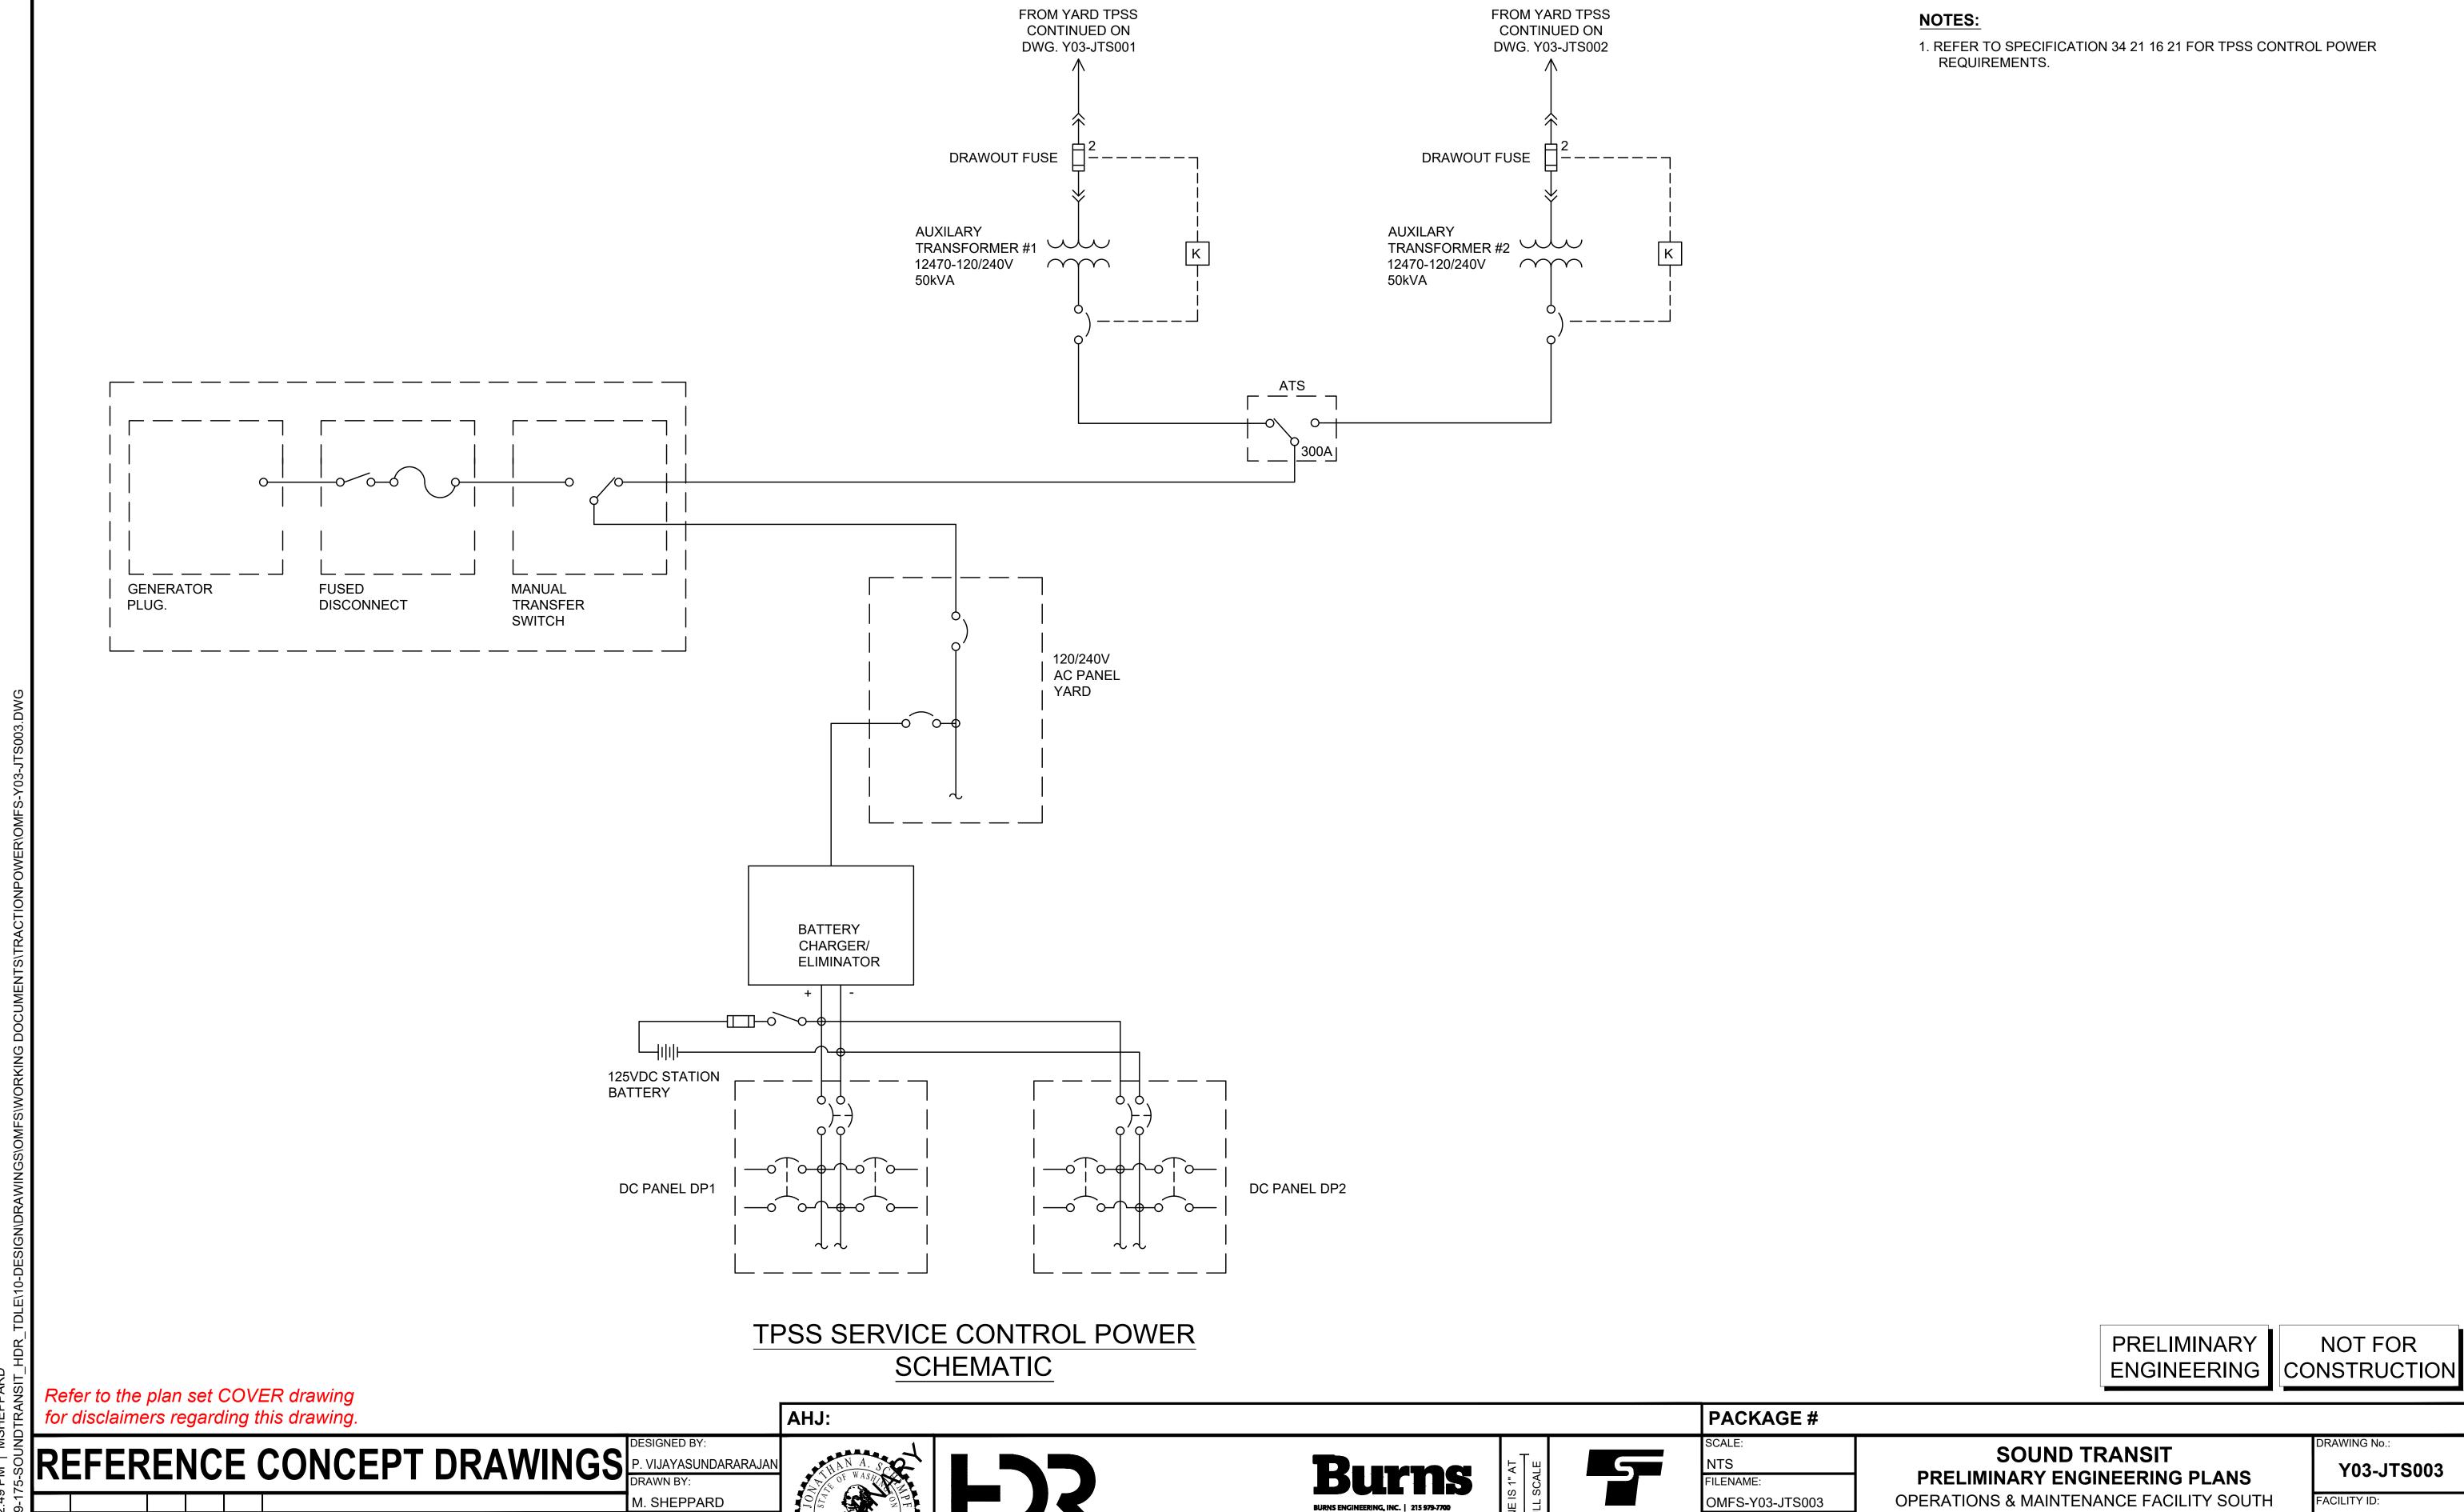

TWO COMMERCE SQUARE, 2001 MARKET ST, SUITE 600

PHILADELPHIA, PA 19103

REVIEWED BY:

2/27/2024

PABLO LOPEZ-HILFIKER

CONTRACT No.:

AE0030-17

SoundTransit

Y03

SHEET No.:

TRACTION POWER SYSTEM


YARD TPSS AUXILARY POWER SCHEMATIC


CHECKED BY:

J. HASROUNI


APPROVED BY

J. SCHIMPF

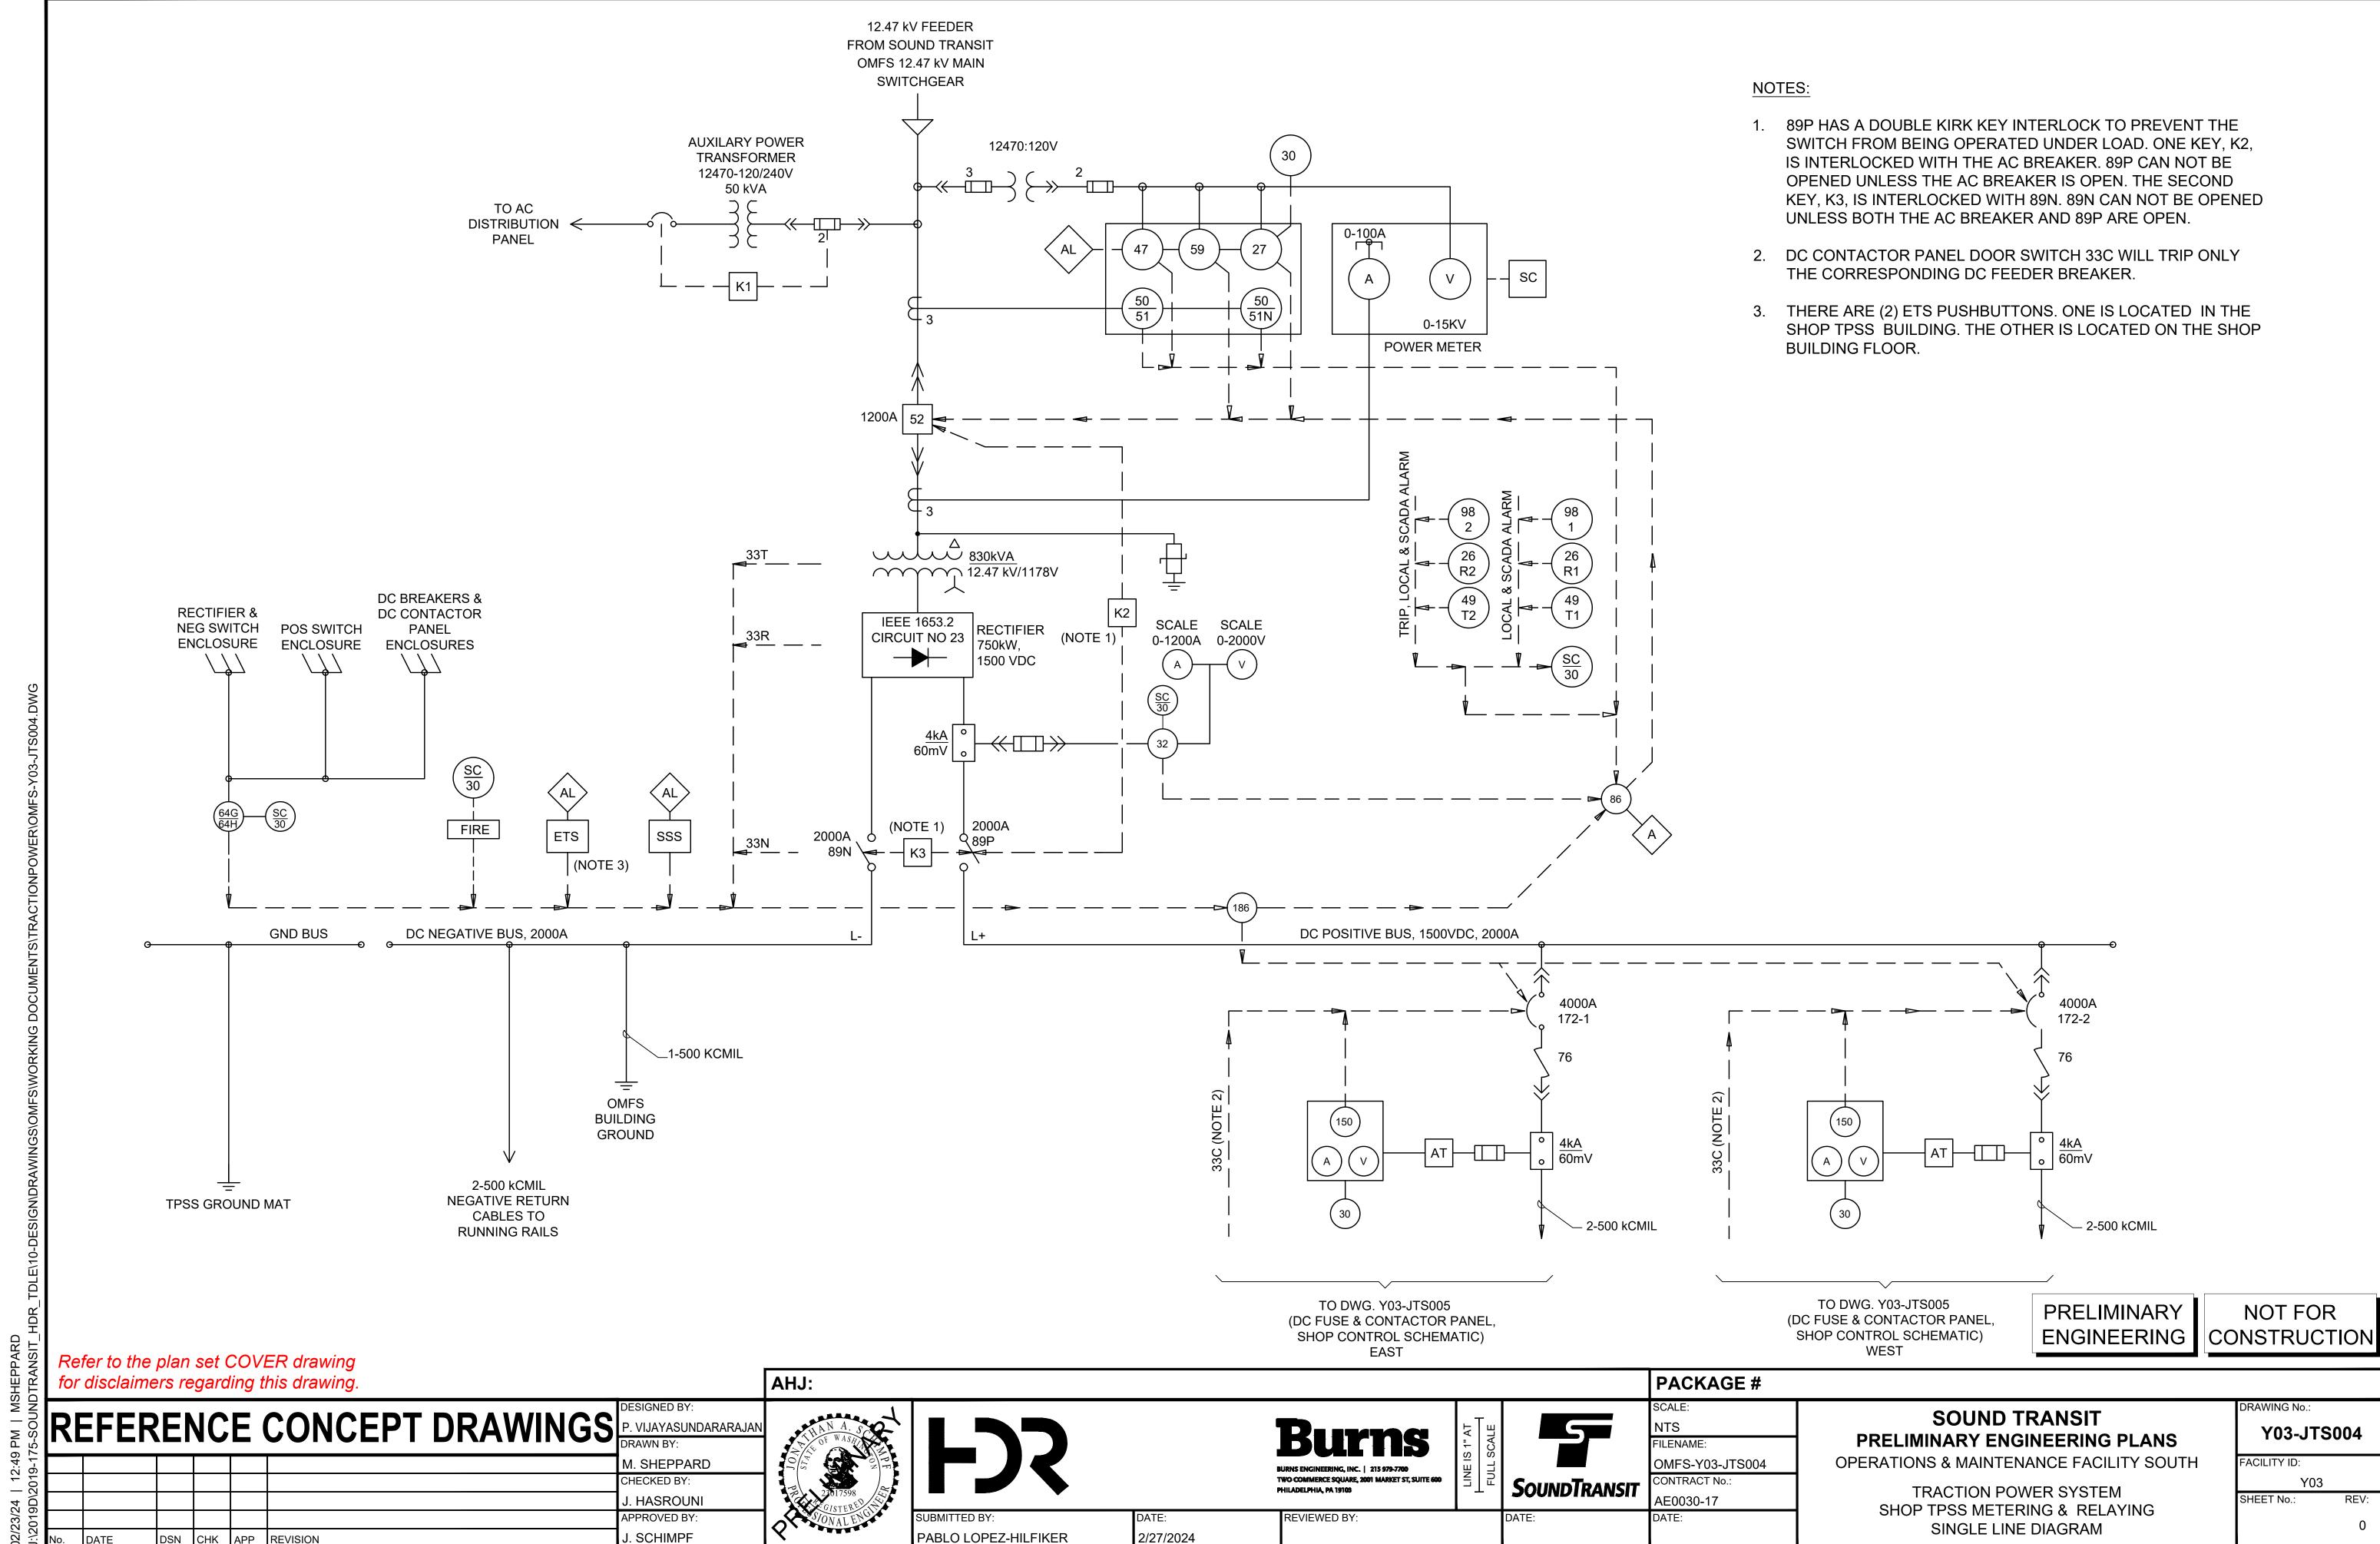

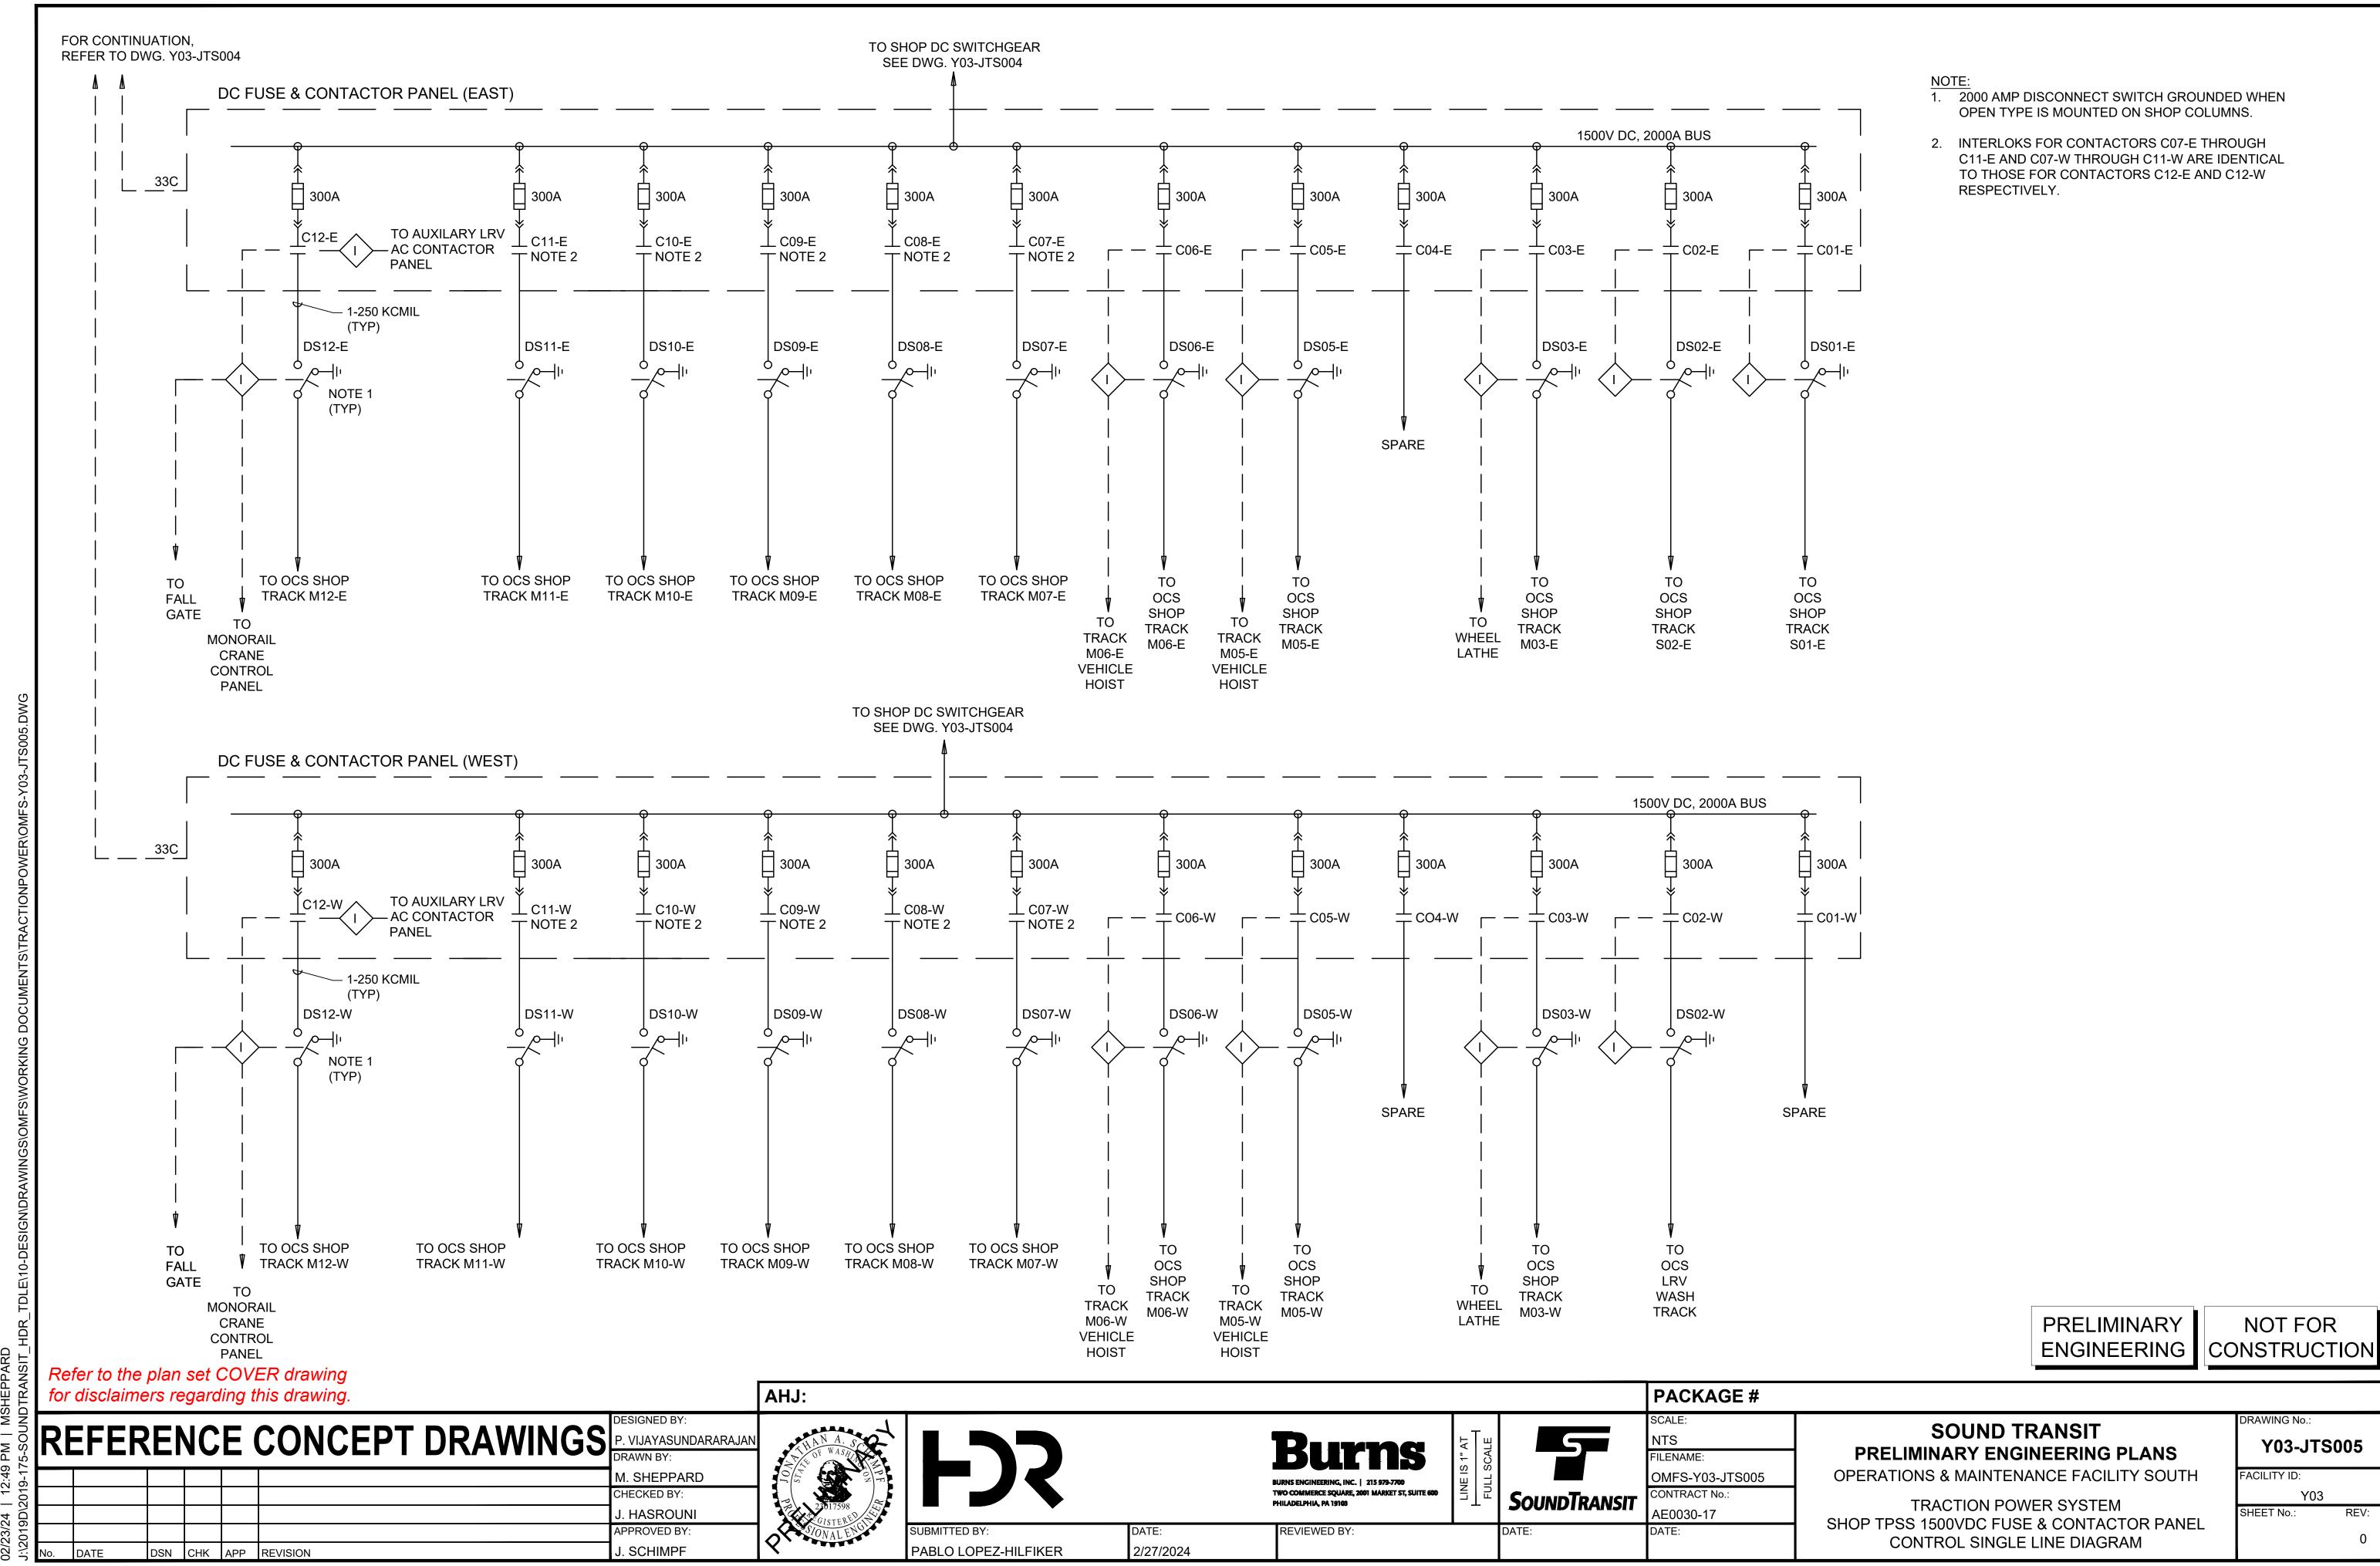

- CONRACTOR SHALL COORDINATE CONDUIT FLOOR PENETRATION LOCATIONS WITH SUBSTATION BUILDING AND FOUNDATION PLANS.
- 2. STAIRS AND LANDING SHALL BE PROVIDED. CONTRACTOR SHALL COORDINATE WITH THE FINAL SITE ELEVATION REQUIREMENTS.
- 3. HATCH COVER SHALL BE RATED TO HANDLE MAXIMUM EQUIPMENT WEIGHT.
- 4. PROVIDE ELECTRICAL INSULATION ON ALL WALLS AND FLOOR IN AREAS SHOWN. IF 6' MINIMUM CANNOT BE ACHEIVED, LINE DOORS, FRAMS AND HARDWARE WITH INSULATION. FLOOR INSULATION TO EXTEND TO ALL WALLS.
- 5. PROVIDE GLASTIC BARRIER BETWEEN TRACTION POWER TRANSFORMER AND RECTIFIER. ENSURE BARRIER CAN PROVIDE AT LEAST 2'-6" CLEARANCE.
- 6. COORDINATE BUILDING DIMENSIONS AND EQUIPMENT LOADINGS WITH STRUCTURAL ENGINEER.

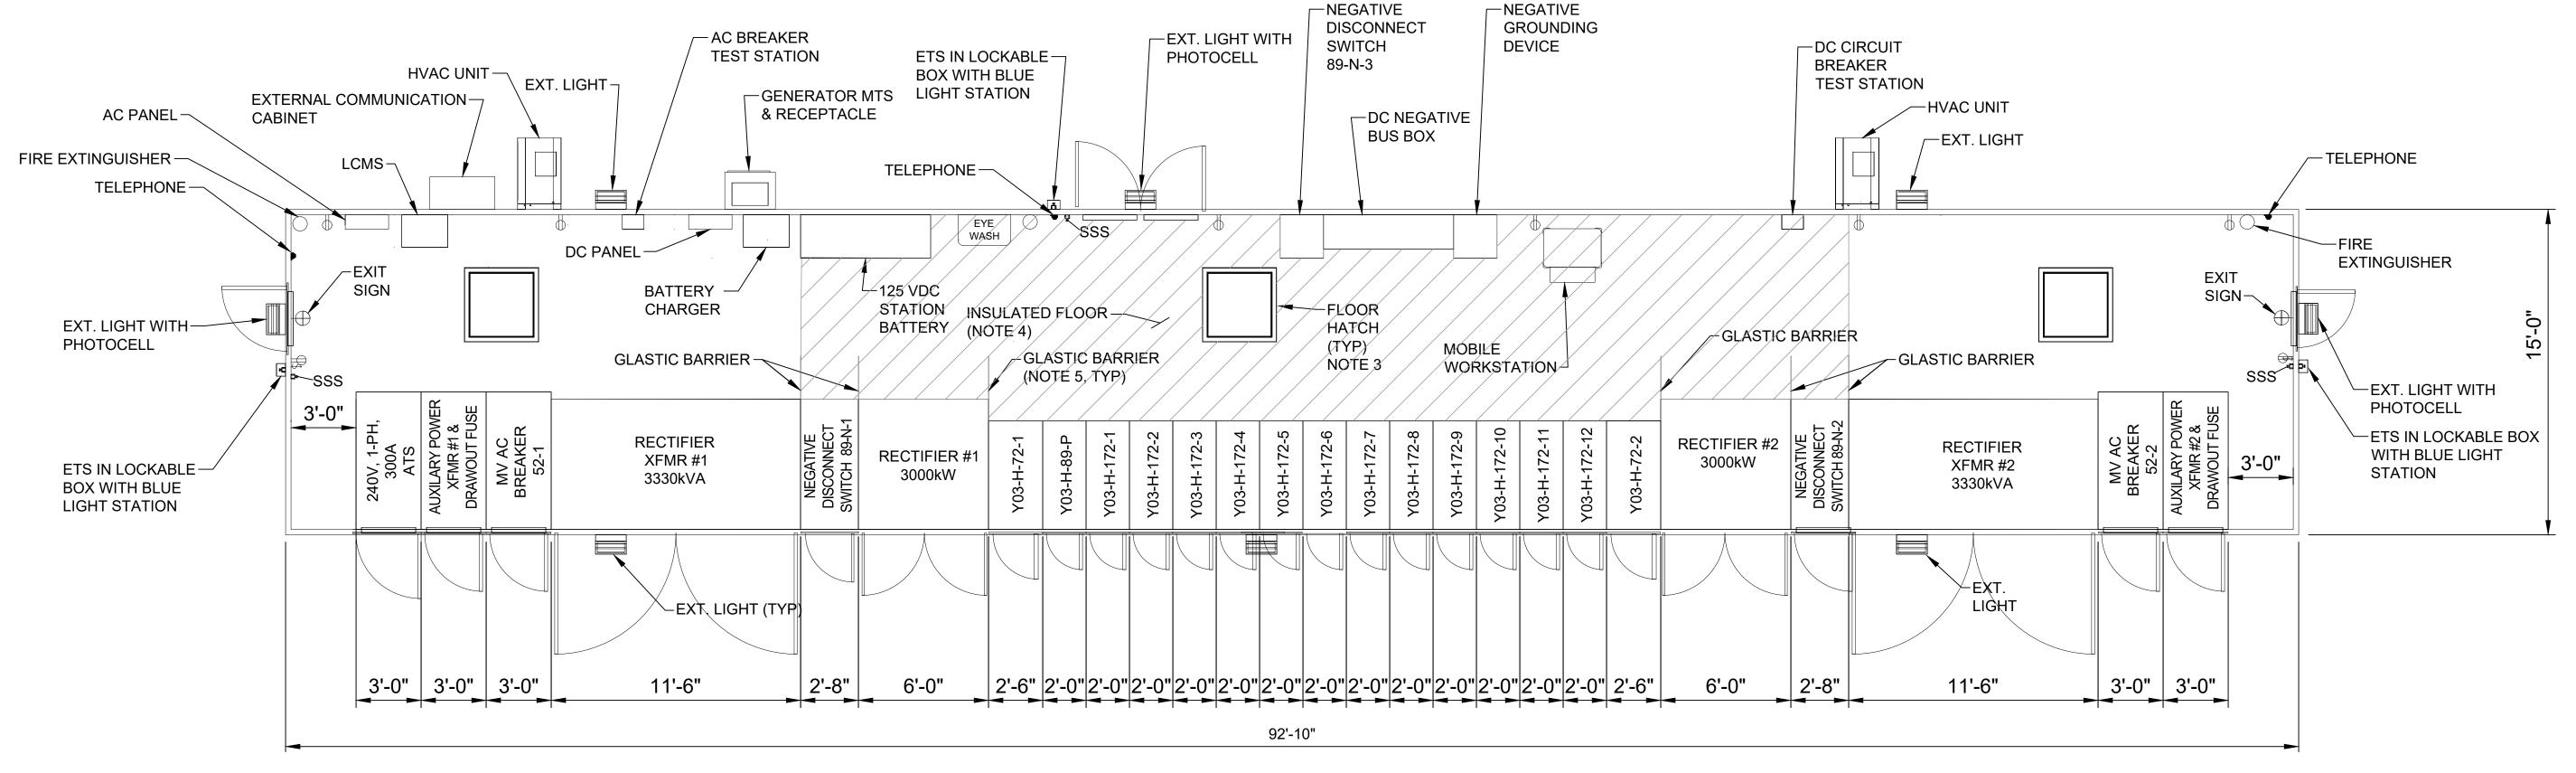


YARD TPSS EQUIPMENT LAYOUT - PLAN

PRELIMINARY ENGINEERING

NOT FOR CONSTRUCTION

Refer to the plan set COVER drawing for disclaimers regarding this drawing.

REFERENCE CONCEPT DRAWINGS P. VIJAYASUNDARARAJAN DRAWN BY:							
						M. SHEPPARD	
						CHECKED BY:	
						J. HASROUNI	
						APPROVED BY:	L
lo	DATE	DSN	СНК	ΔΡΡ	REVISION	J. SCHIMPF	ľ

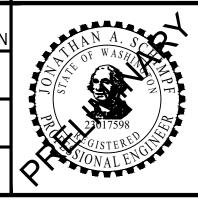

AHJ:

EUBMITTED BY:

PABLO LOPEZ-HILFIKER

BURNS ENGINEERING, INC. | 215 979-7700
TWO COMMERCE SQUARE, 2001 MARKET ST, SUITE 600
PHILADELPHIA, PA 19103

DATE:

REVIEWED BY:

2/27/24

SoundTransit

PACKAGE #

SCALE:

3/8" = 1'-0"

FILENAME:

OMFS-Y03-JTP101

CONTRACT No.:

AE0030-17

SOUND TRANSIT
PRELIMINARY ENGINEERING PLANS
OPERATIONS & MAINTENACE FACILITY SOUTH

TRACTION POWER SYSTEM
YARD TPSS EQUIPMENT LAYOUT PLAN

PRAWING No.:


Y03-JTP101

FACILITY ID:

Y03 SHEET No.:

- 1. PROVIDE REMOVABLE TRANSOM AND WALL PANEL ABOVE DOOR.
- 2. COMM TO DETERMINE FINAL LOCATION AND SIZE.
- 3. MOUNT CAMERAS AND CASES TO TPSS FOR WATER TEST AND REMOVE FOR SHIPMENT. REINSTALL AT SITE.
- 4. COORDINATE BUILDING DIMENSIONS AND EQUIPMENT LOADINGS WITH STRUCTURAL ENGINEER.
- 5. PROVIDE ELECTRICAL INSULATION ON ALL WALLS AND FLOOR IN AREAS SHOWN. IF 6' MINIMUM CANNOT BE ACHEIVED, LINE DOORS, FRAMS AND HARDWARE WITH INSULATION. FLOOR INSULATION TO EXTEND TO ALL 3 WALLS.
- 6. PROVIDE GLASTIC BARRIER BETWEEN RECTIFIER TRANSFORMER AND RECTIFIER. EXTEND GLASTIC 2'-6" BEYOND RECTIFIER TRANSFORMER, AS SHOWN. PROVIDE AN INSULATED FINISHED EDGE ON EXPOSED GLASTIC EDGE.

- 7. PROVIDE GLASTIC BARIER INSIDE REAR DOOR TO COMPLETE WALL INSULATION WHEN DOOR IS CLOSED.
- 8. HVAC UNIT LAYOUT IS FOR REFERENCE ONLY.
- 9. HATCH COVER SHALL BE RATED TO HANDLE MAXIMUM EQUIPMENT
- 10. PROVIDE STAIRS AND LANDINGS.
- 11. PROVIDE CONTINUOUS GROUND BUS AROUND ENTIRE TPSS.
- 12. LOCATE AND SIZE PULLBOX TO SUIT SITE CONDITIONS.
- 13. DC CONTACTOR PANEL CONSISTS OF 24 CONTACTORS ARRANGED IN TOP AND BOTTOM ROWS.
- 14. SIZE AND LOCATION OF FLOOR CUTOUTS FOR DC CABLE ENTRANCES TO BE DETERMINED BY THE CONTRACTOR.

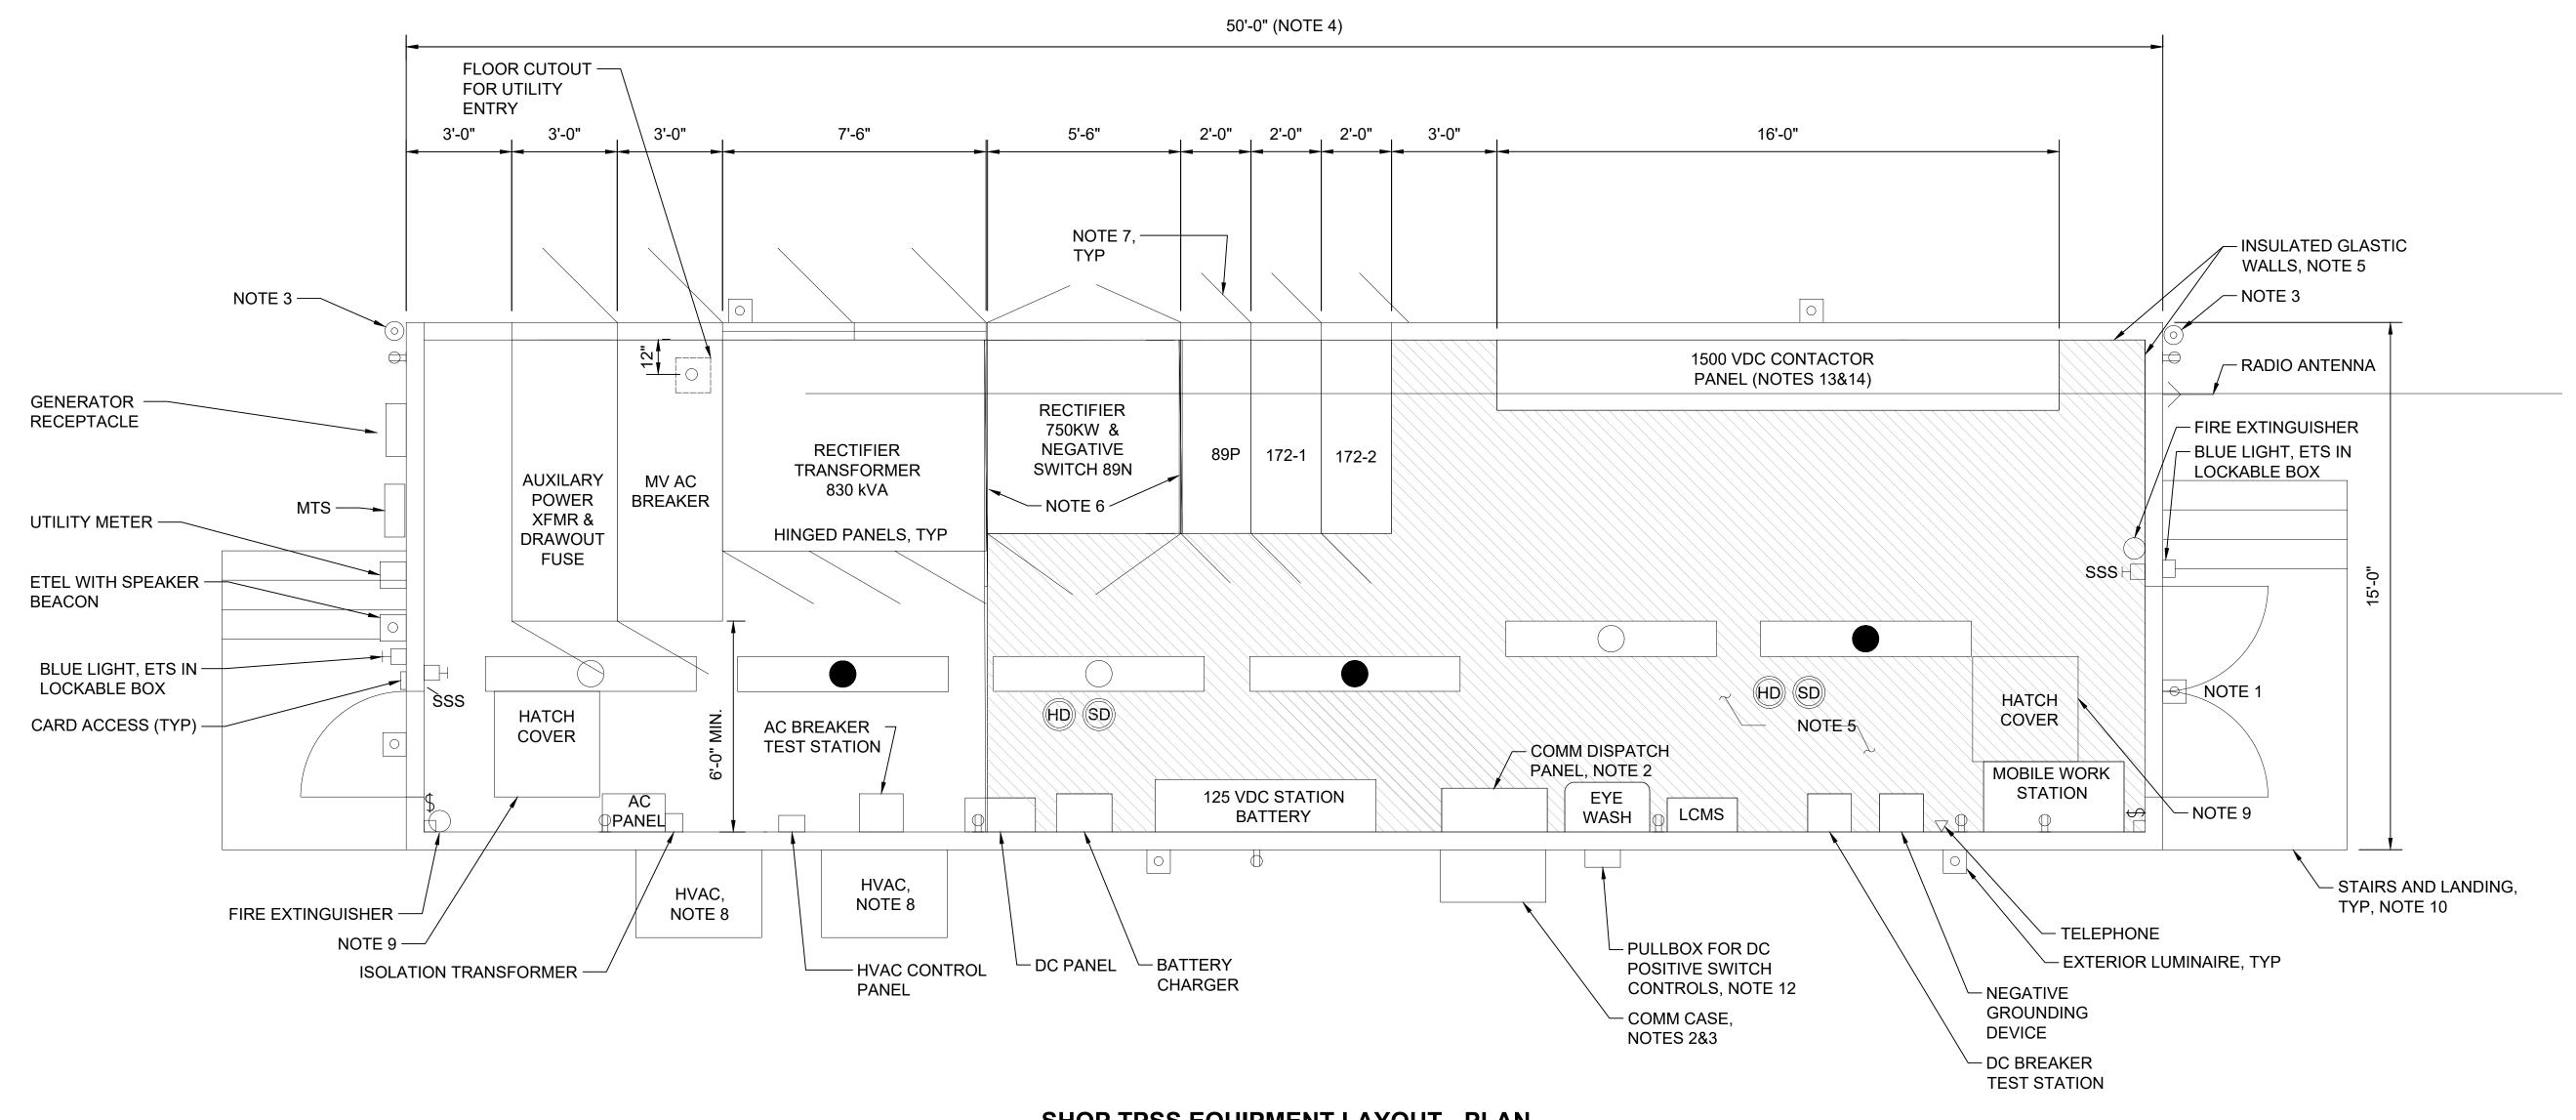

SHOP TPSS EQUIPMENT LAYOUT - PLAN

PRELIMINARY ENGINEERING

NOT FOR CONSTRUCTION

Refer to the plan set COVER drawing for disclaimers regarding this drawing.

CHK APP REVISION

REFERENCE CONCEPT DRAWINGS P. VIJAYASUNDARARAJAN DRAWN BY: M. SHEPPARD CHECKED BY

AHJ:

I. HASROUNI

APPROVED BY

I. SCHIMPF

PABLO LOPEZ-HILFIKER

Burns PHILADELPHIA, PA 19103

5 ILENAME:

3/8" = 1'-0" OMFS-Y03-JTP102


PACKAGE #

SOUND TRANSIT PRELIMINARY ENGINEERING PLANS **OPERATIONS & MAINTENANCE FACILITY SOUTH** TRACTION POWER SYSTEM


Y03-JTP102 FACILITY ID: Y03 SHEET No.:

RAWING No.:

TWO COMMERCE SQUARE, 2001 MARKET ST, SUITE 600 CONTRACT No.: SoundTransit AE0030-17 SHOP TPSS EQUIPMENT REVIEWED BY: LAYOUT PLAN 2/27/24

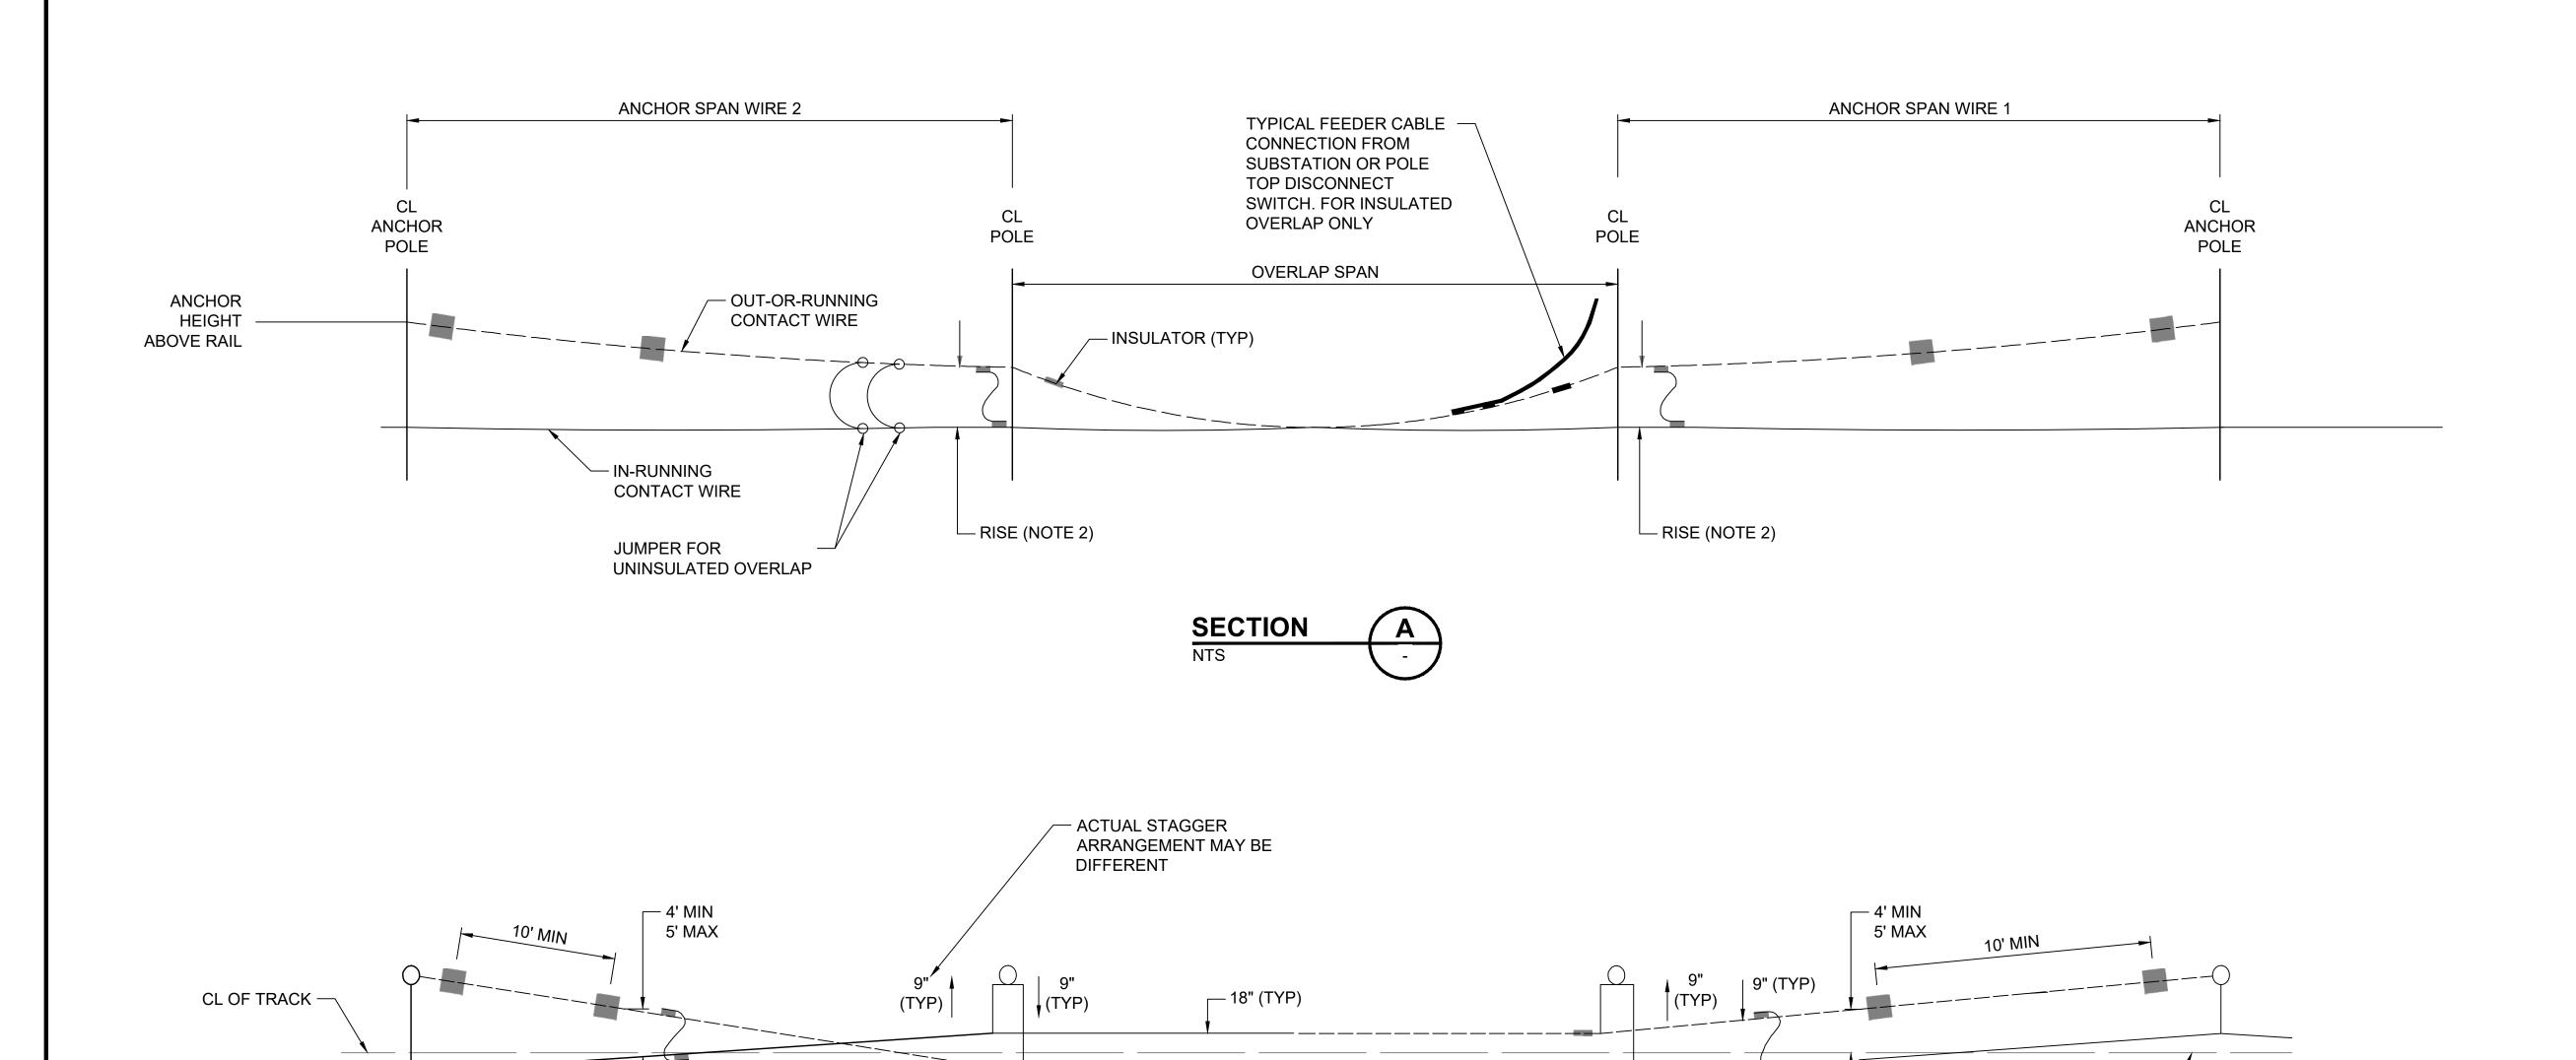

- 1. WHEN TRACK CURVATURE REQUIRES SPANS SHORTER THAN 70', USE TWO SPANS TO DEVELOP INSULATED OVERLAP WITH INSULATED KNUCKLE AND REGISTRATION IN THE MIDDLE, AND THE OVERLAPPING CONTACT WIRES 12 INCHES MINIMUM APART. FOR INSULATED OVERLAPS AND 4" MINIMUM FOR UNINSULATED OVERLAP.
- 2. RISE SHALL BE MINIMUM 6", MAXIMUM 14". RISE SHALL BE FIELD ADJUSTED TO CAUSE THE MID SPAN WIRE HEIGHT TO BE EQUAL, AND TO BE THE AVERAGE OF ADJACENT TWO INRUNNING CONTACT WIRE HEIGHTS.
- 3. STAGGER VALUES ARE TYPICAL. SITE SPECIFIC VALUES SHALL BE IN ACCORDANCE WITH MAXIMUM STAGGER CRITERIA. FOR ACTUAL OVERLAP ARRANGEMENT AND STAGGER SEE OCS LAYOUT SCHEDULES.
- 4. WHERE VERTICAL CLEARANCE BETWEEN THE UNDERSIDE OF THE INSULATOR AND IN-RUNNING WIRE HEIGHT IS LESS THAN 6", A NOBO INSULATOR SHALL BE INSTALLED.

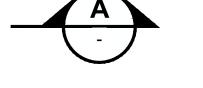

OVERLAP ARRANGEMENT FOR SINGLE CONTACT WIRE TO SINGLE CONTACT WIRE TANGENT TRACK

2/27/2024

NOT FOR CONSTRUCTION

for disclaimers regarding this drawing. AHJ: **DESIGNED BY** REFERENCE CONCEPT DRAWINGS M. RAMOS DRAWN BY: M. CLEMENT **CHECKED BY** R. DEMERS APPROVED BY

M. RAMOS

Refer to the plan set COVER drawing

PABLO LOPEZ-HILFIKER

☐ INSULATORS (TYP)

REVIEWED BY:

- JUMPER TYPE JC-1 FOR INSULATED OVERLAP

ONLY (TYP)

5 SoundTransit

CL OF TRACK

FILENAME: OMFS-M08-JOY021 CONTRACT No.: AE-0030-17

2/27/2024

PACKAGE #

SOUND TRANSIT PRELIMINARY ENGINEERING PLANS **OPERATIONS & MAINTENANCE FACILITY SOUTH**


OVERHEAD CONTACT SYSTEMS SINGLE CROSSOVER - YARD

RAWING No.: M08-JOY050

M08 SHEET No.:

FACILITY ID:

- FOR SYMBOLS, ABBREVIATIONS AND GENERAL NOTES SEE ST DIRECTIVE DRAWINGS JZN001 - JZN007.
- 2. CONTRACTOR TO DETERMINE POLE BRACKET HEIGHTS.
- 3. SECOND LEVEL INSULATION ADJACENT TO POLE SHALL BE LOCATED 10' FROM TRACK CENTERLINE. EXCEPT IN CASES WHERE POLE FACE SETOUT IS LESS THAN 11'-3", A MINIMUM OF 1'-3" FROM FACE OF POLE IS REQUIRED.
- 4. CONTRACTOR TO ENSURE THAT PANTOGRAPH CLEARANCE AND STEADY ARM CLEARANCE REQUIREMENTS OF ST DIRECTIVE DRAWINGS JOD110 JOD112 AND ELECTRICAL CLEARANCE REQUIREMENTS ARE MET.

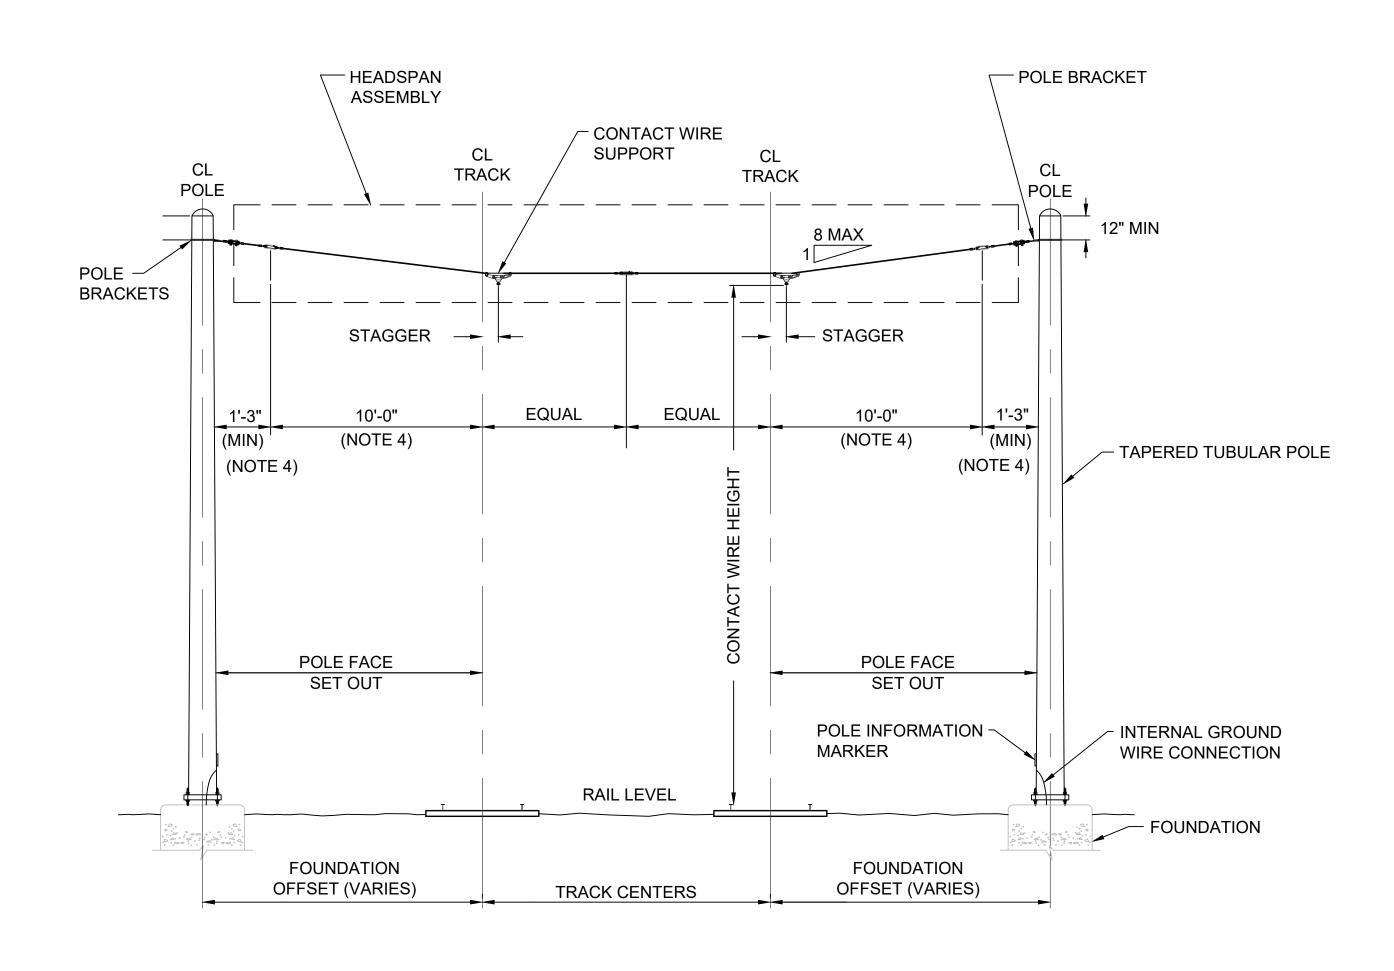

SINGLE CONTACT SINGLE CONTACT SINGLE CONTACT MEDIUM LOAD **HEAVY LOAD** LIGHT LOAD **REGISTRATION ASSY REGISTRATION ASSY** REGISTRATION ASSY TAPERED TUBULAR CL POLE POLE POLE **HEADSPAN ASSEMBLY** 4 MAX 12" MIN POLE BRACKETS → STAGGER STAGGER STAGGER CONTACT **EQUAL** 1'-3" (MIN) **EQUAL** 10'-0" 10'-0" 1'-3" (MIN) WIRE (NOTE 4) (NOTE 4) (NOTE 4) (NOTE 4) CONTACT WIRE HEIGHT — TAPERED TUBULAR POLE POLE FACE SETOUT POLE FACE SETOUT /- POLE INTERNAL POLE-GROUND INFORMATION INFORMATION INTERNAL GROUND CONNECTION MARKER MARKER CONNECTION RAIL LEVEL FOUNDATION FOUNDATION OFFSET FOUNDATION TRACK SEPARATION TRACK SEPARATION FOUNDATION OFFSET TRACK 1 TRACK 2 TRACK 3


TWO TRACK CROSS SPAN ARRANGEMENT 1

MULTI-TRACK HEADSPAN ARRANGEMENT 2

NOT FOR CONSTRUCTION

Refer to the plan set COVER drawing PACKAGE # for disclaimers regarding this drawing. AHJ: RAWING No.: **DESIGNED BY SOUND TRANSIT** REFERENCE CONCEPT DRAWINGS 5 M. RAMOS M08-JOY020 PRELIMINARY ENGINEERING PLANS DRAWN BY: ILENAME: **OPERATIONS & MAINTENANCE FACILITY SOUTH** M. CLEMENT OMFS-M08-JOY023 FACILITY ID: CHECKED BY: CONTRACT No. M08 SoundTransit OVERHEAD CONTACT SYSTEMS AE-0030-17 R. DEMERS SHEET No.: MULTI-TRACK HEADSPAN - YARD APPROVED BY REVIEWED BY: 2/27/2024 2/27/2024 PABLO LOPEZ-HILFIKER M. RAMOS CHK APP REVISION

/24 | 12:46 PM | MACLEMENT WYORKING\WEST01\D2772713\OMFS-M08-.IOY023 DWG

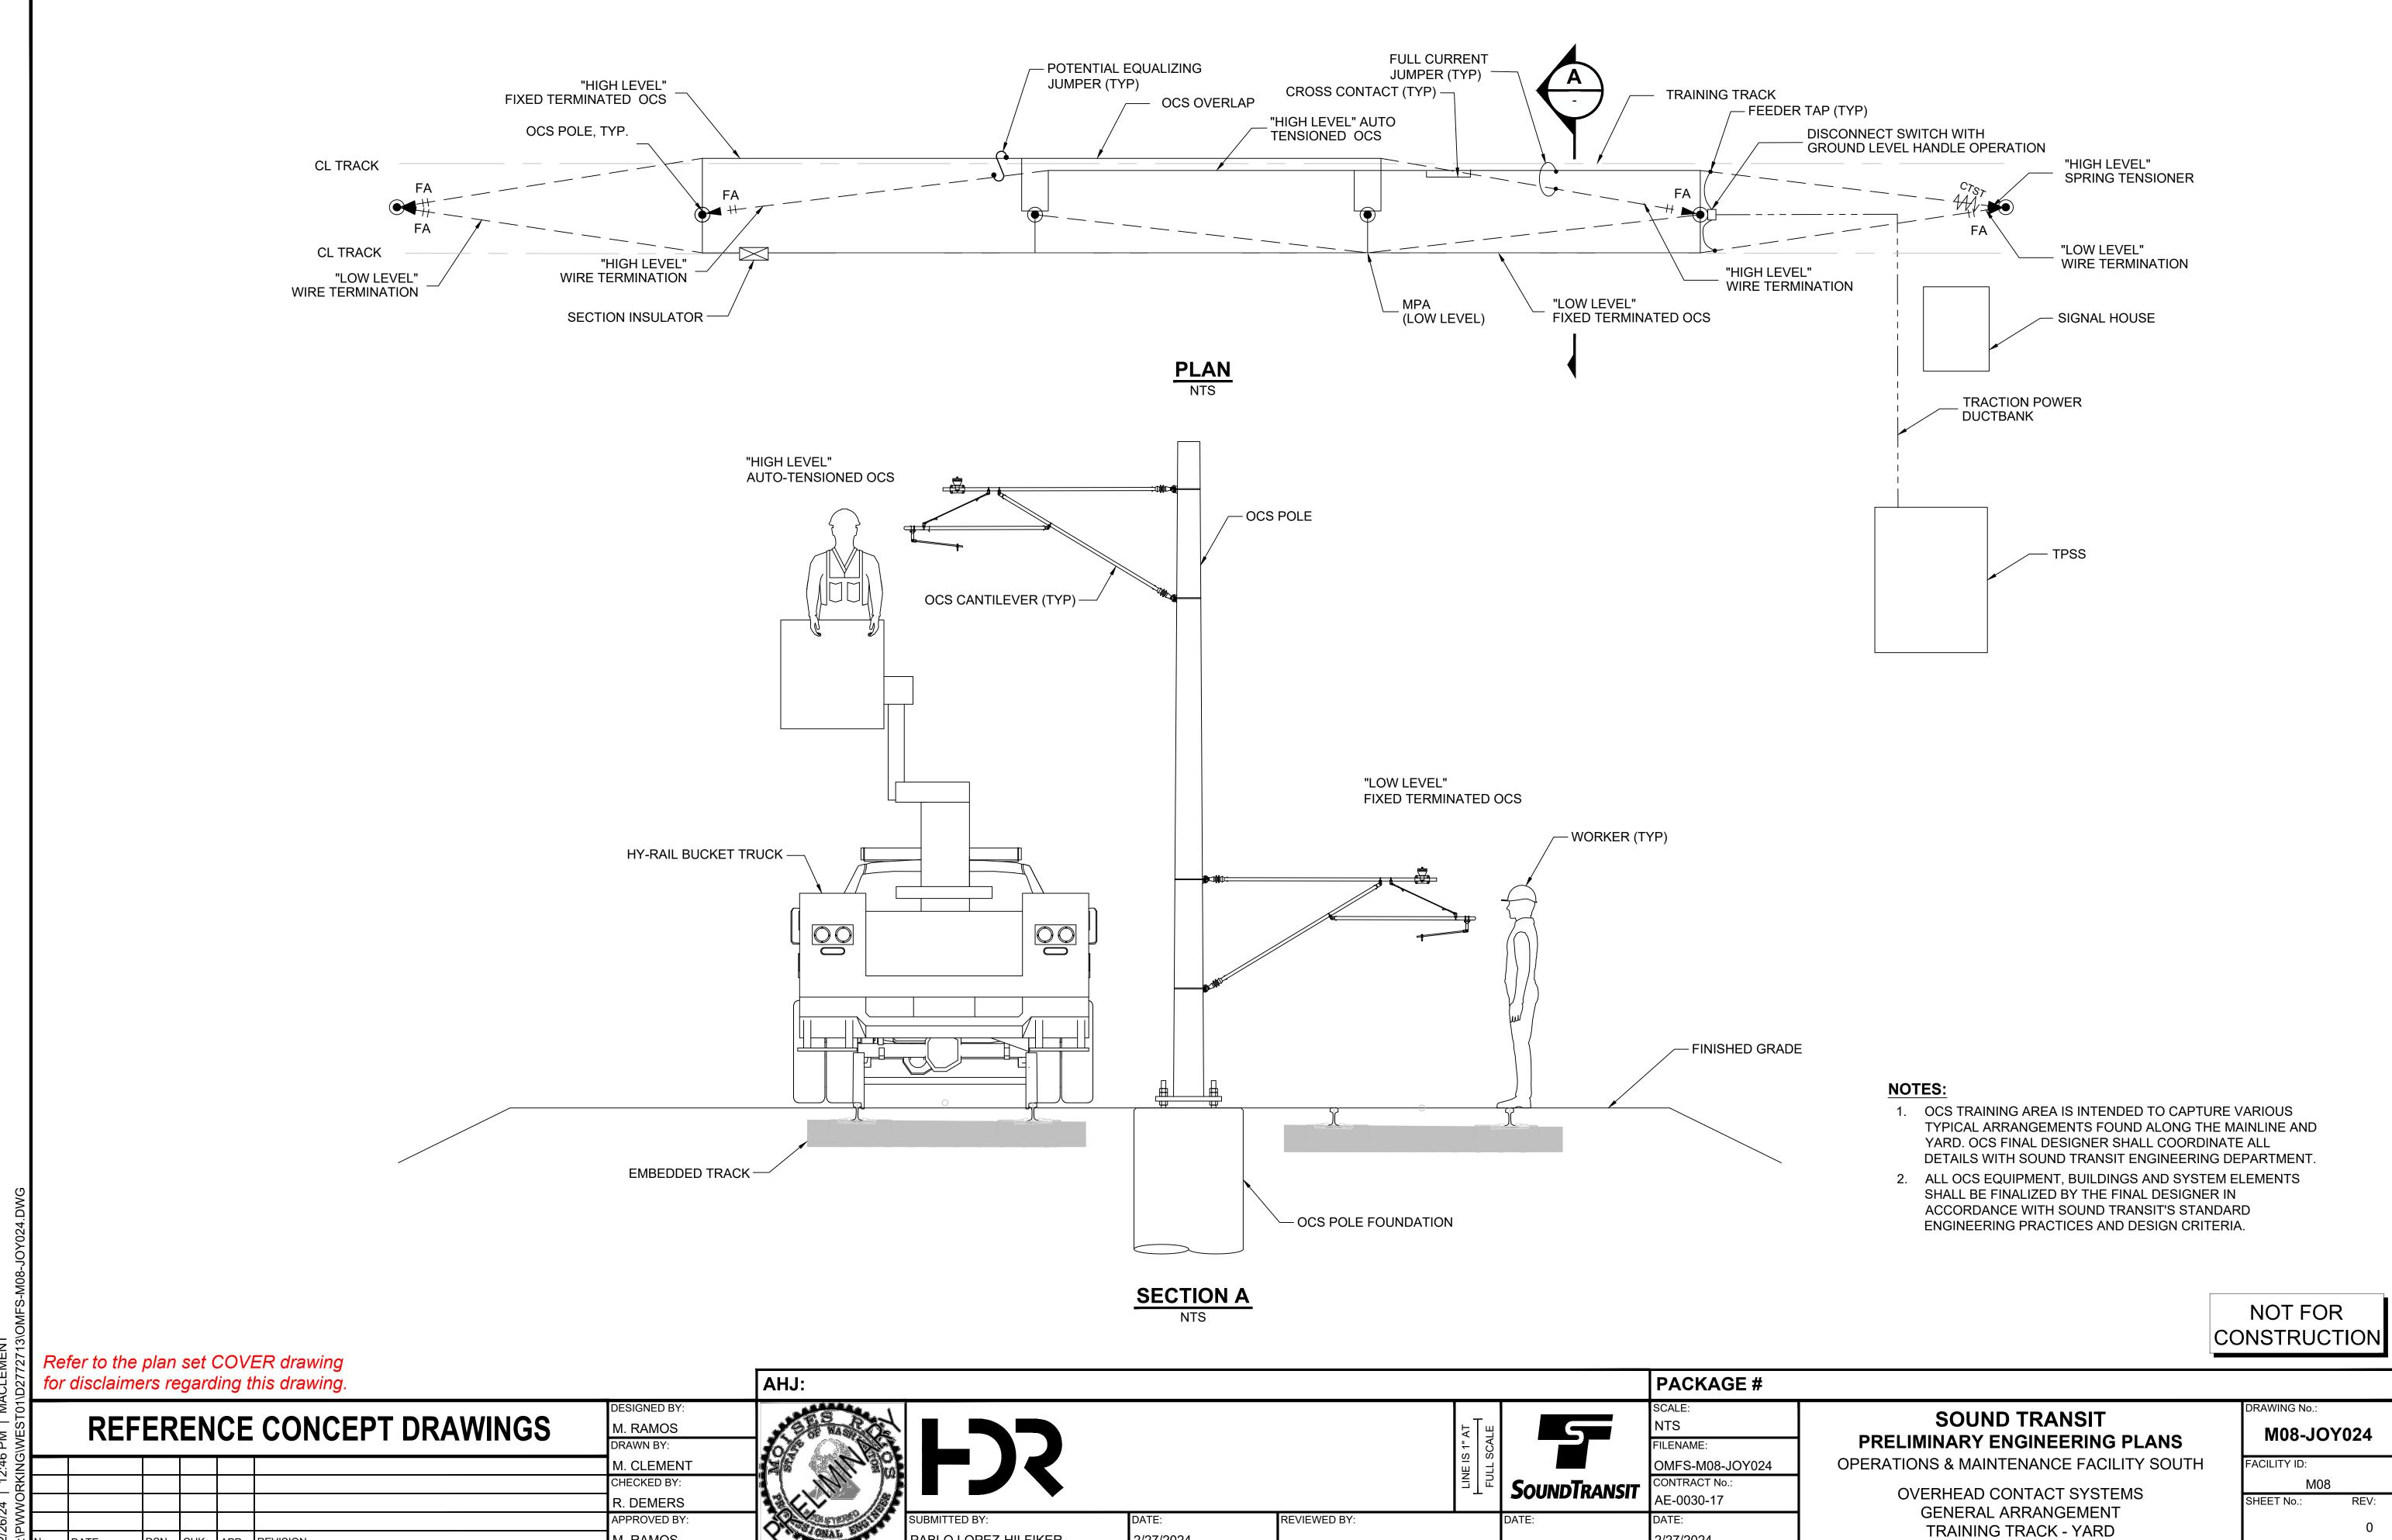


PABLO LOPEZ-HILFIKER

M. RAMOS

2/27/2024

2/27/2024

CHK APP REVISION

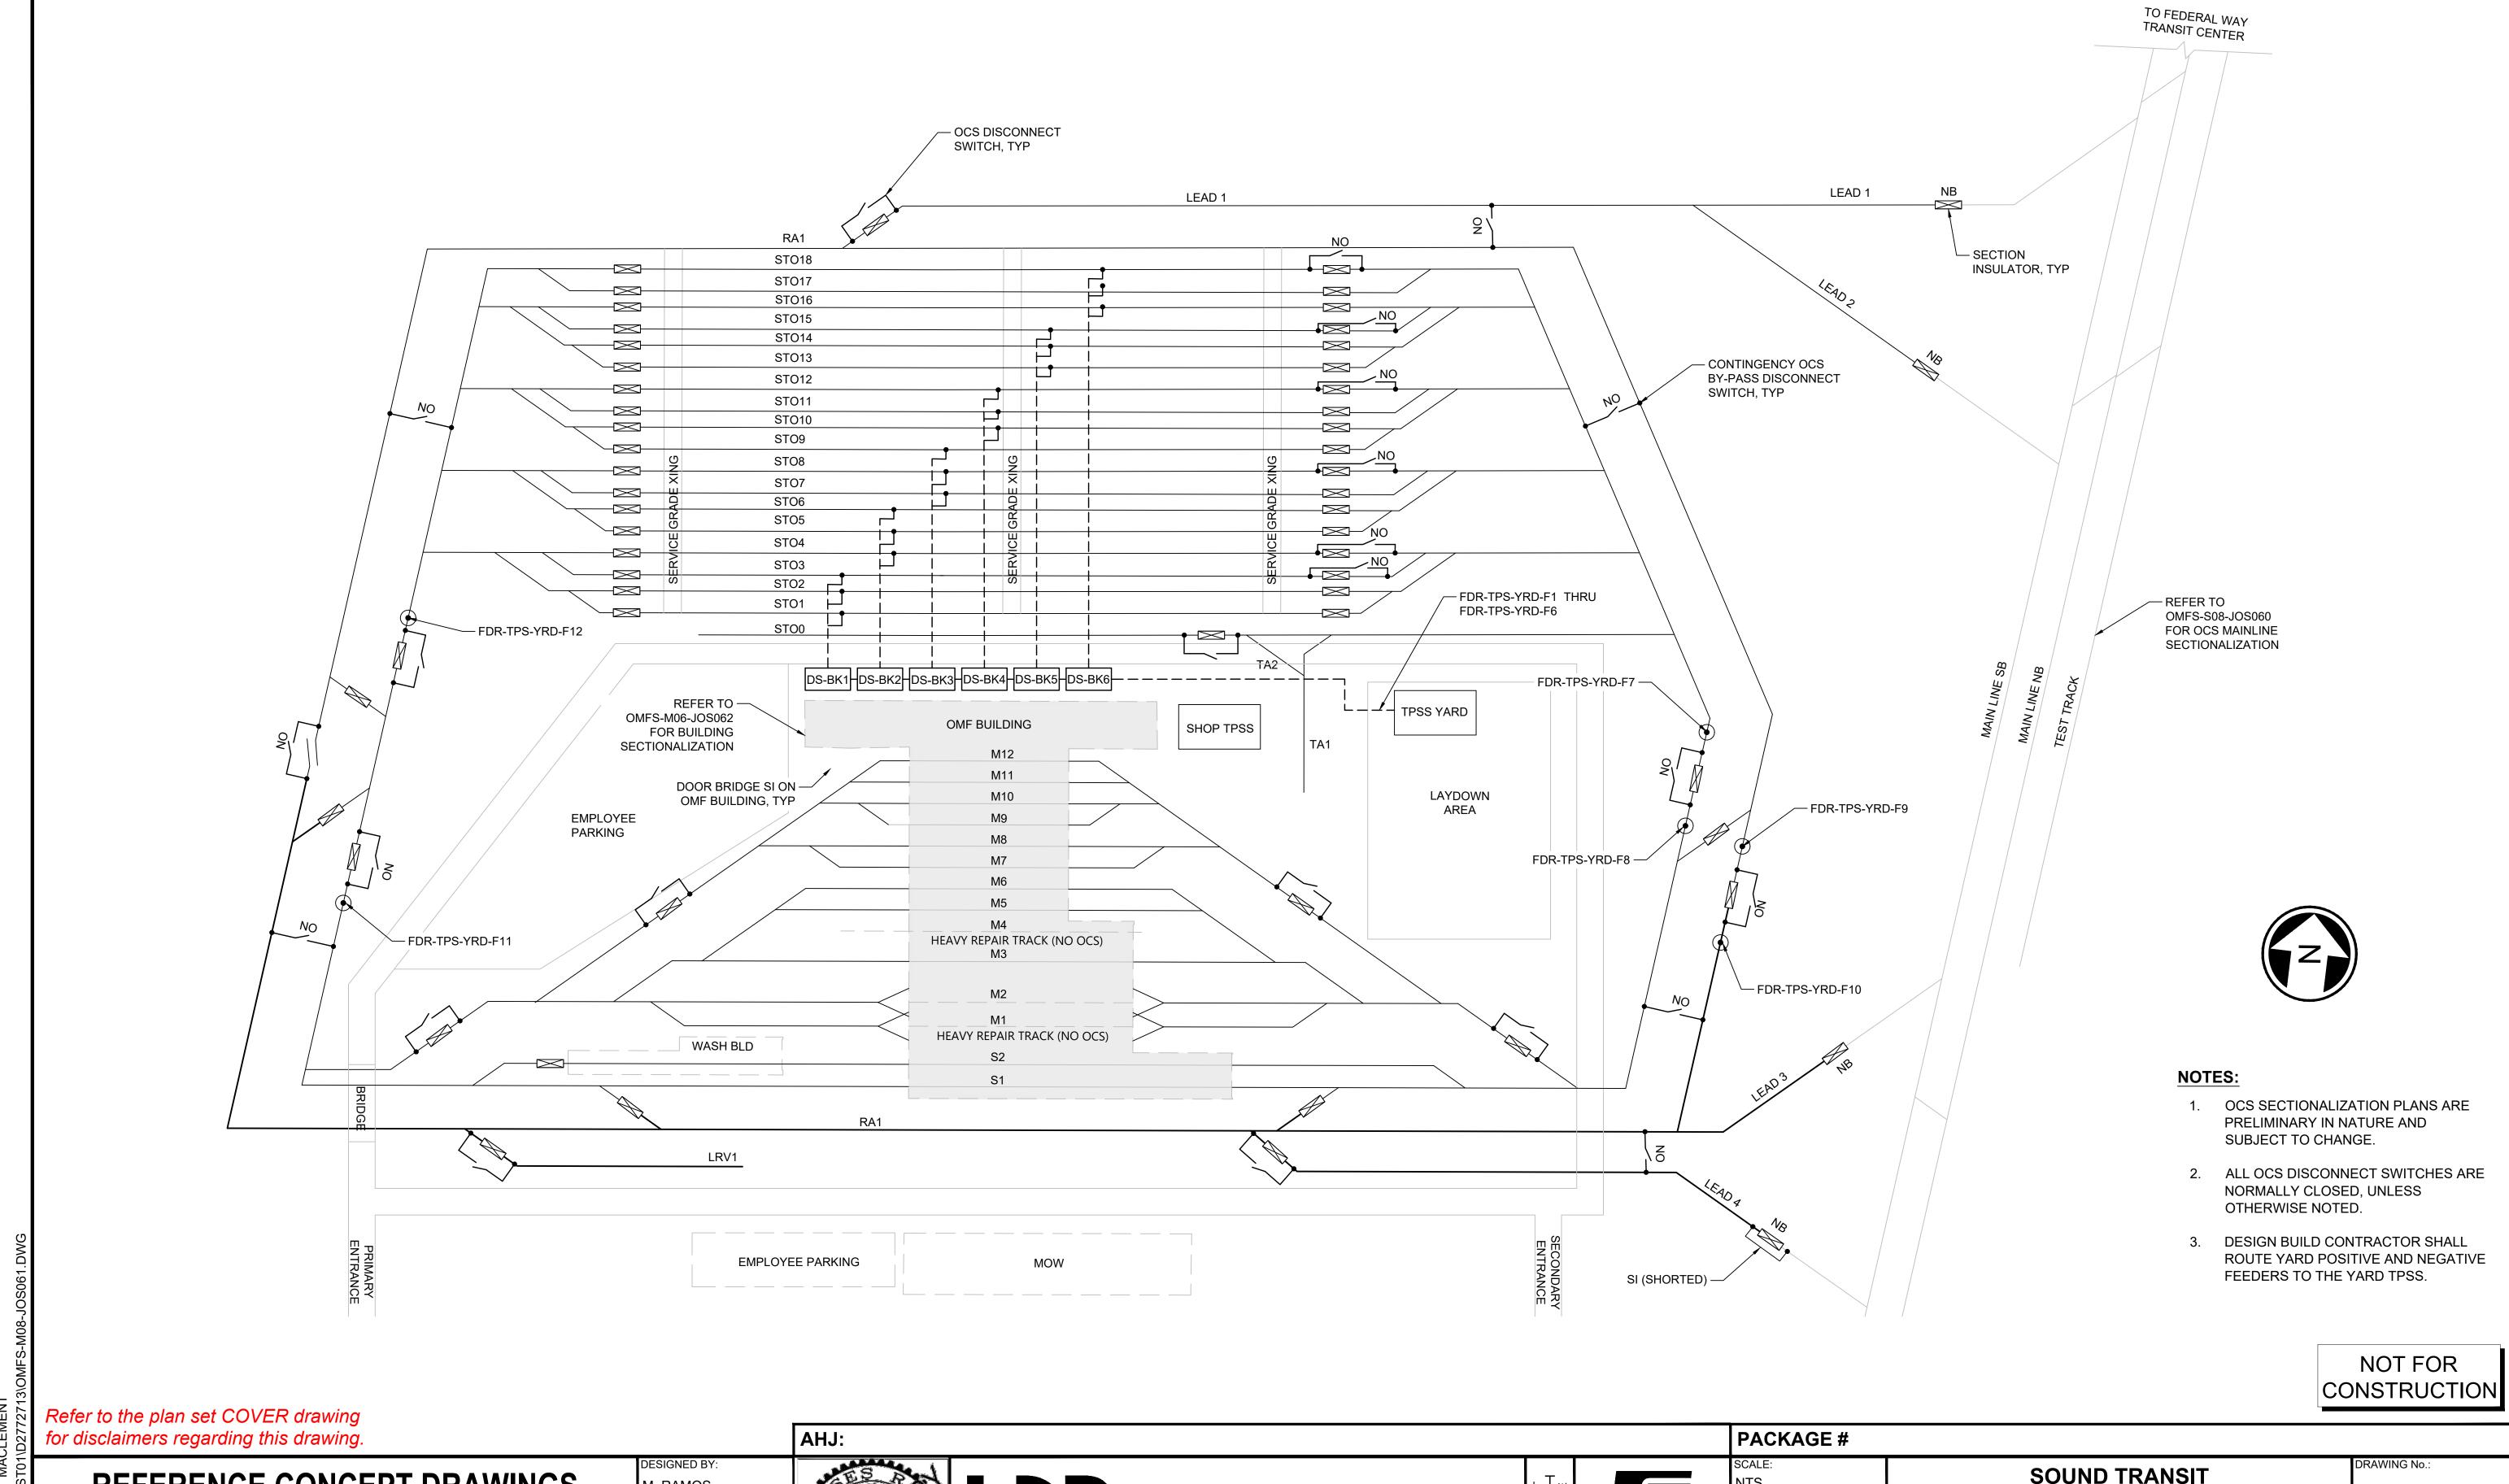

REFERENCE CONCEPT DRAWINGS M. RAMOS DRAWN BY: M. CLEMENT CHECKED BY: R. DEMERS APPROVED BY M. RAMOS

PABLO LOPEZ-HILFIKER

REVIEWED BY:

2/27/2024

5 SoundTransit

FILENAME: OMFS-M08-JOS061 CONTRACT No.: AE-0030-17


2/27/2024


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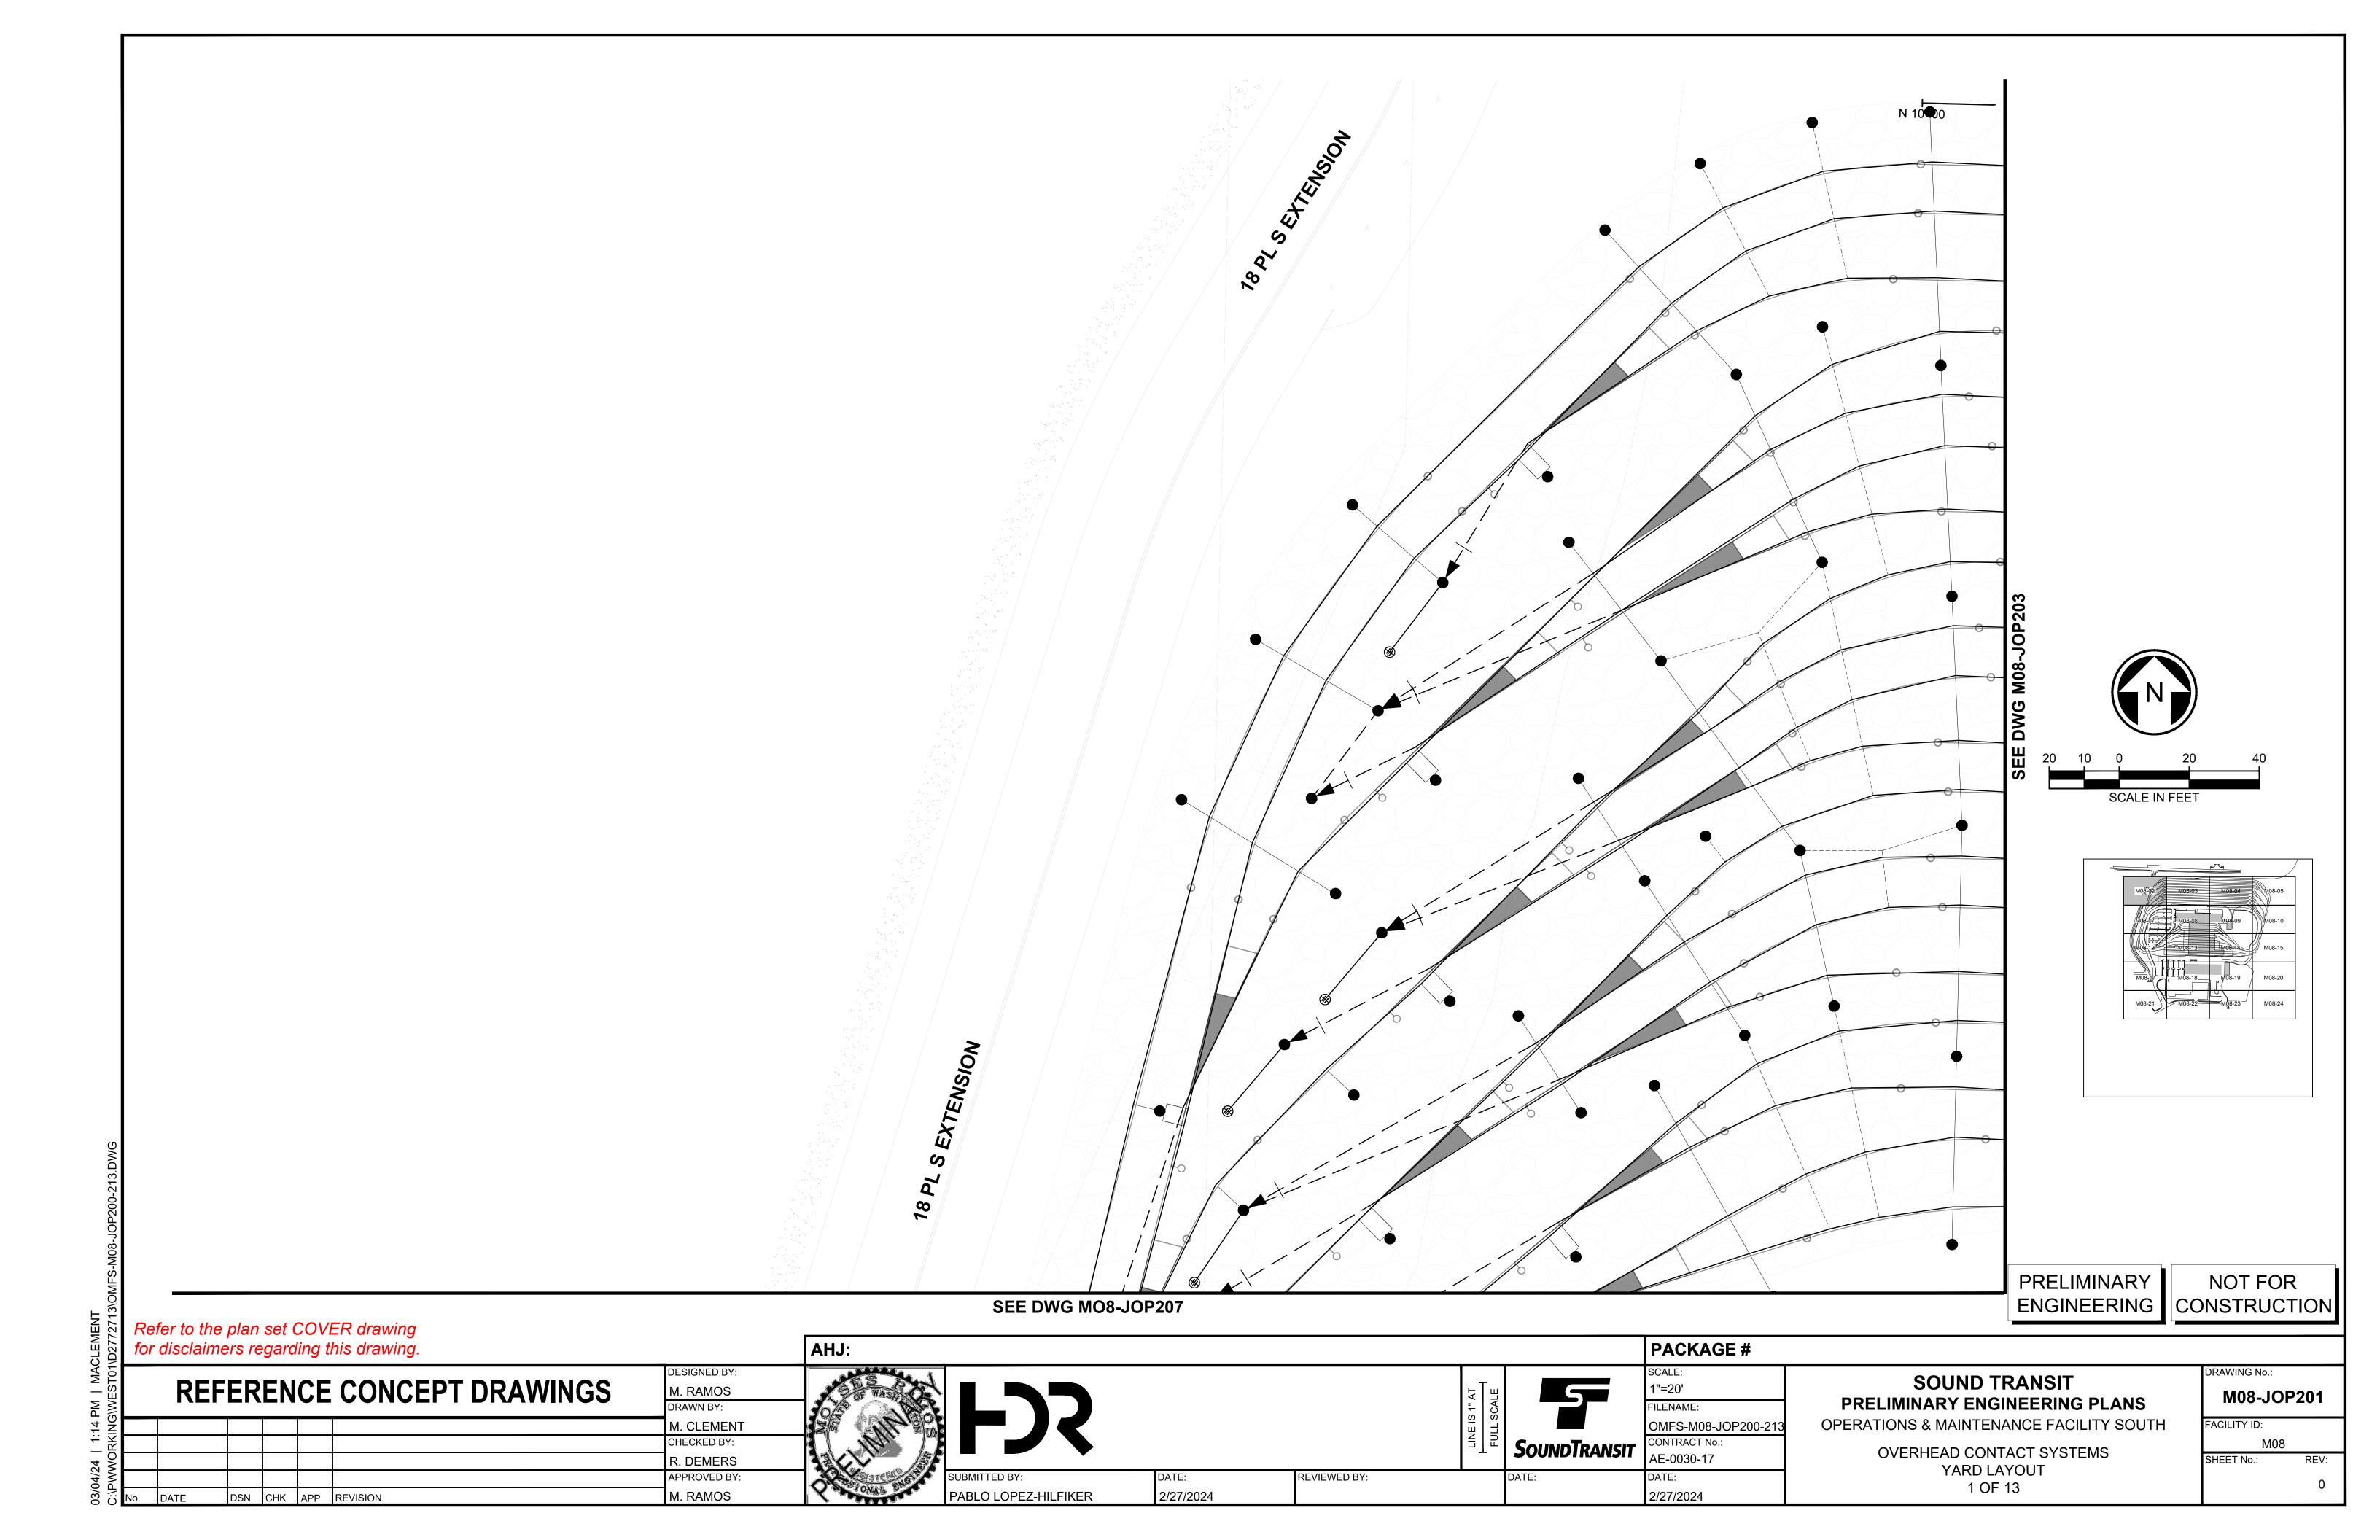
OVERHEAD CONTACT SYSTEMS SECTIONALIZATION PLAN YARD


M08-JOS061


FACILITY ID:




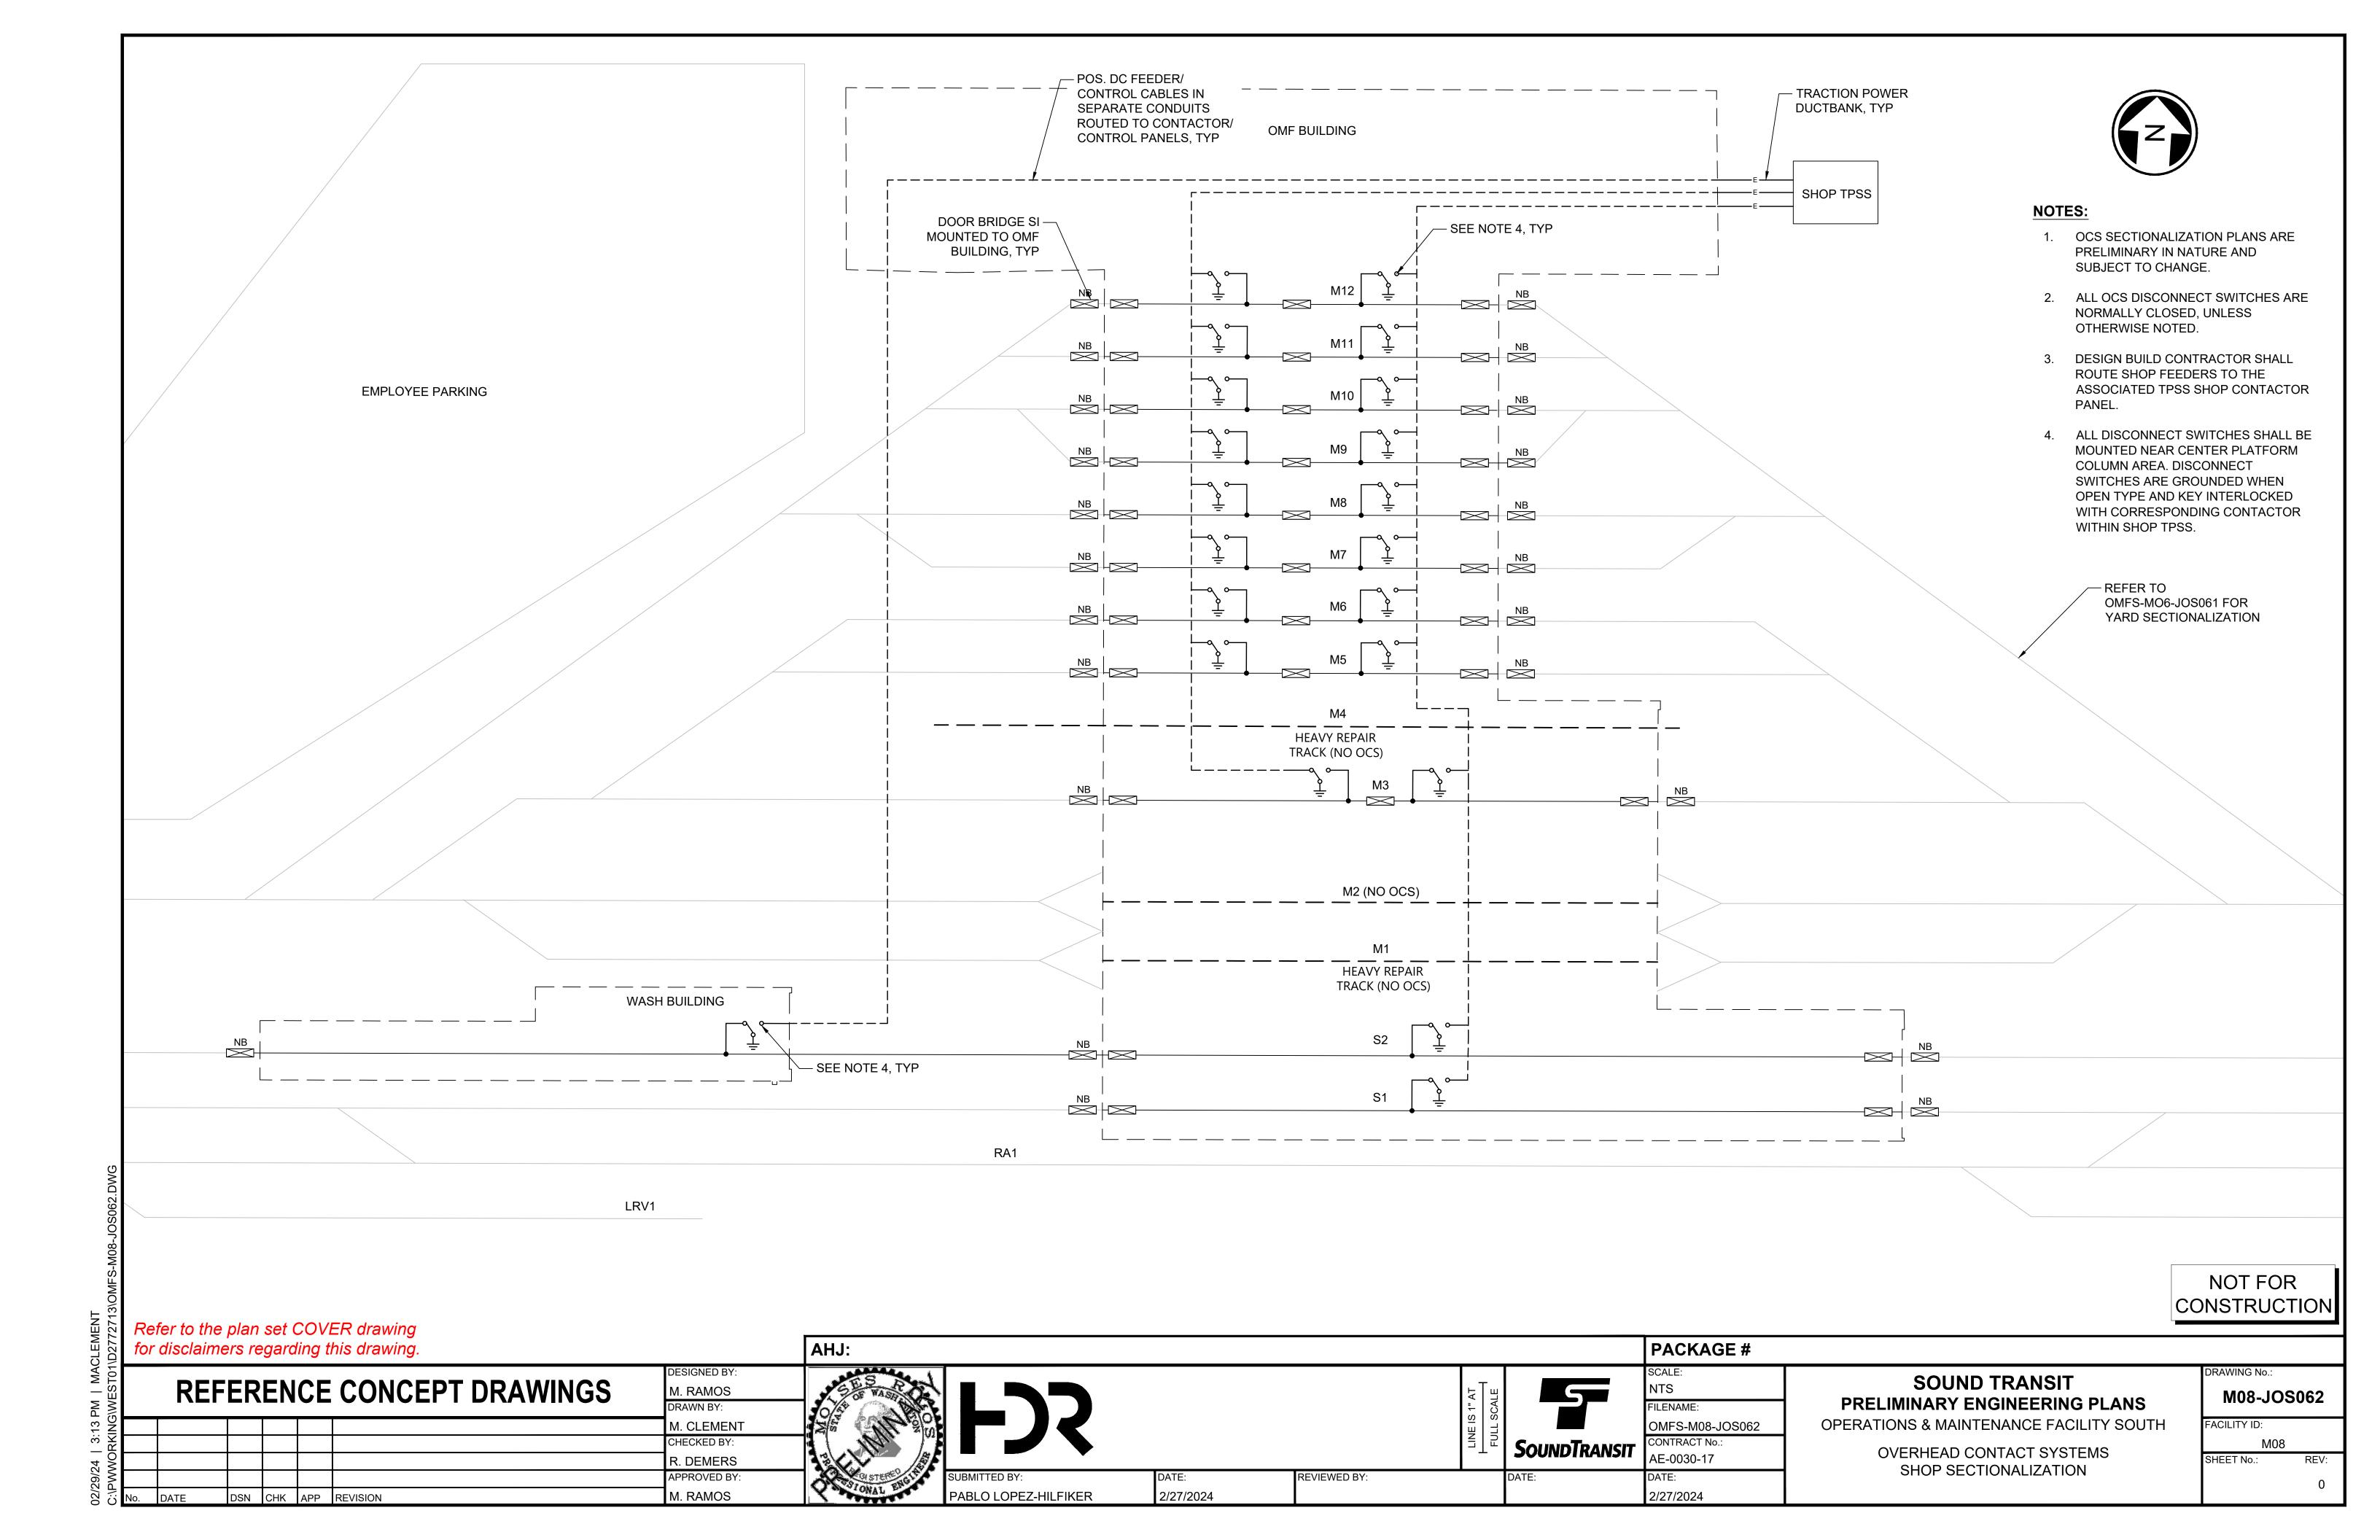


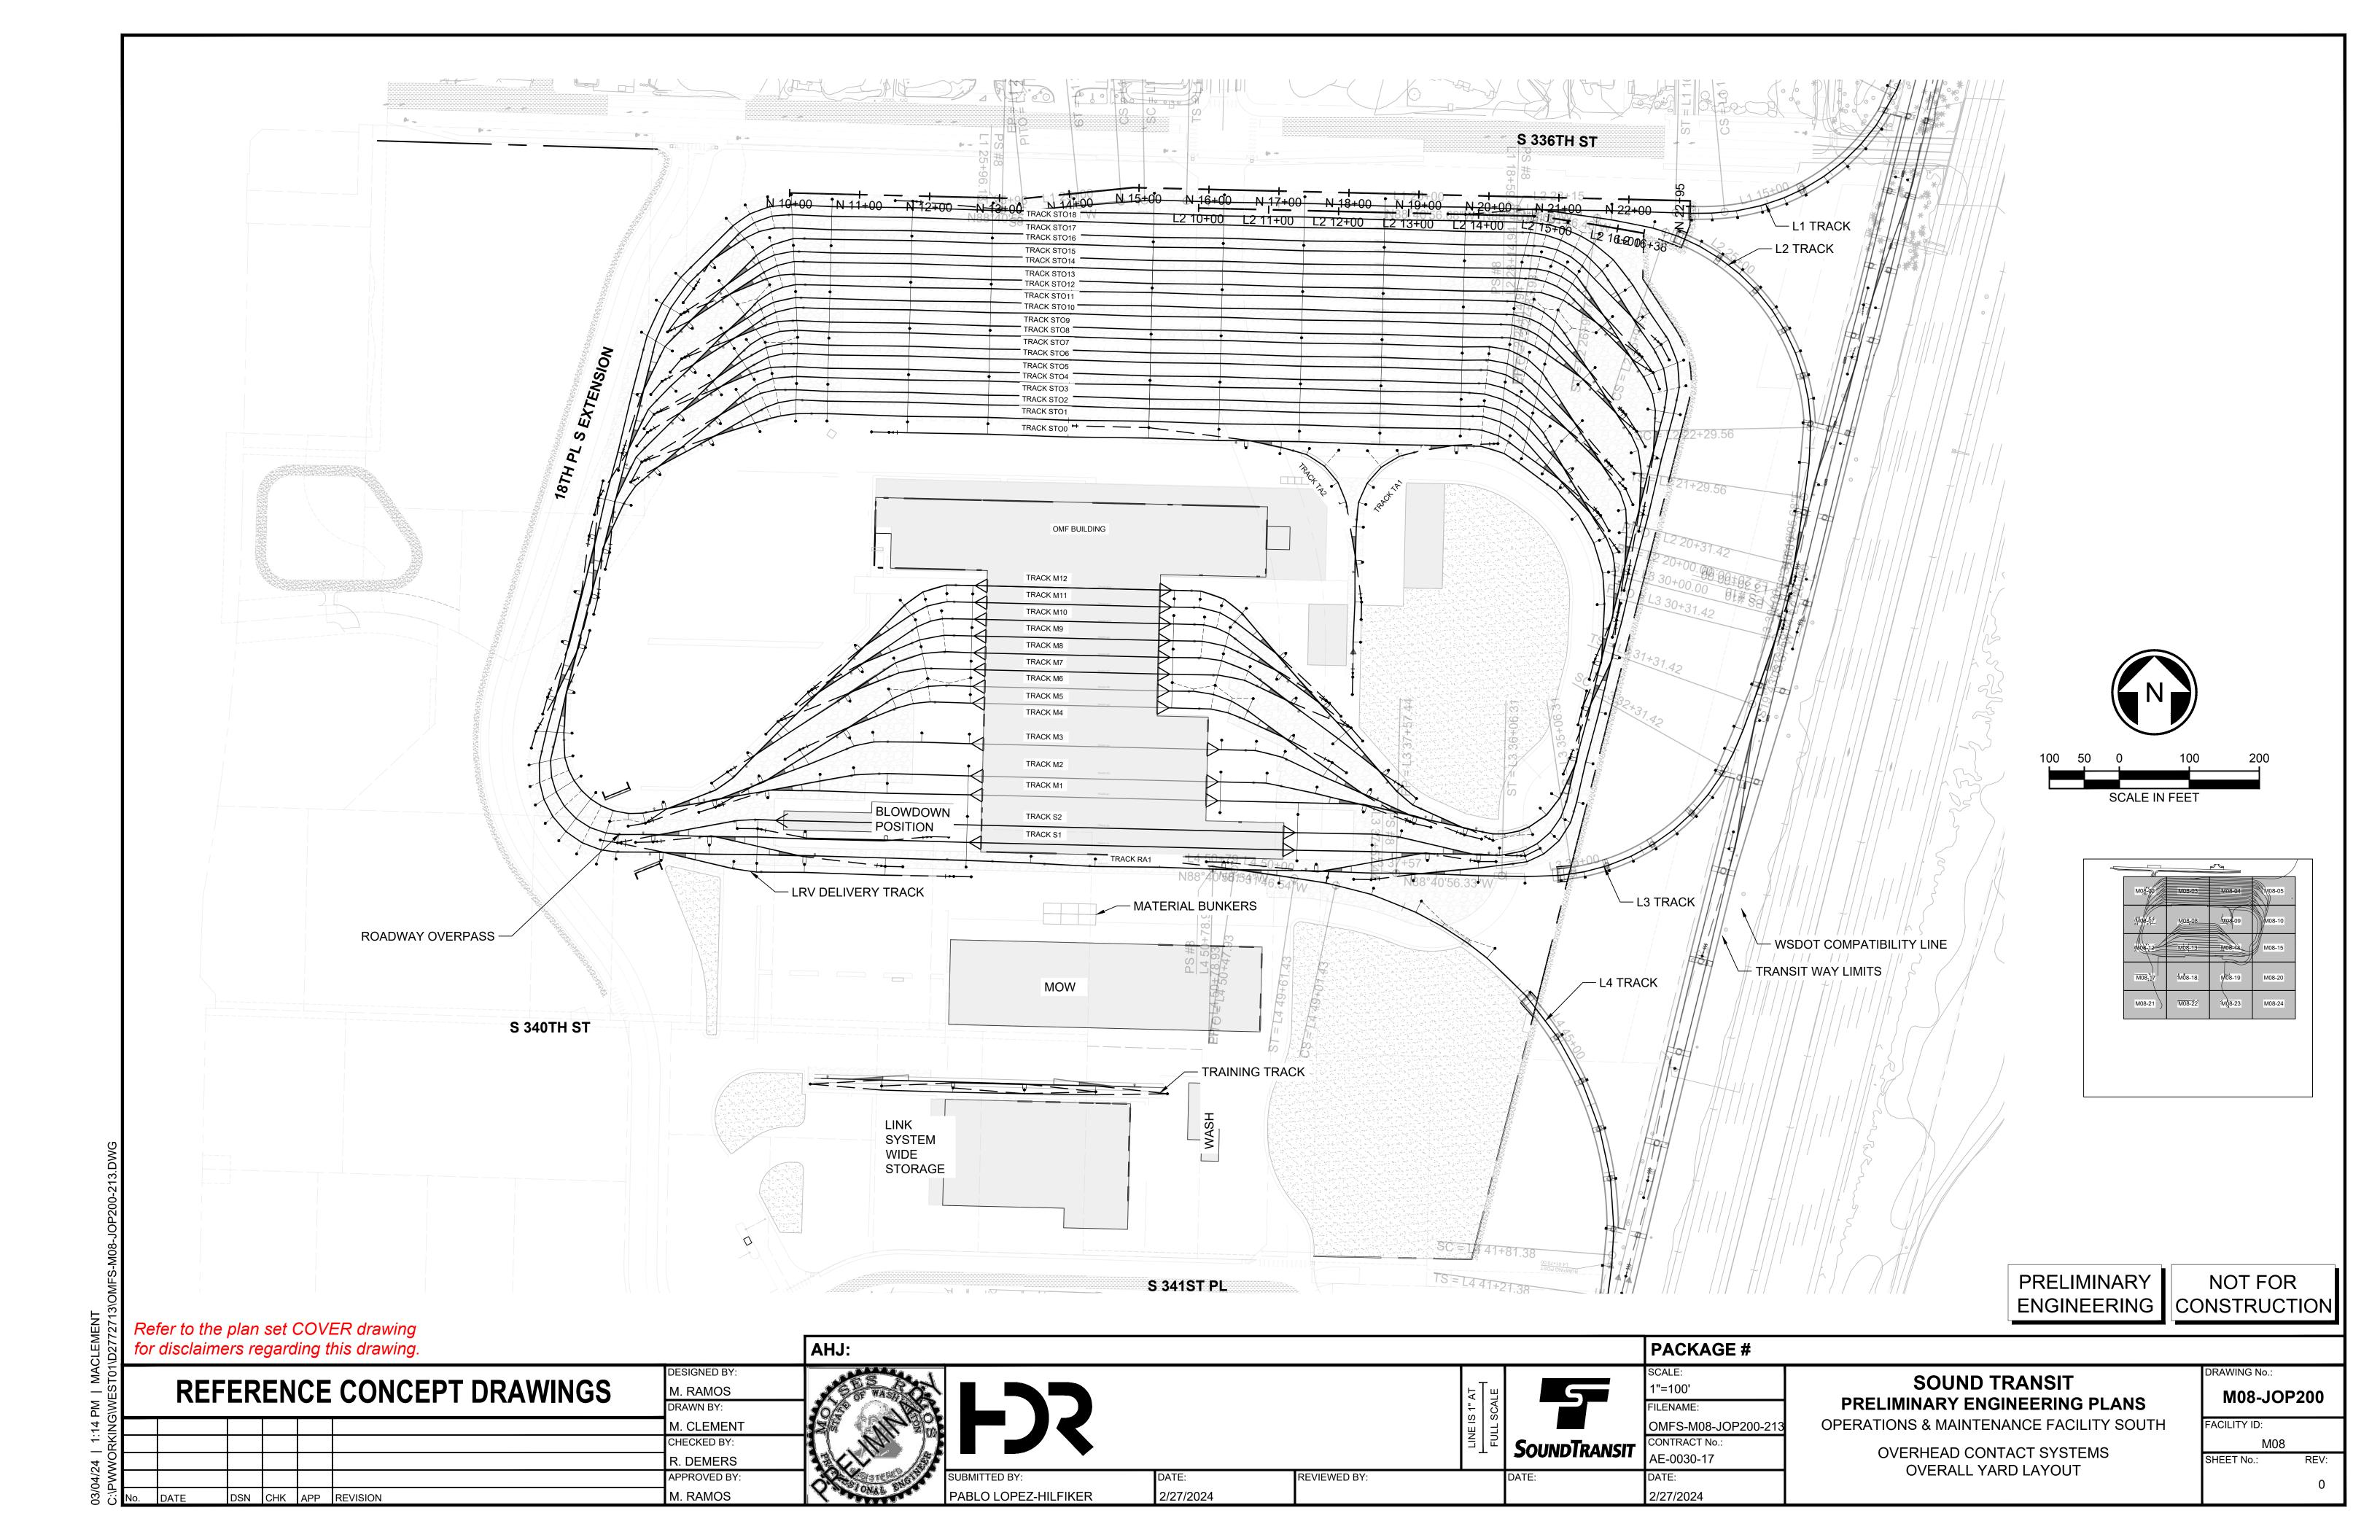


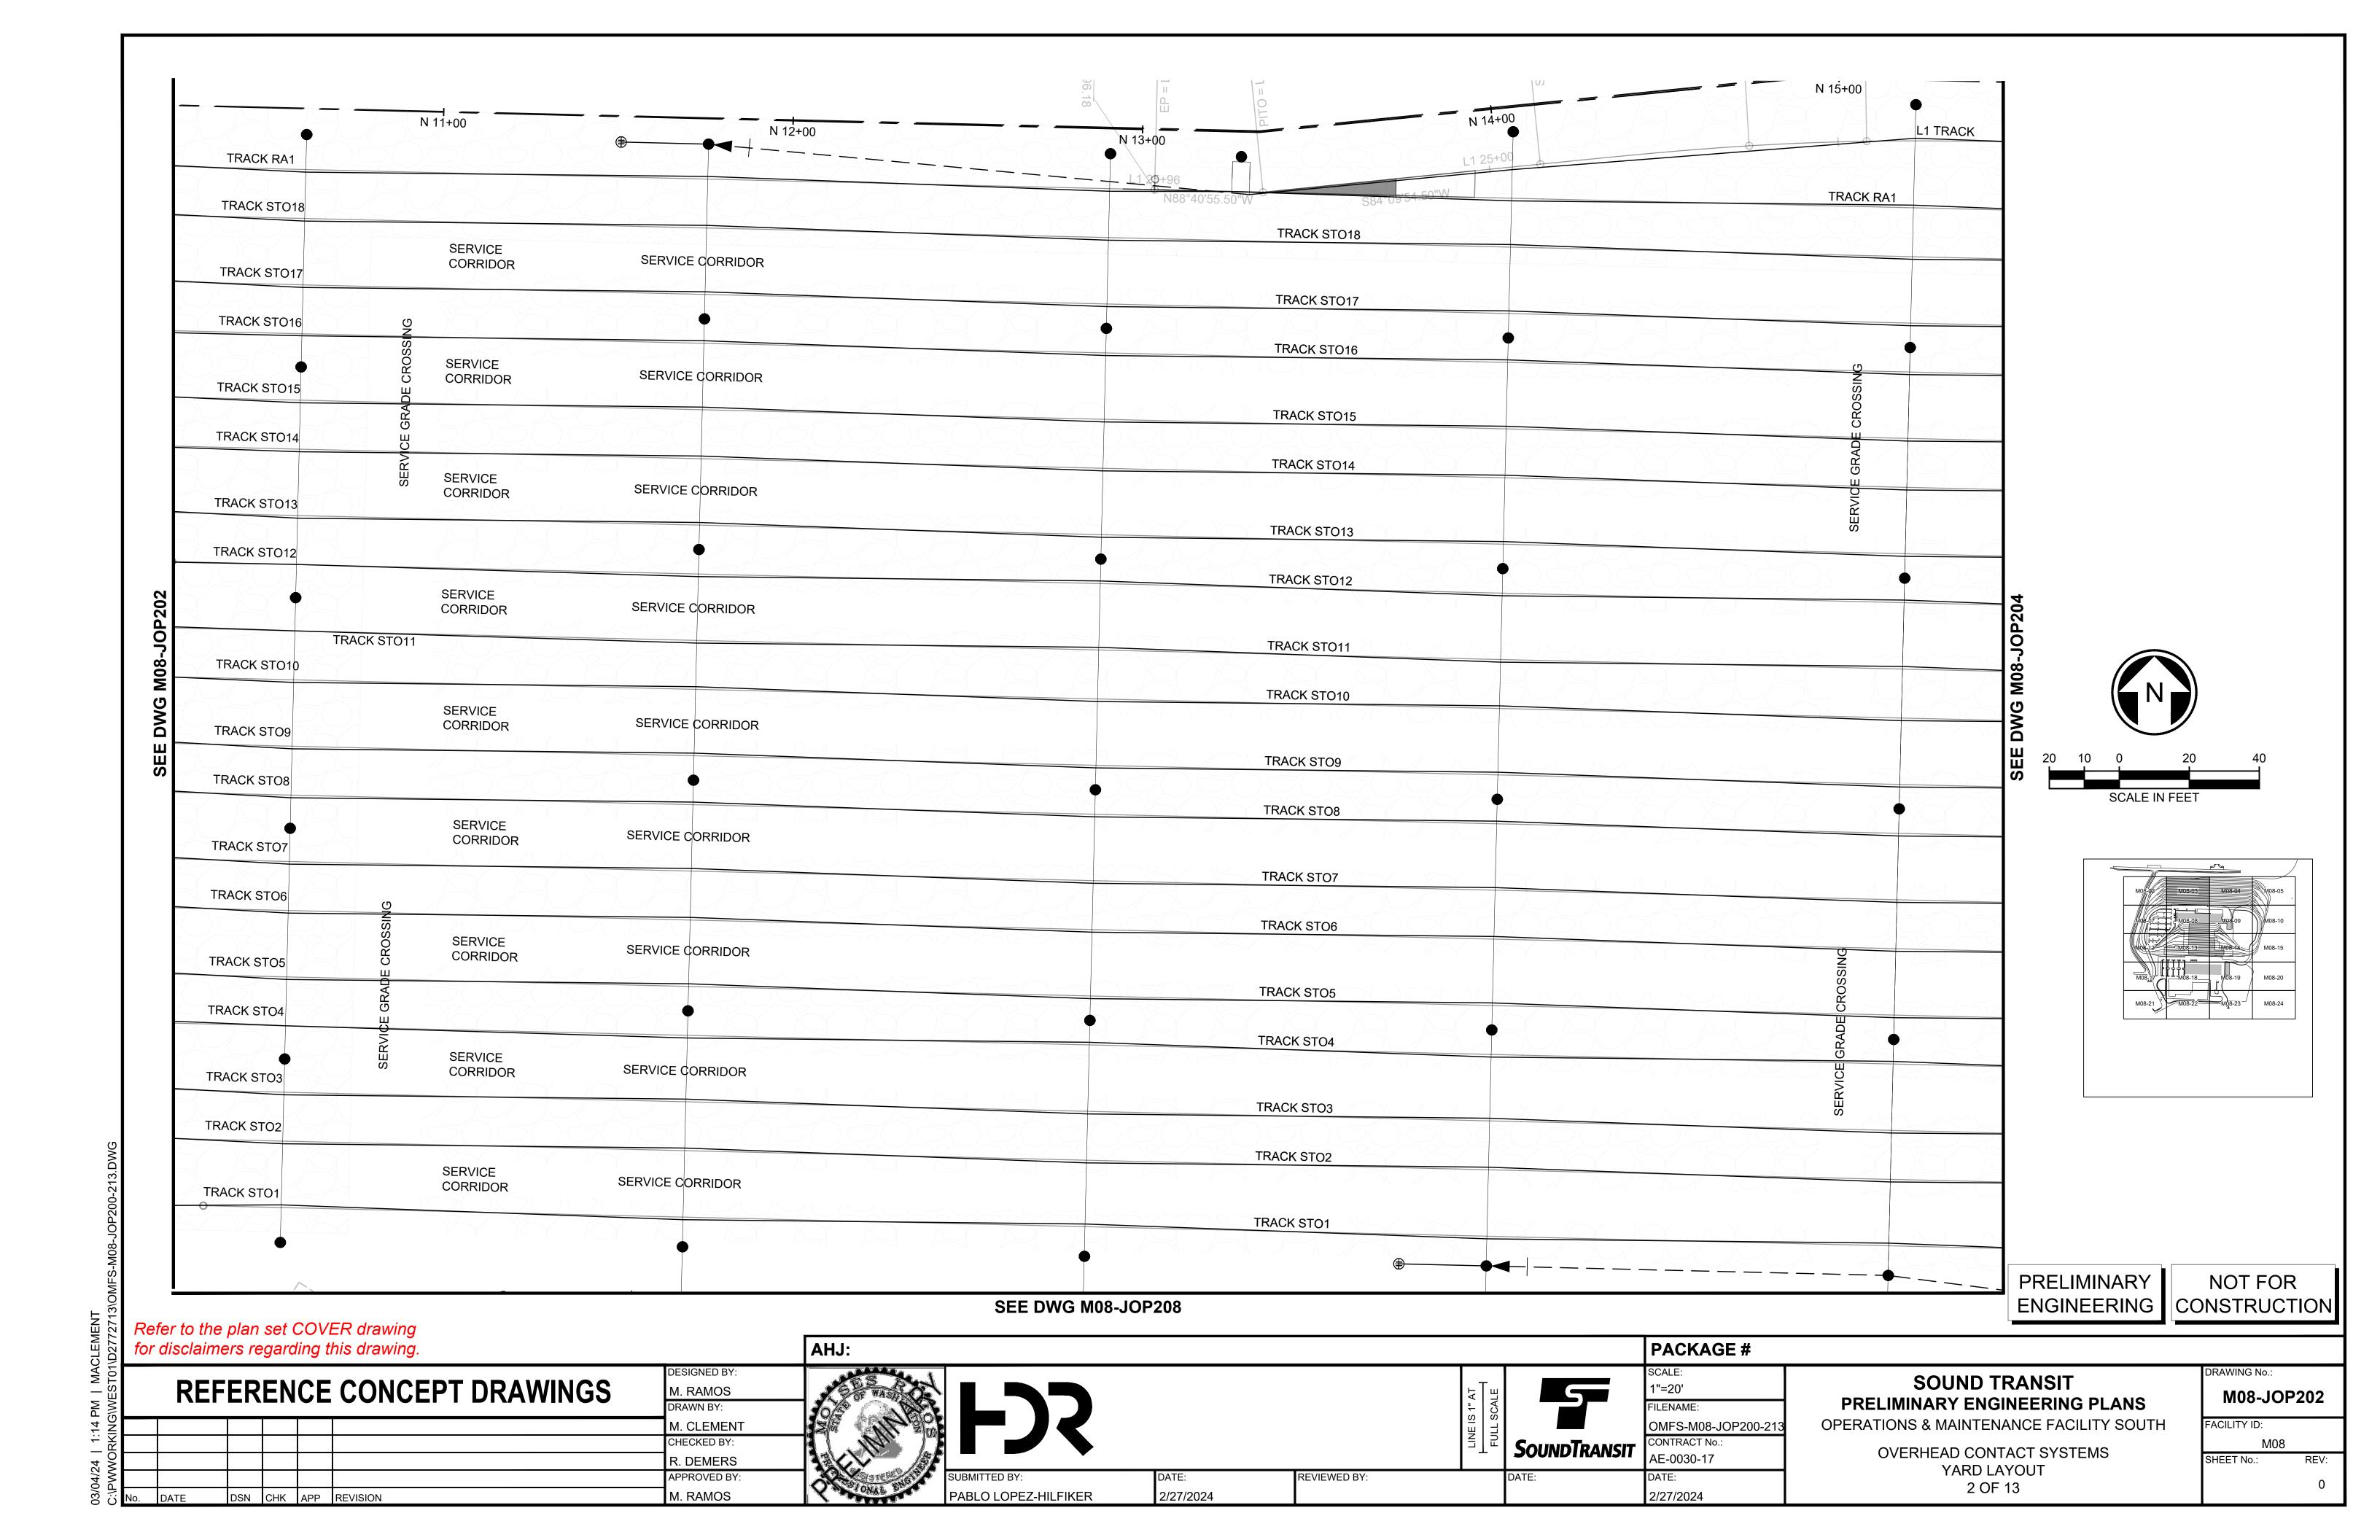


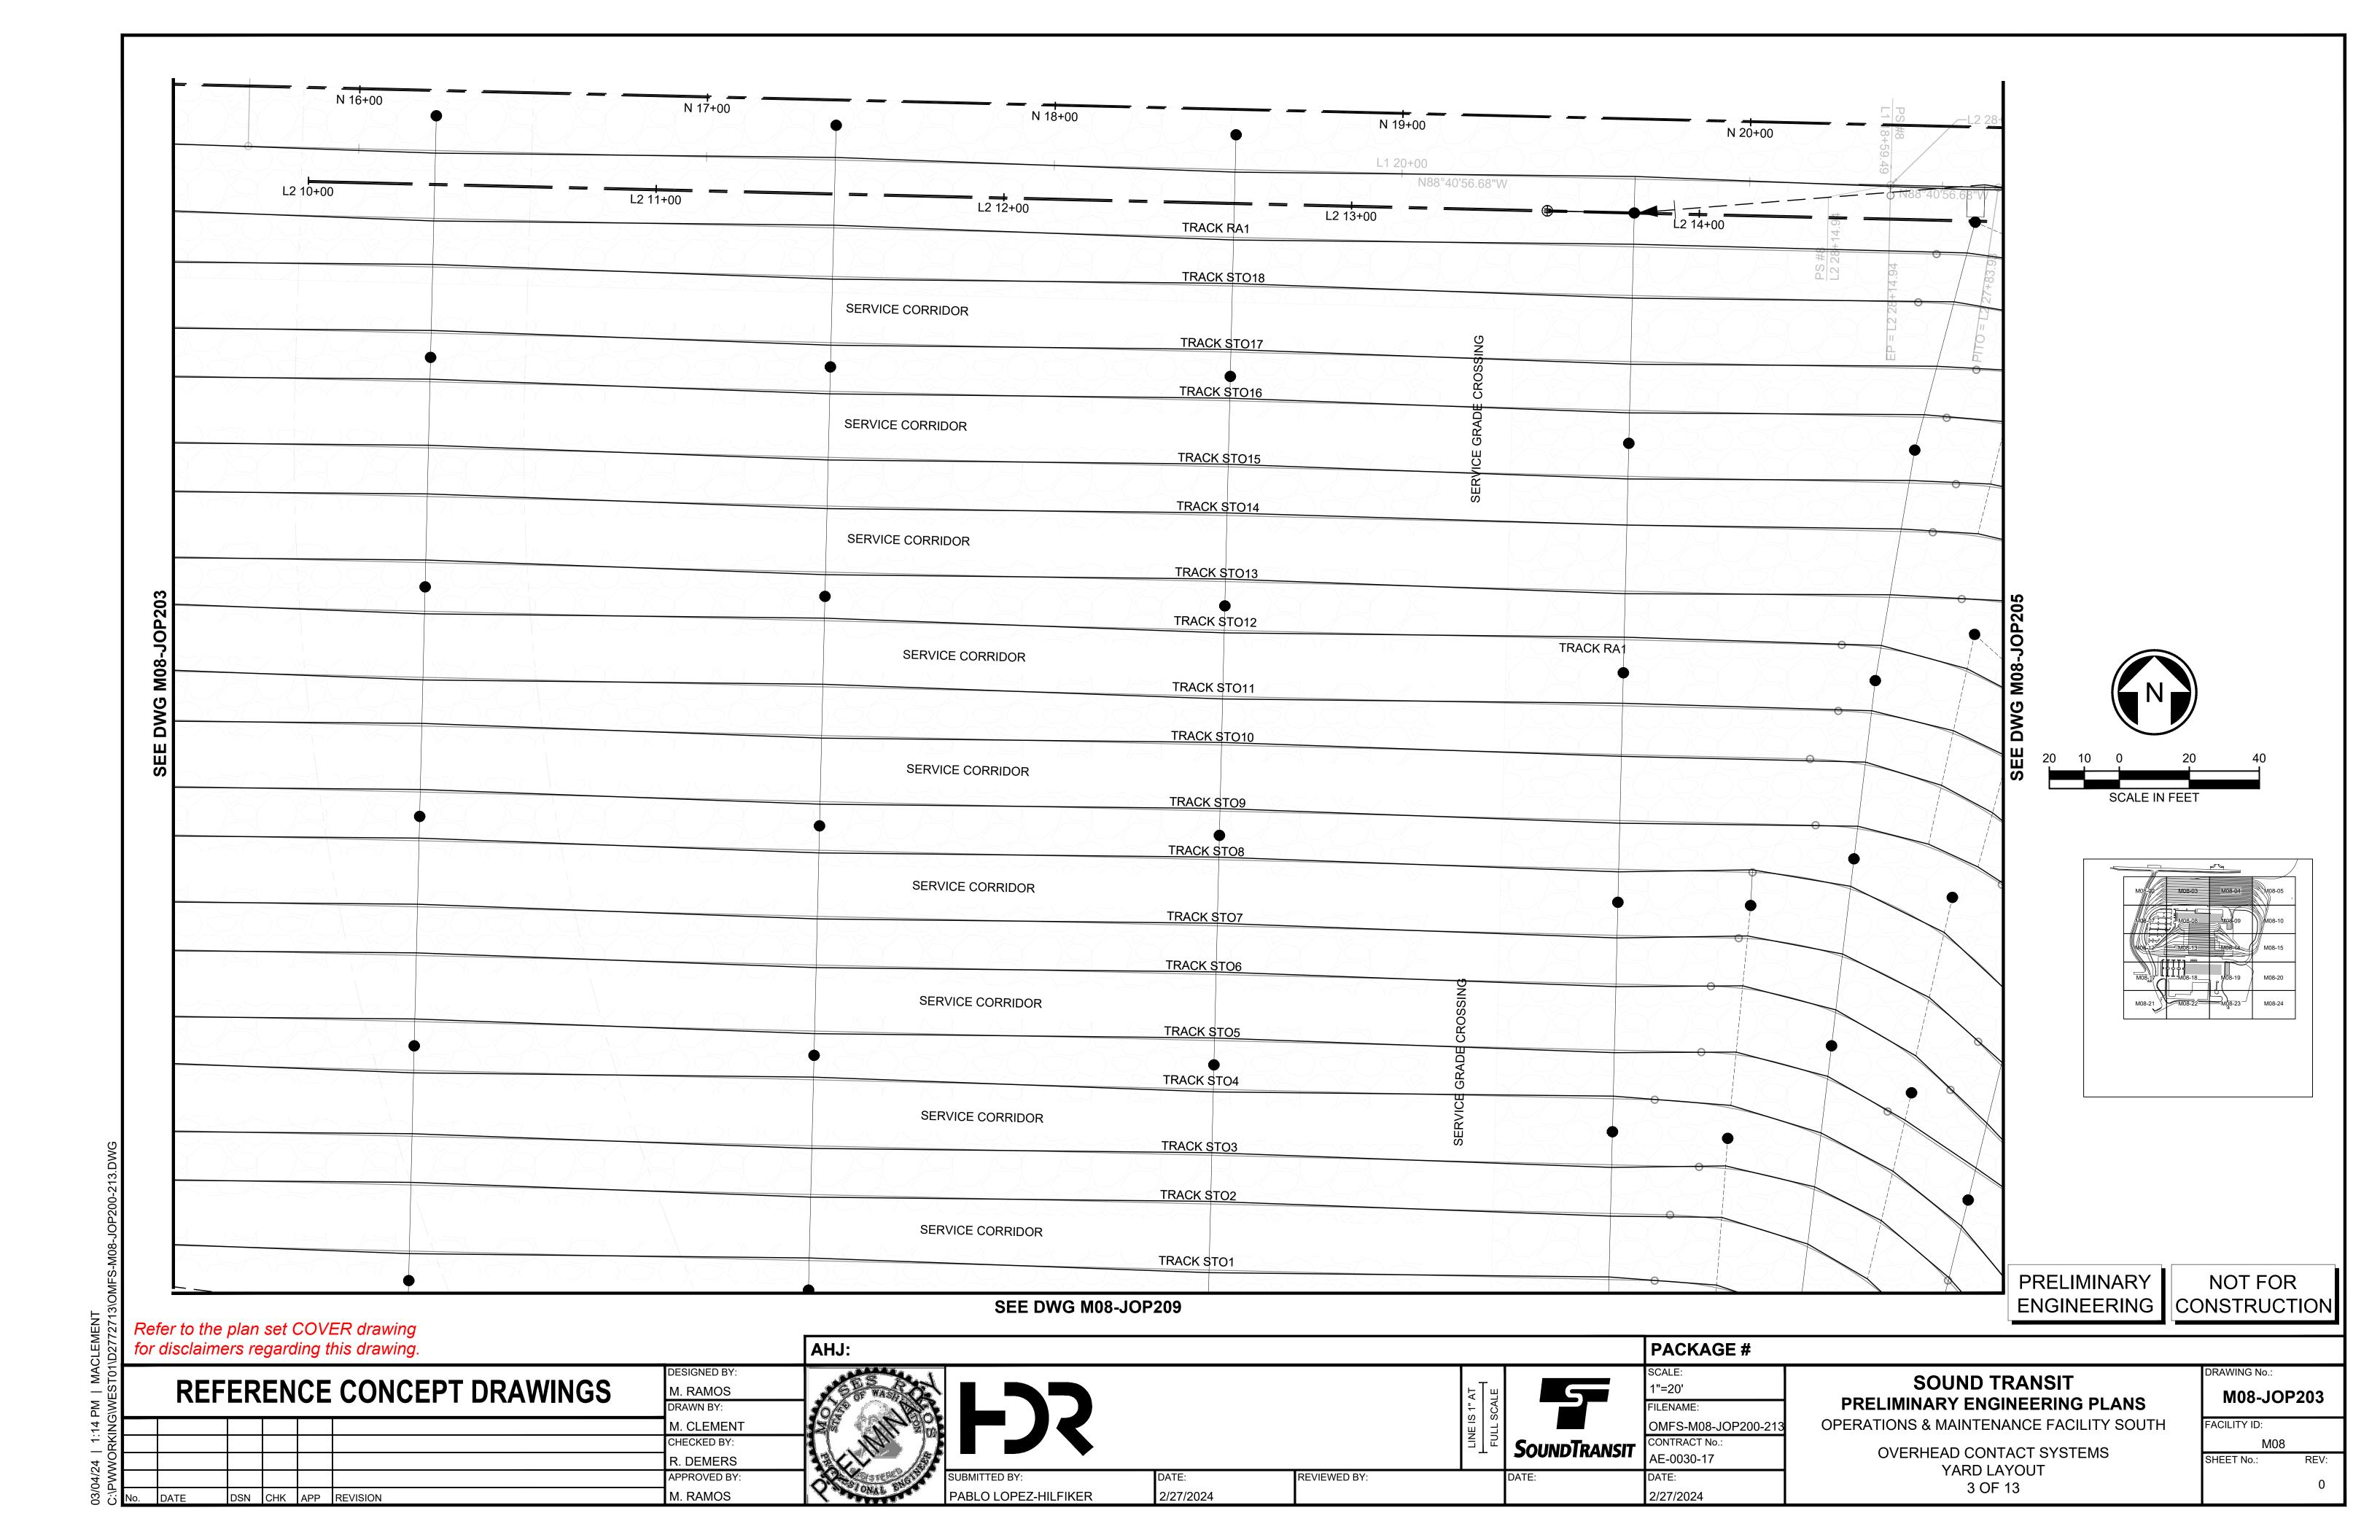


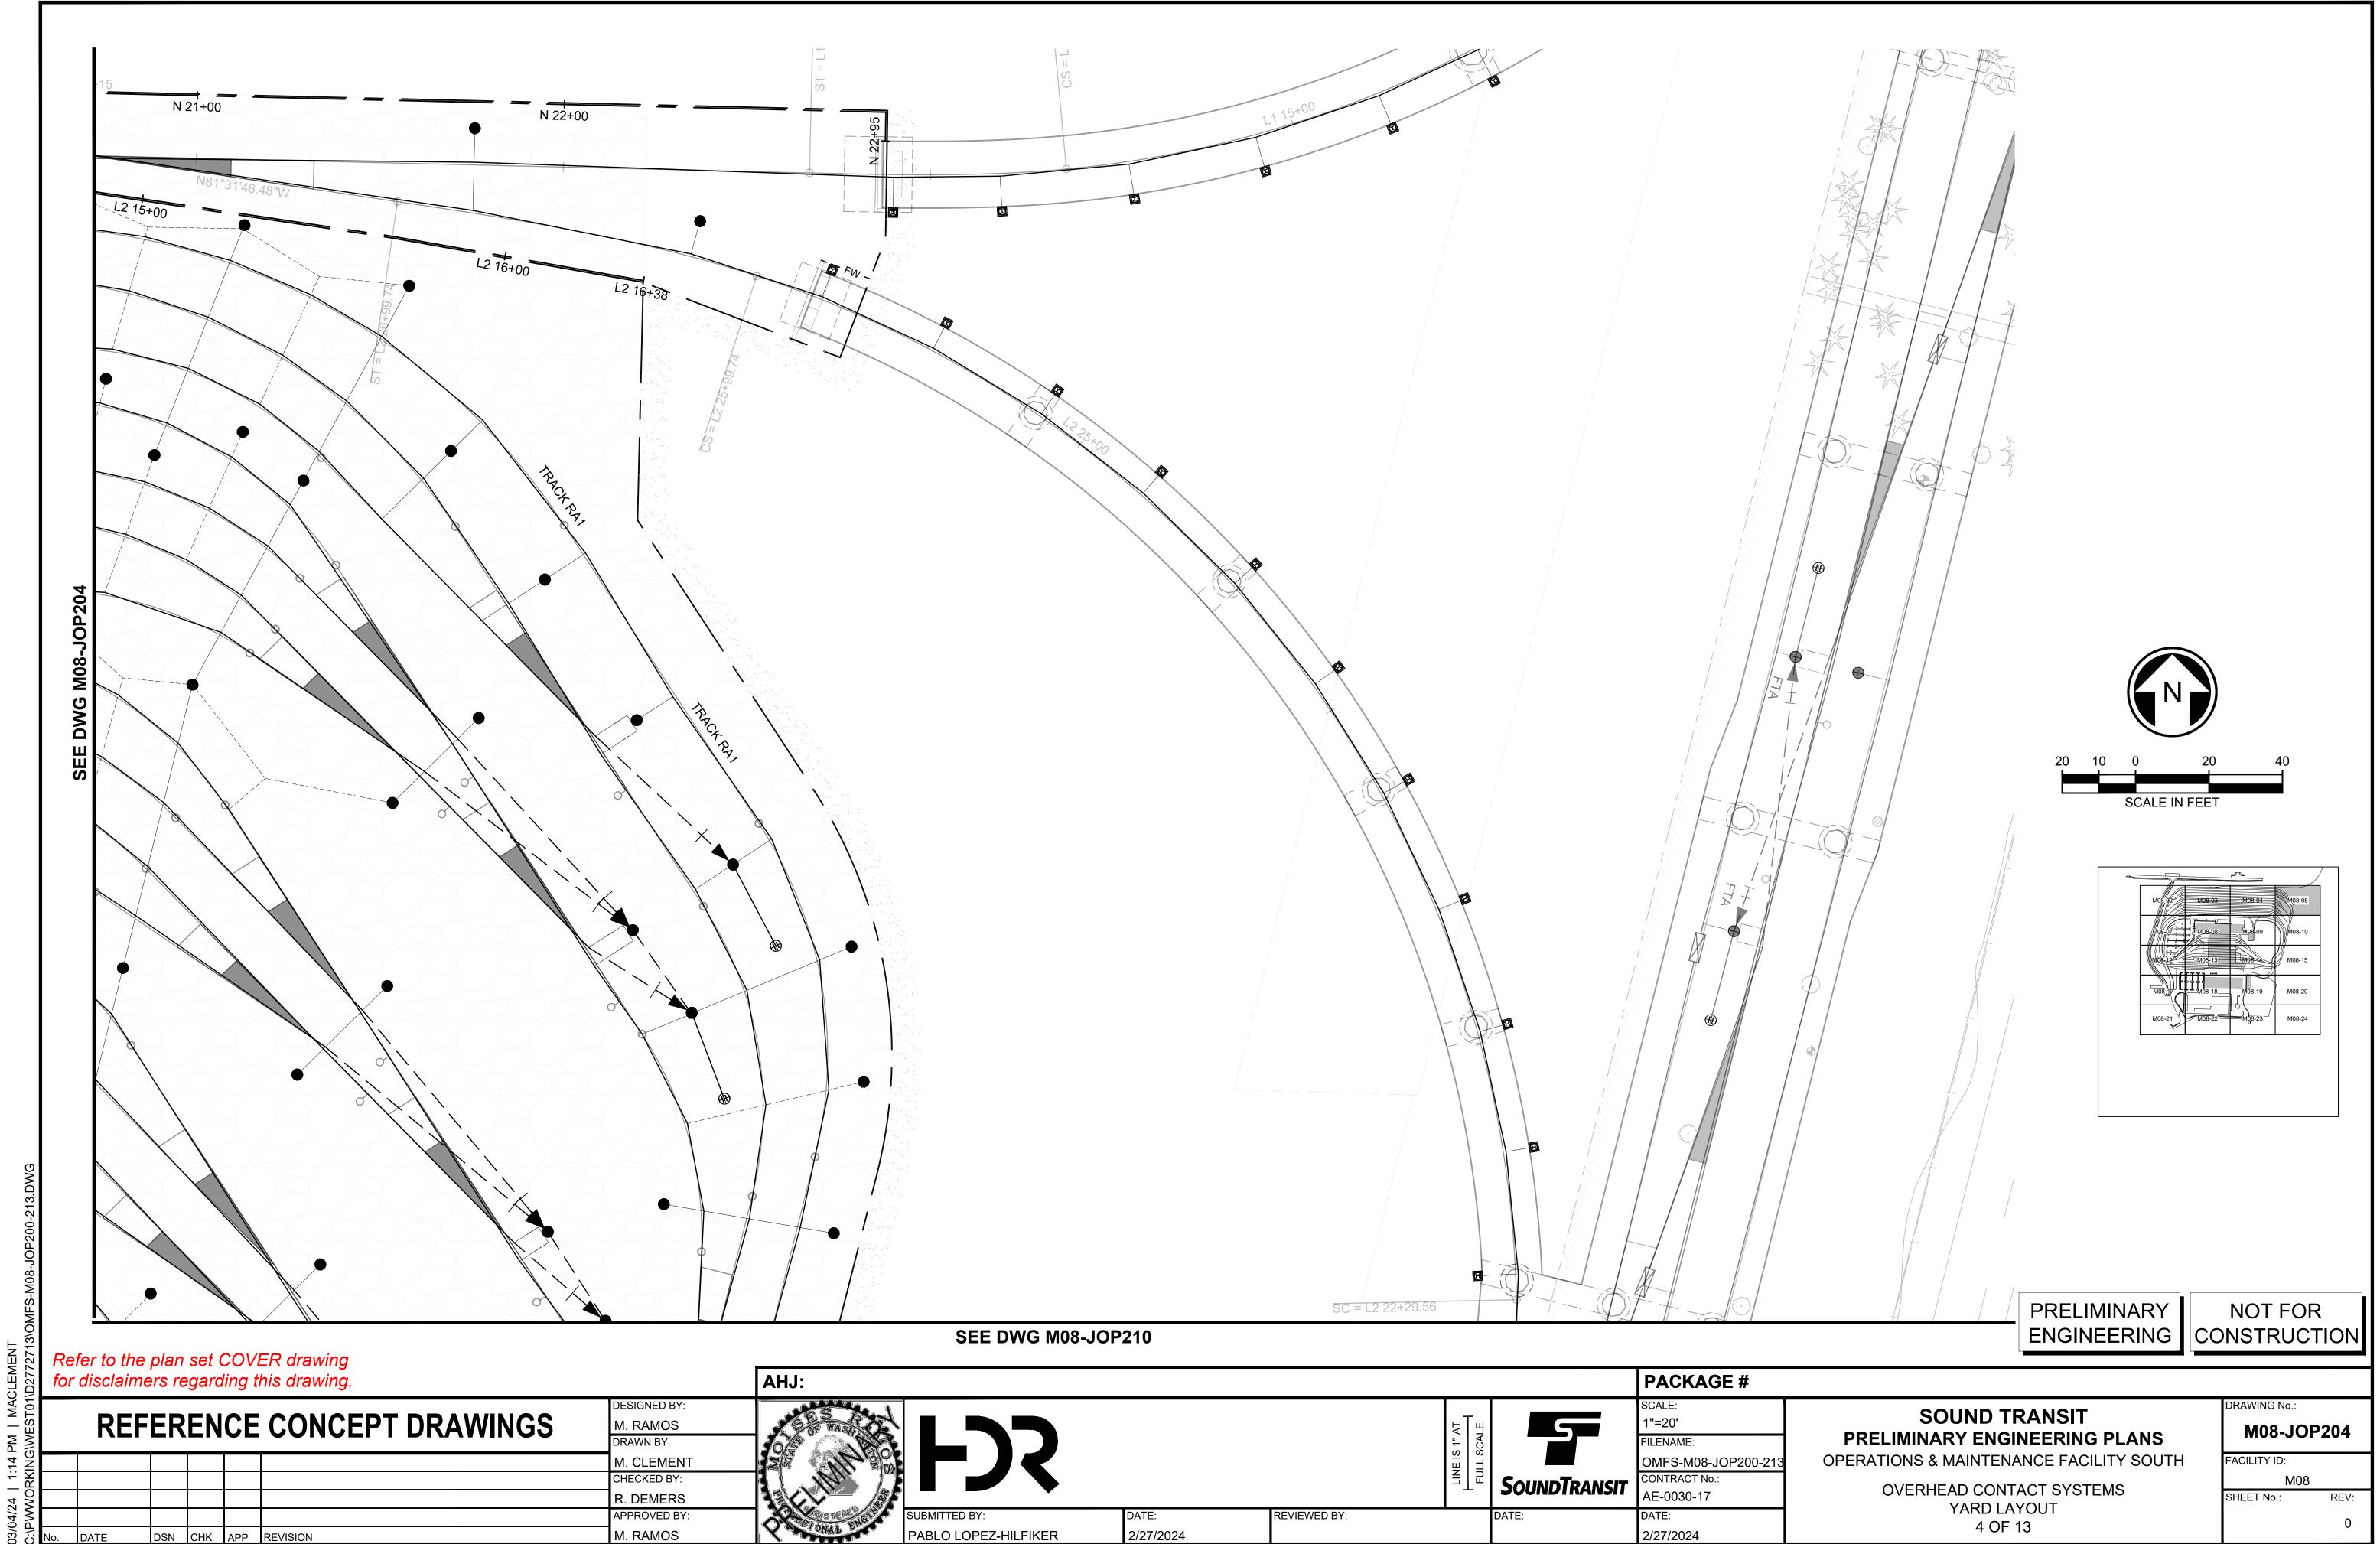


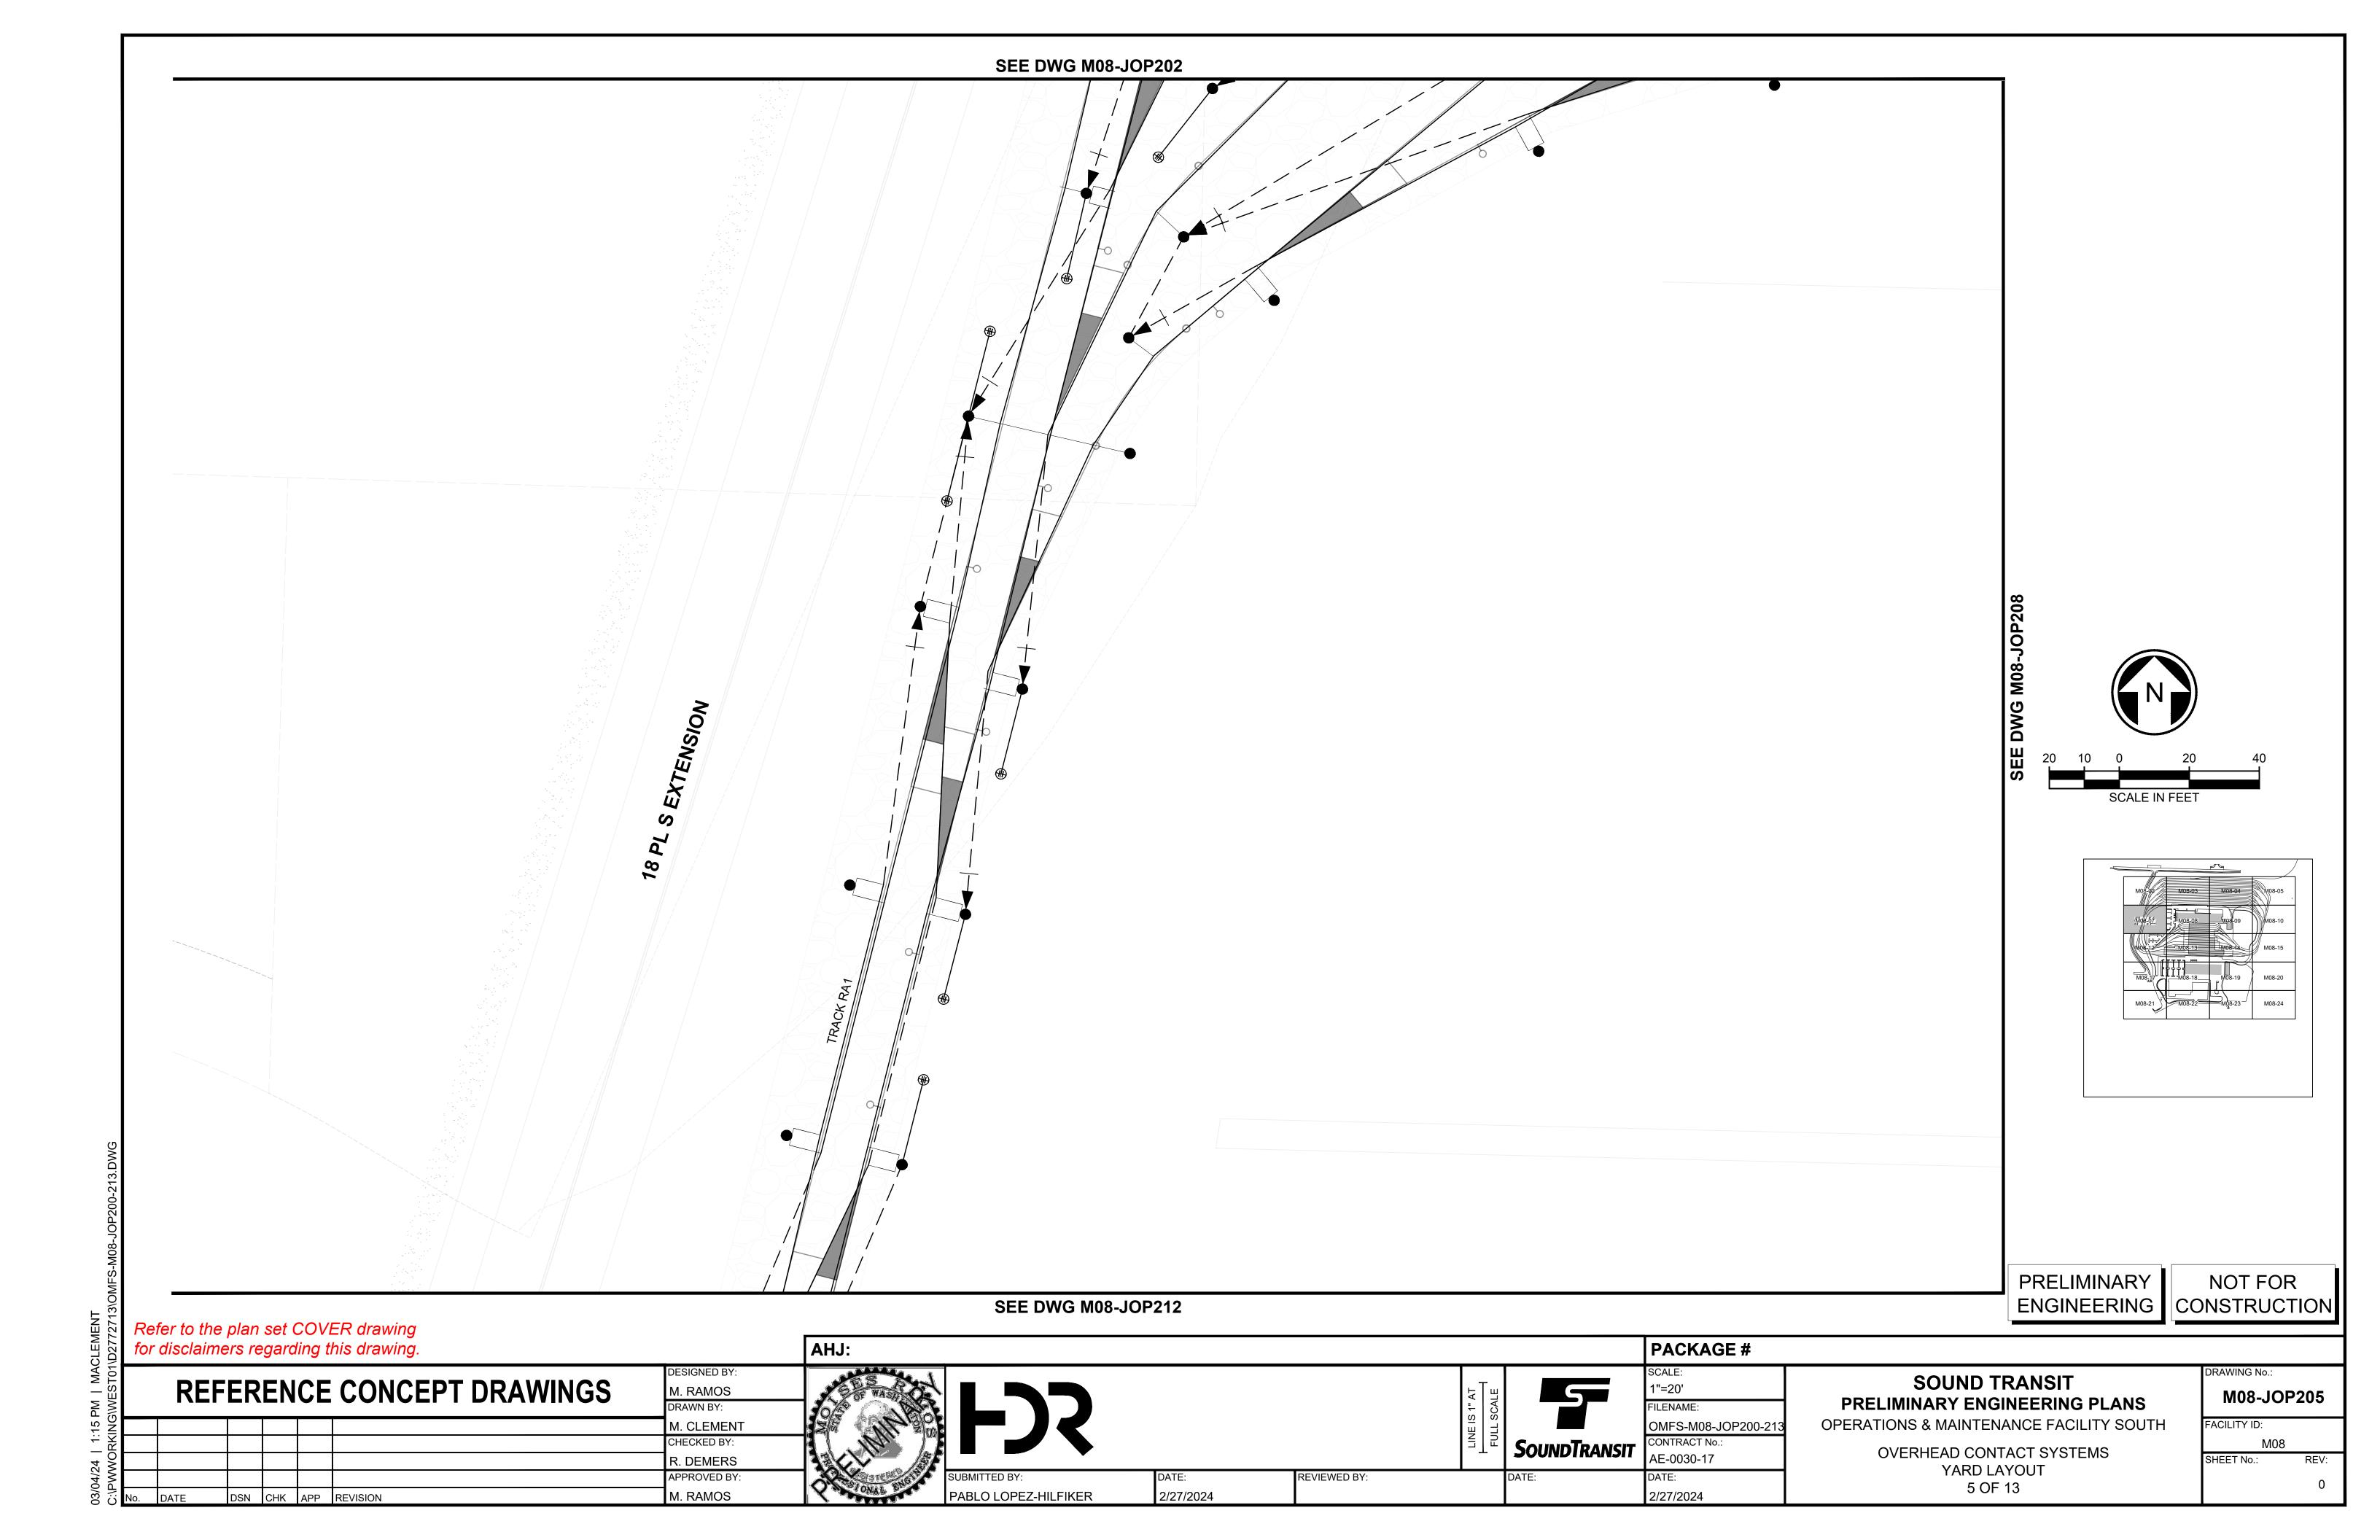


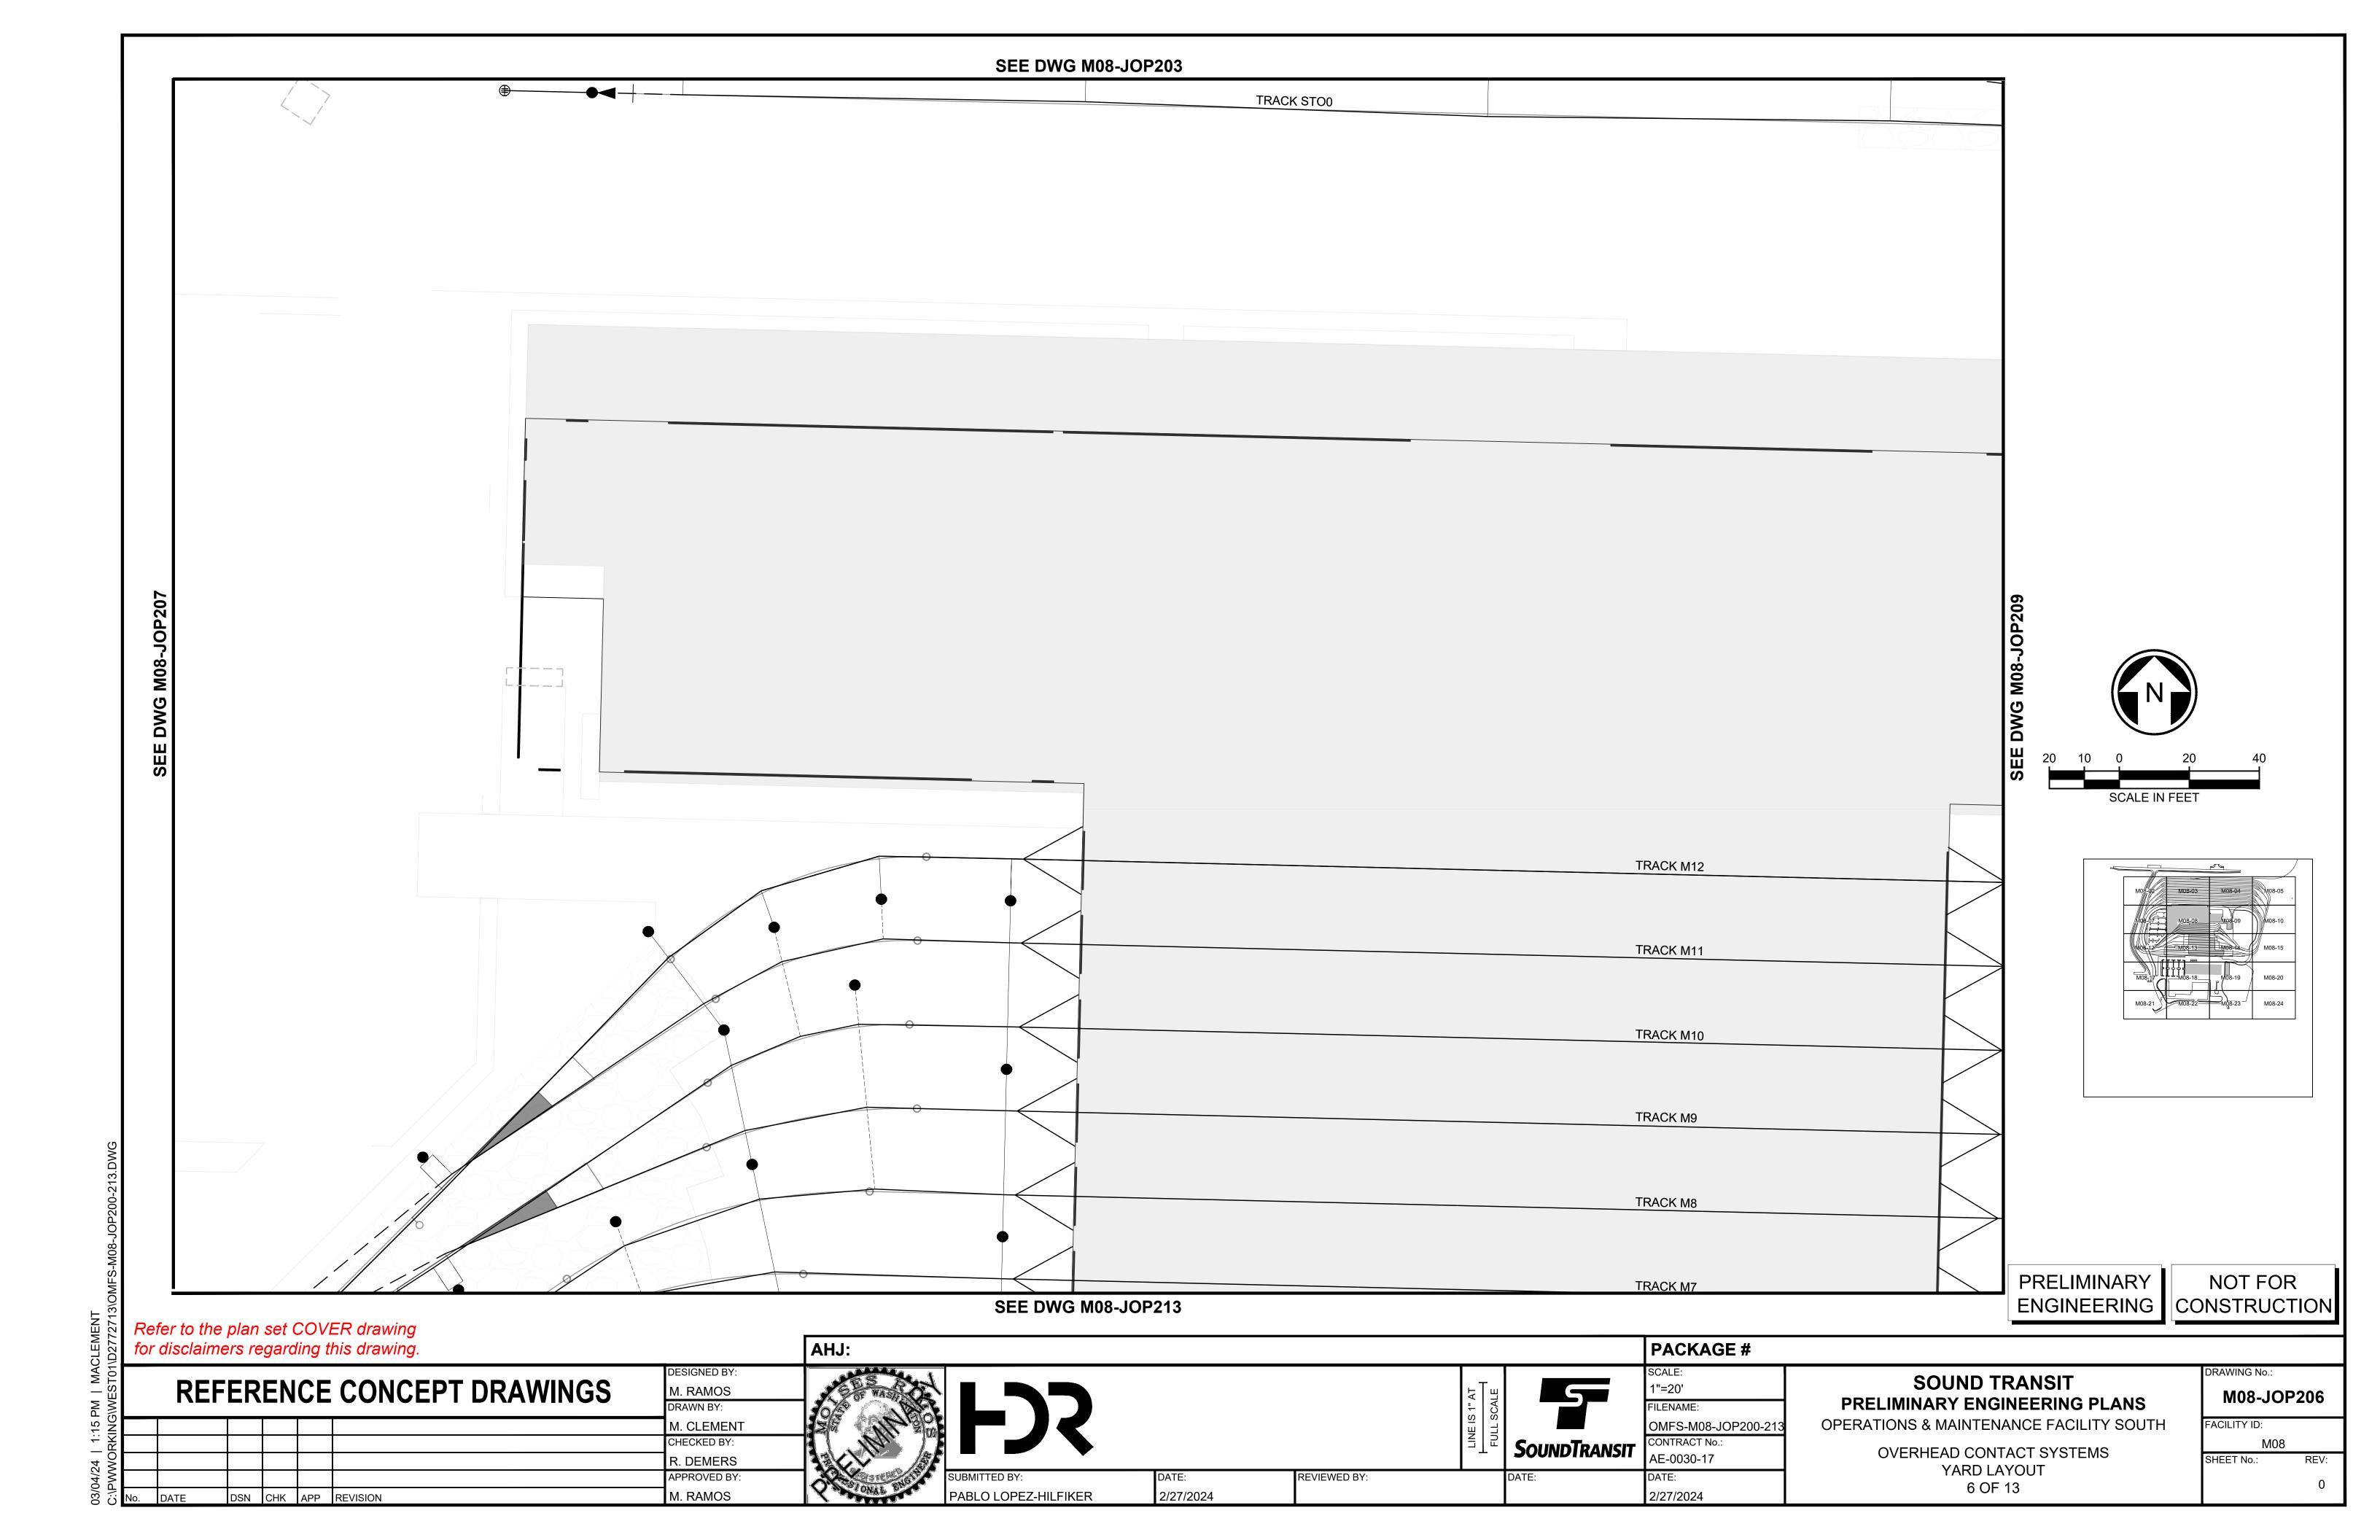


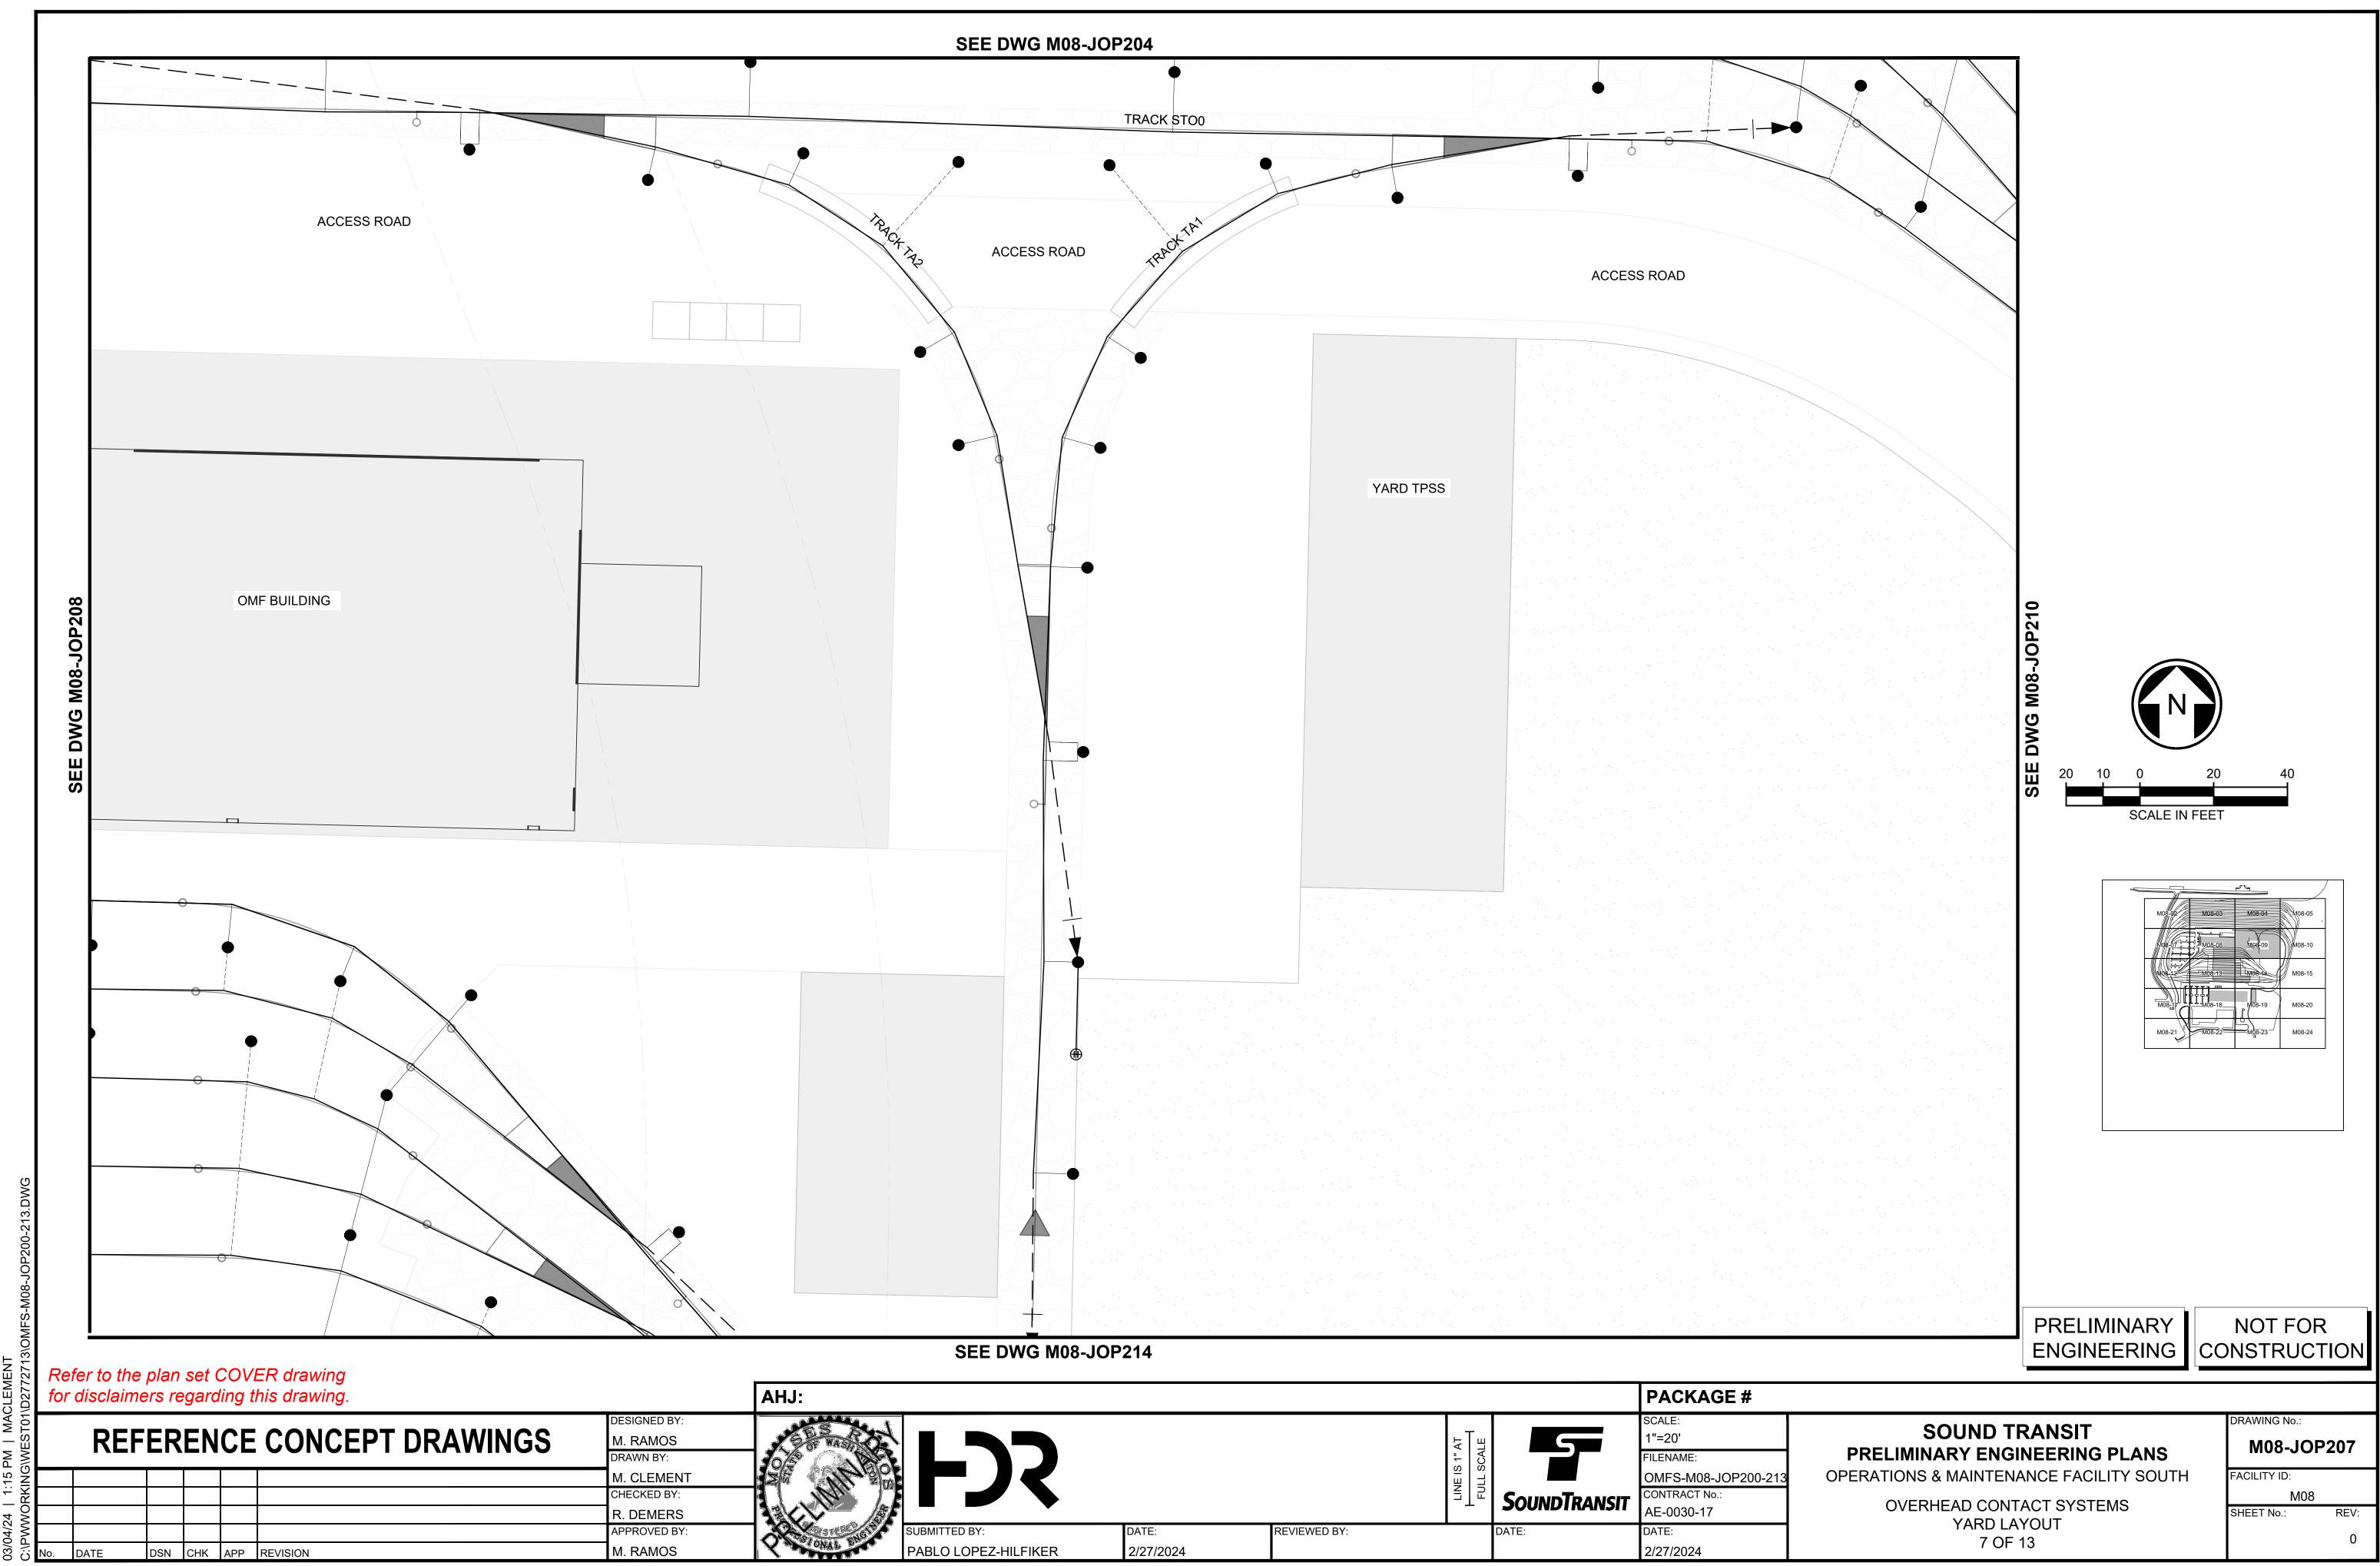


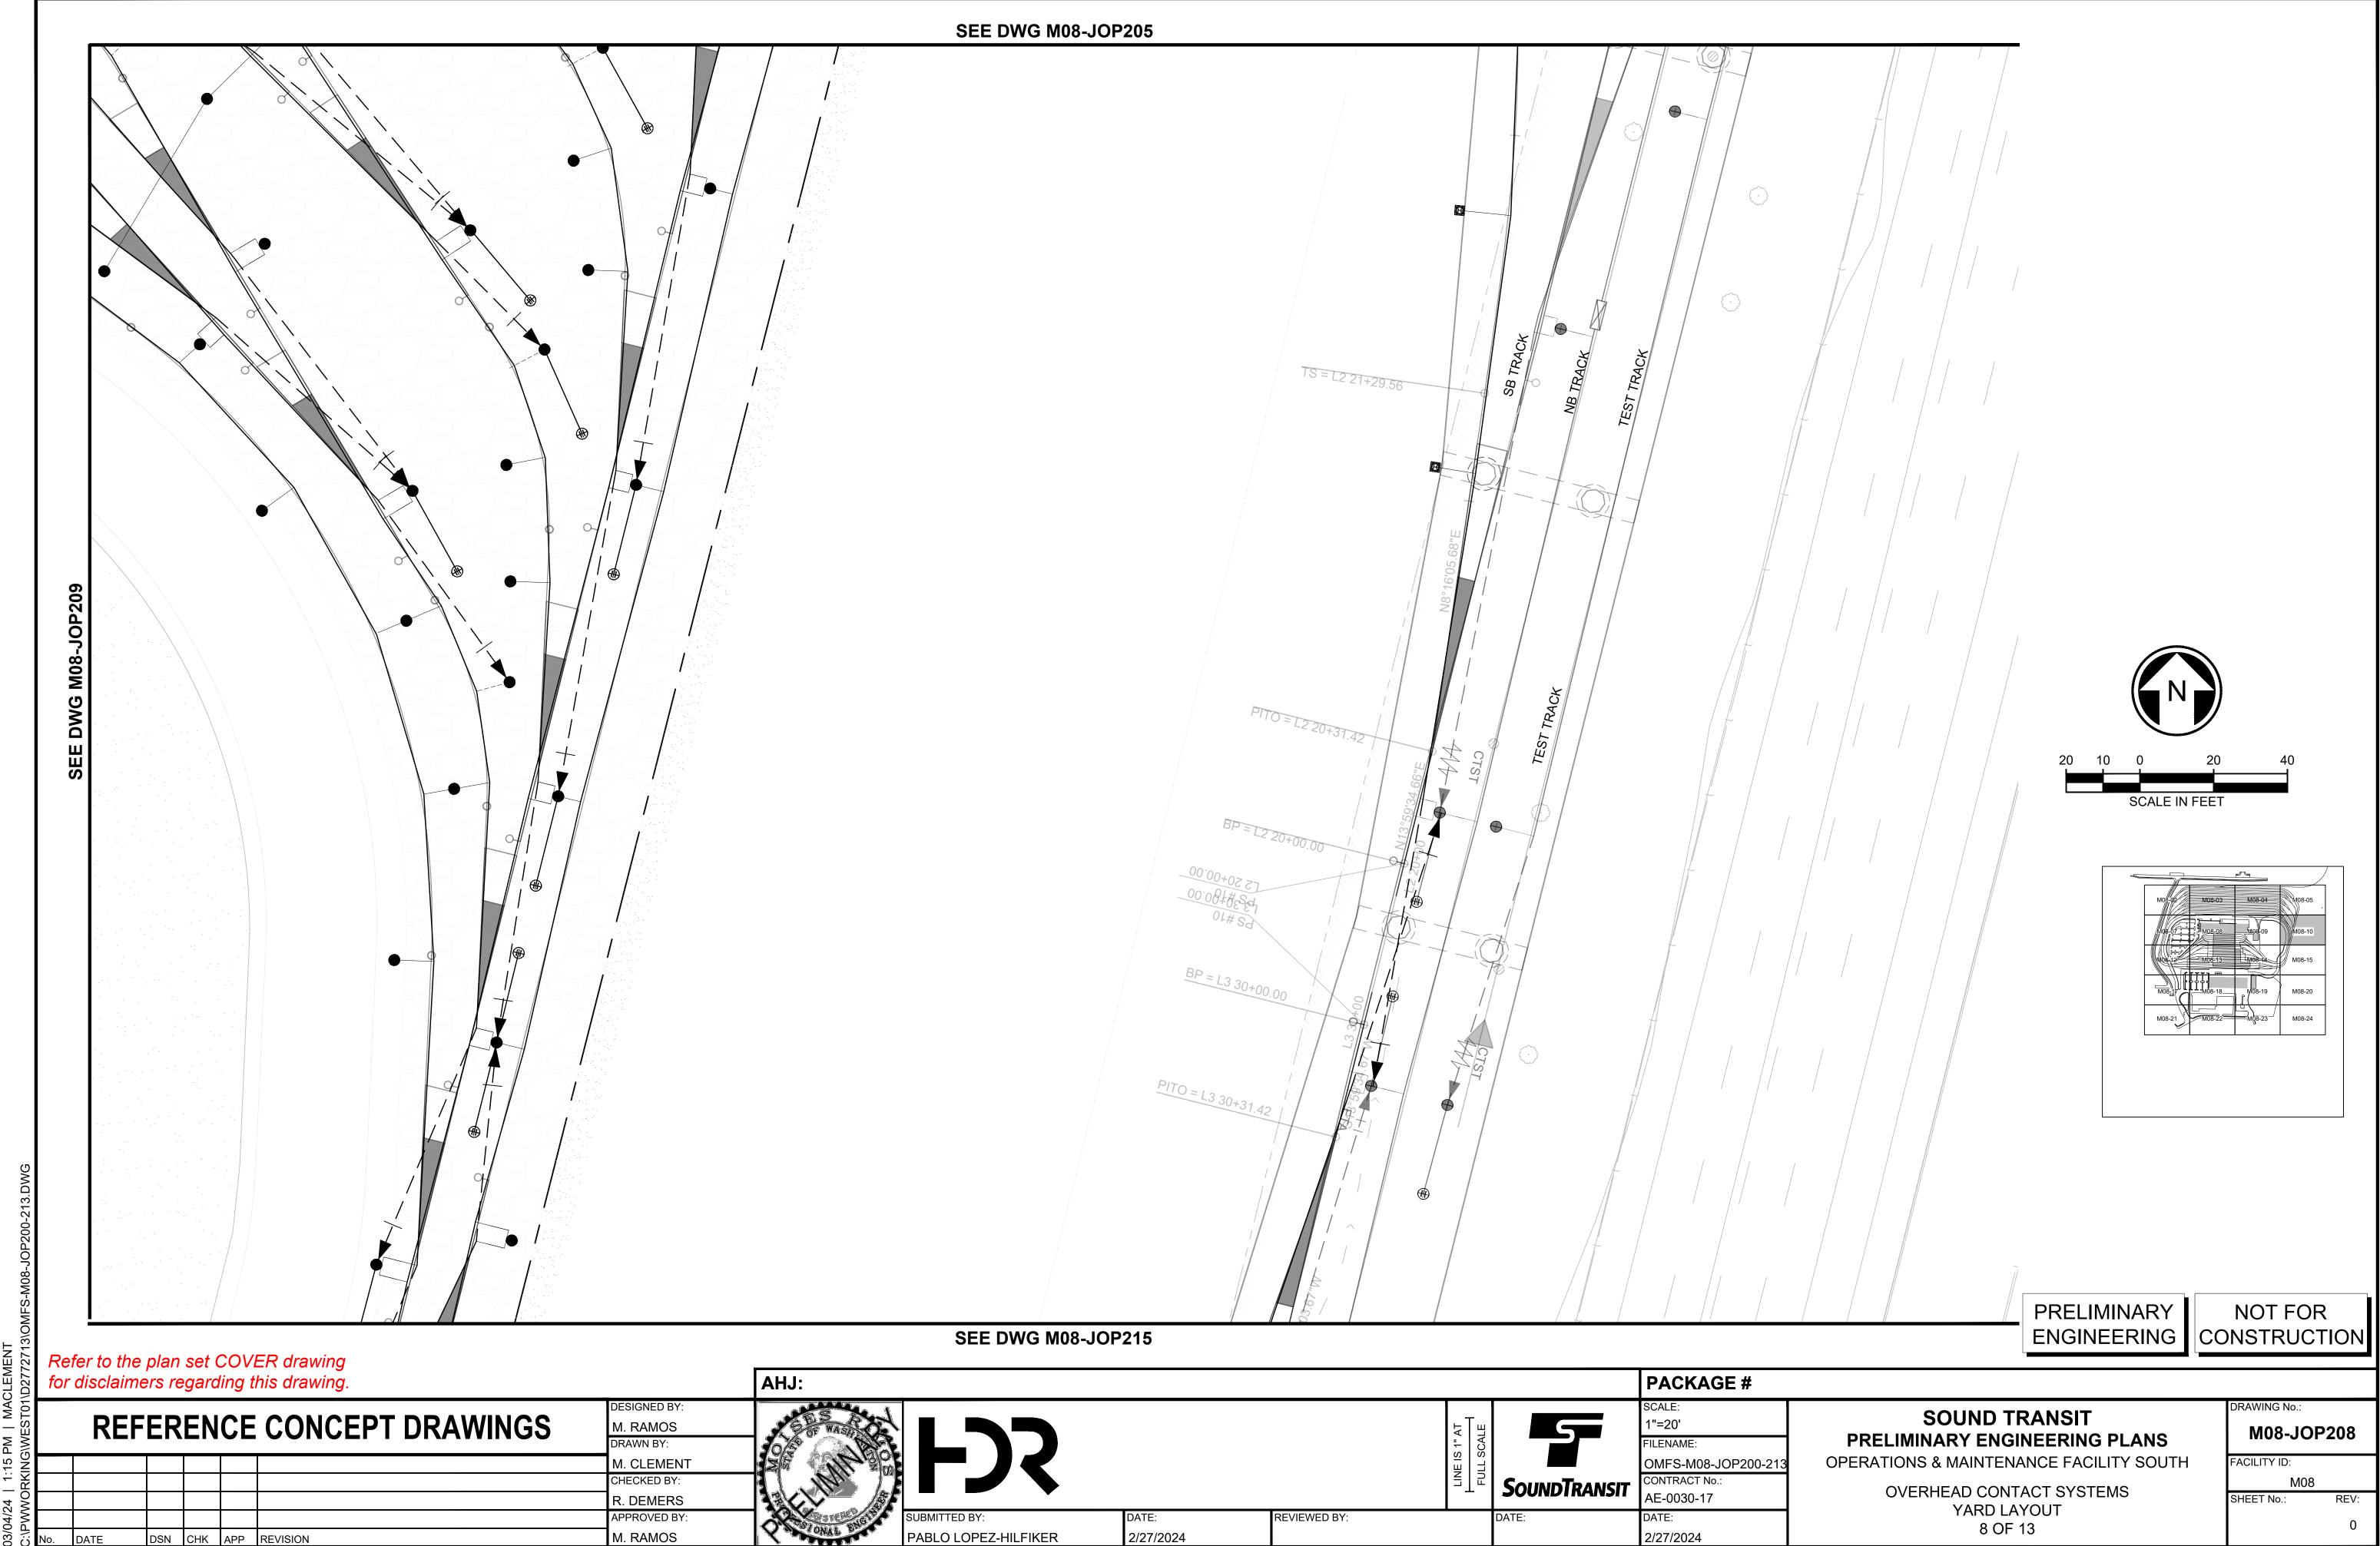


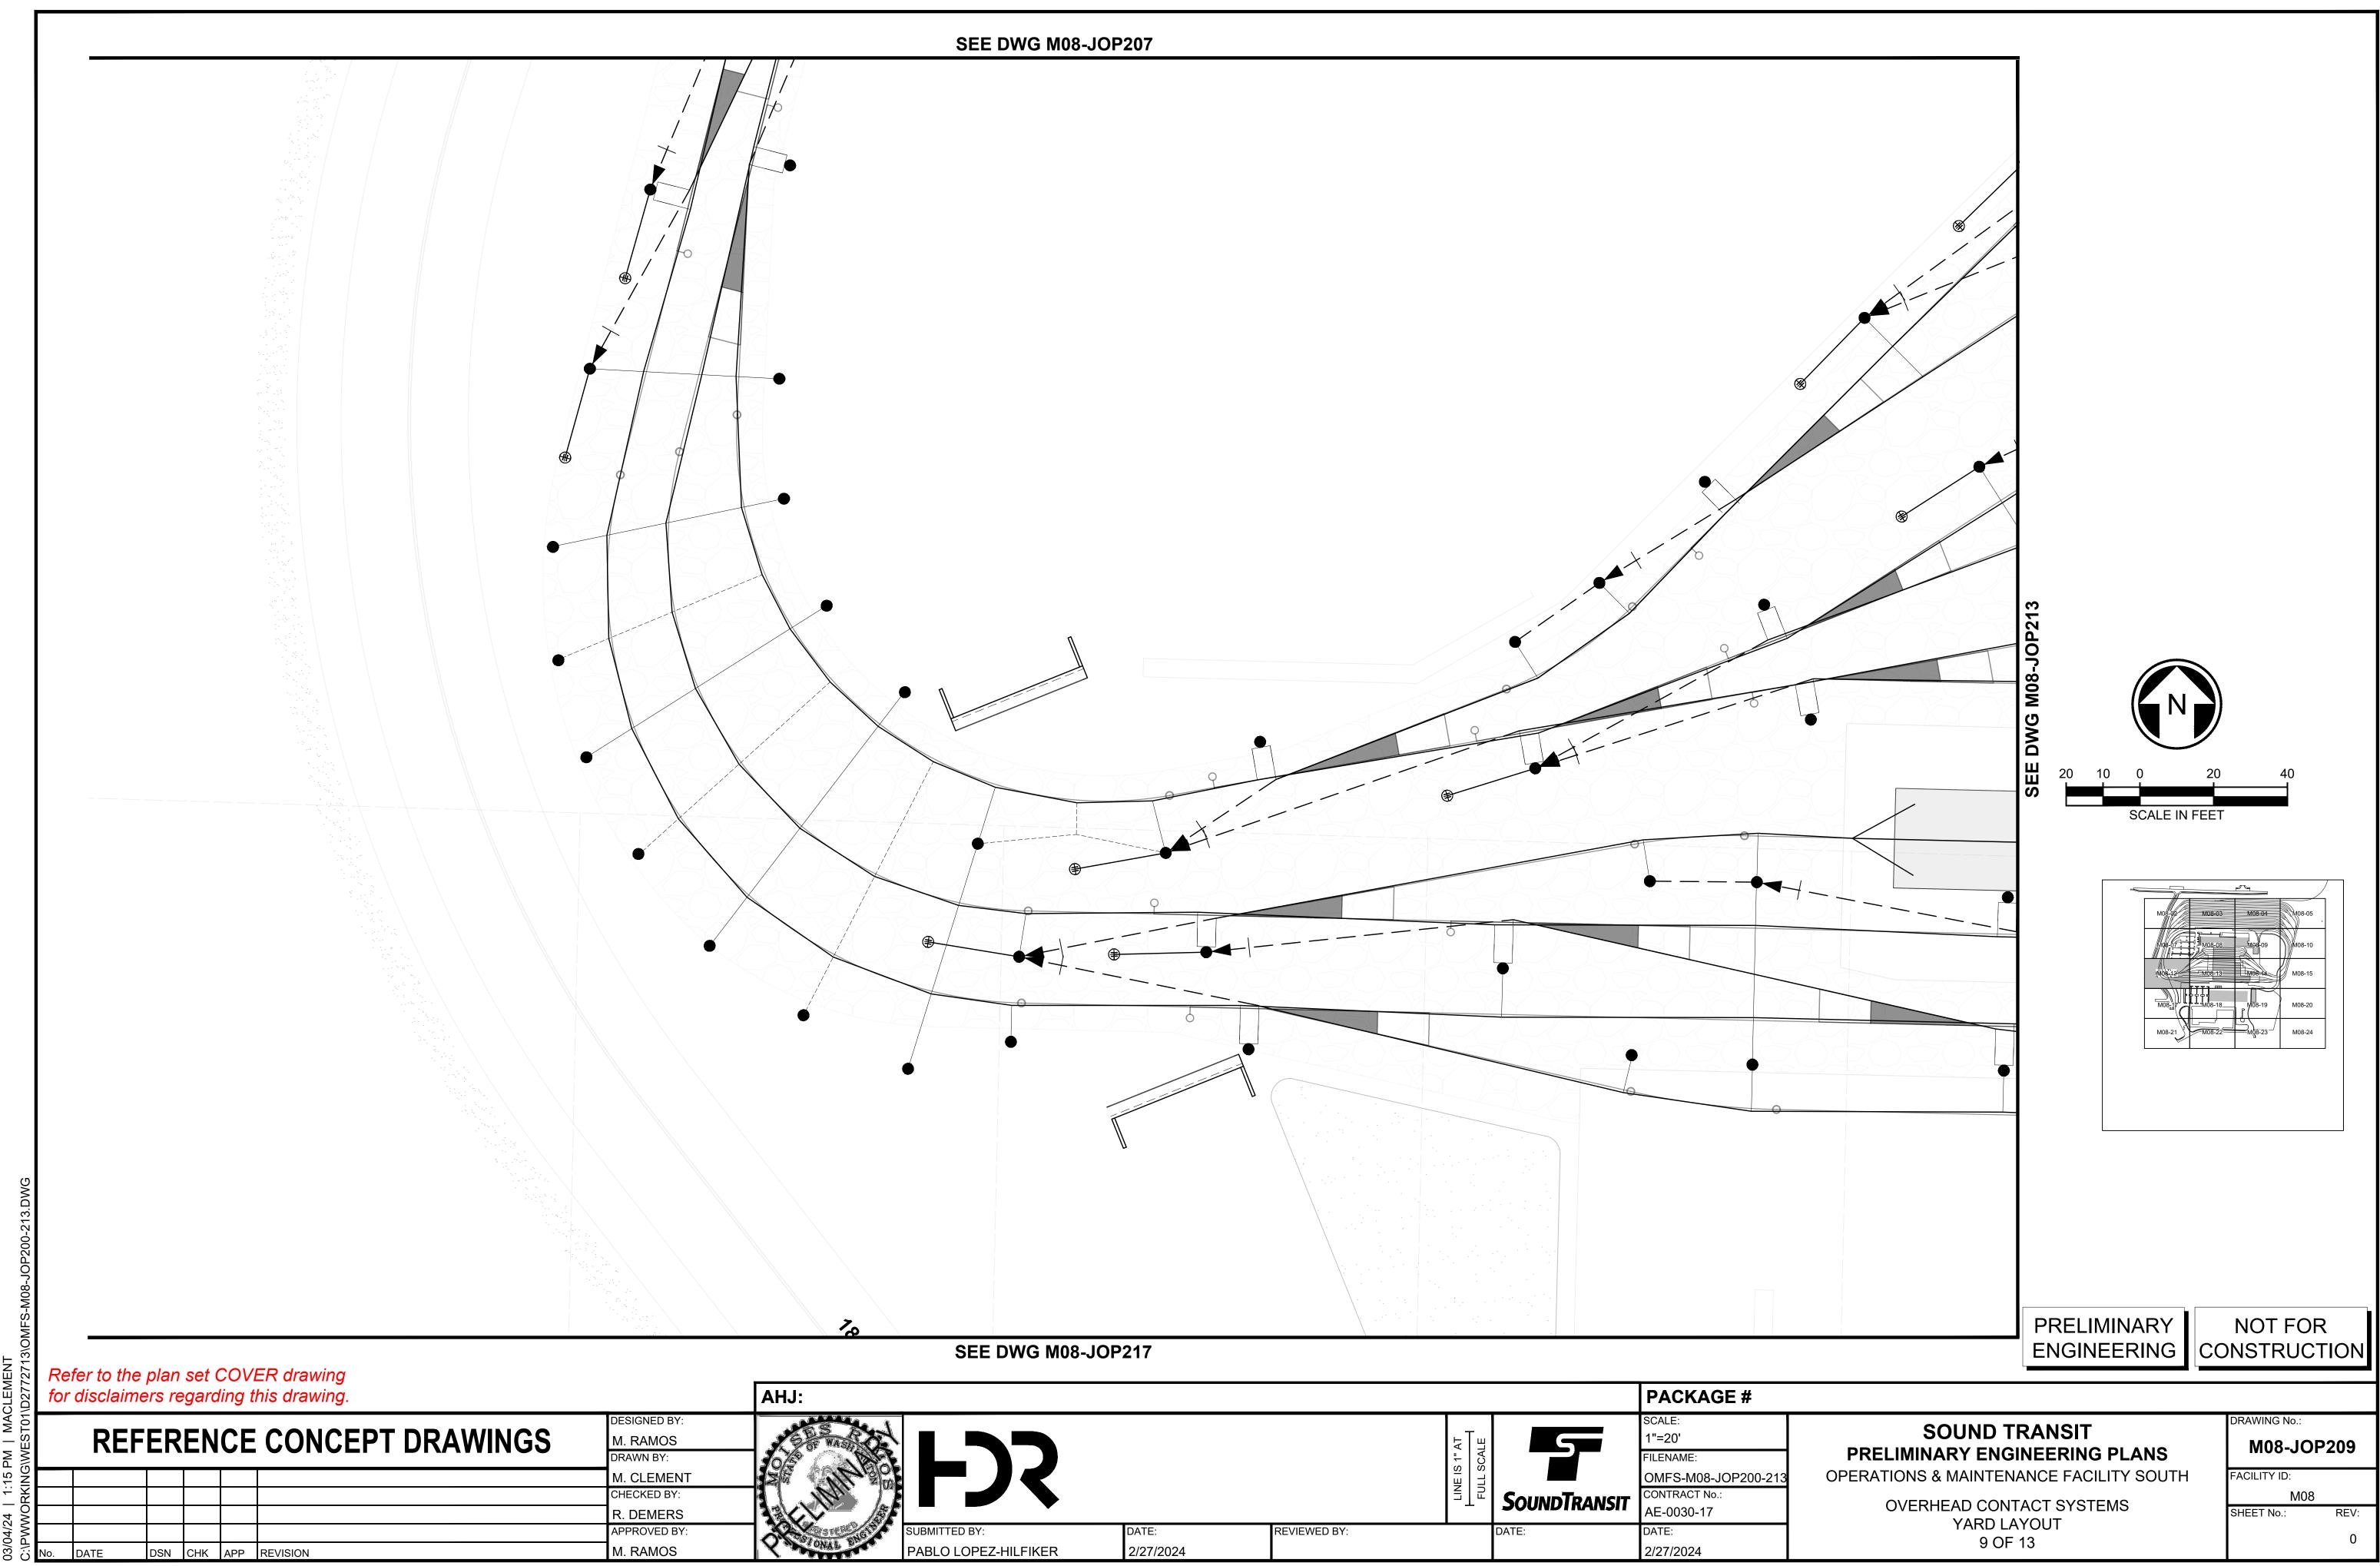


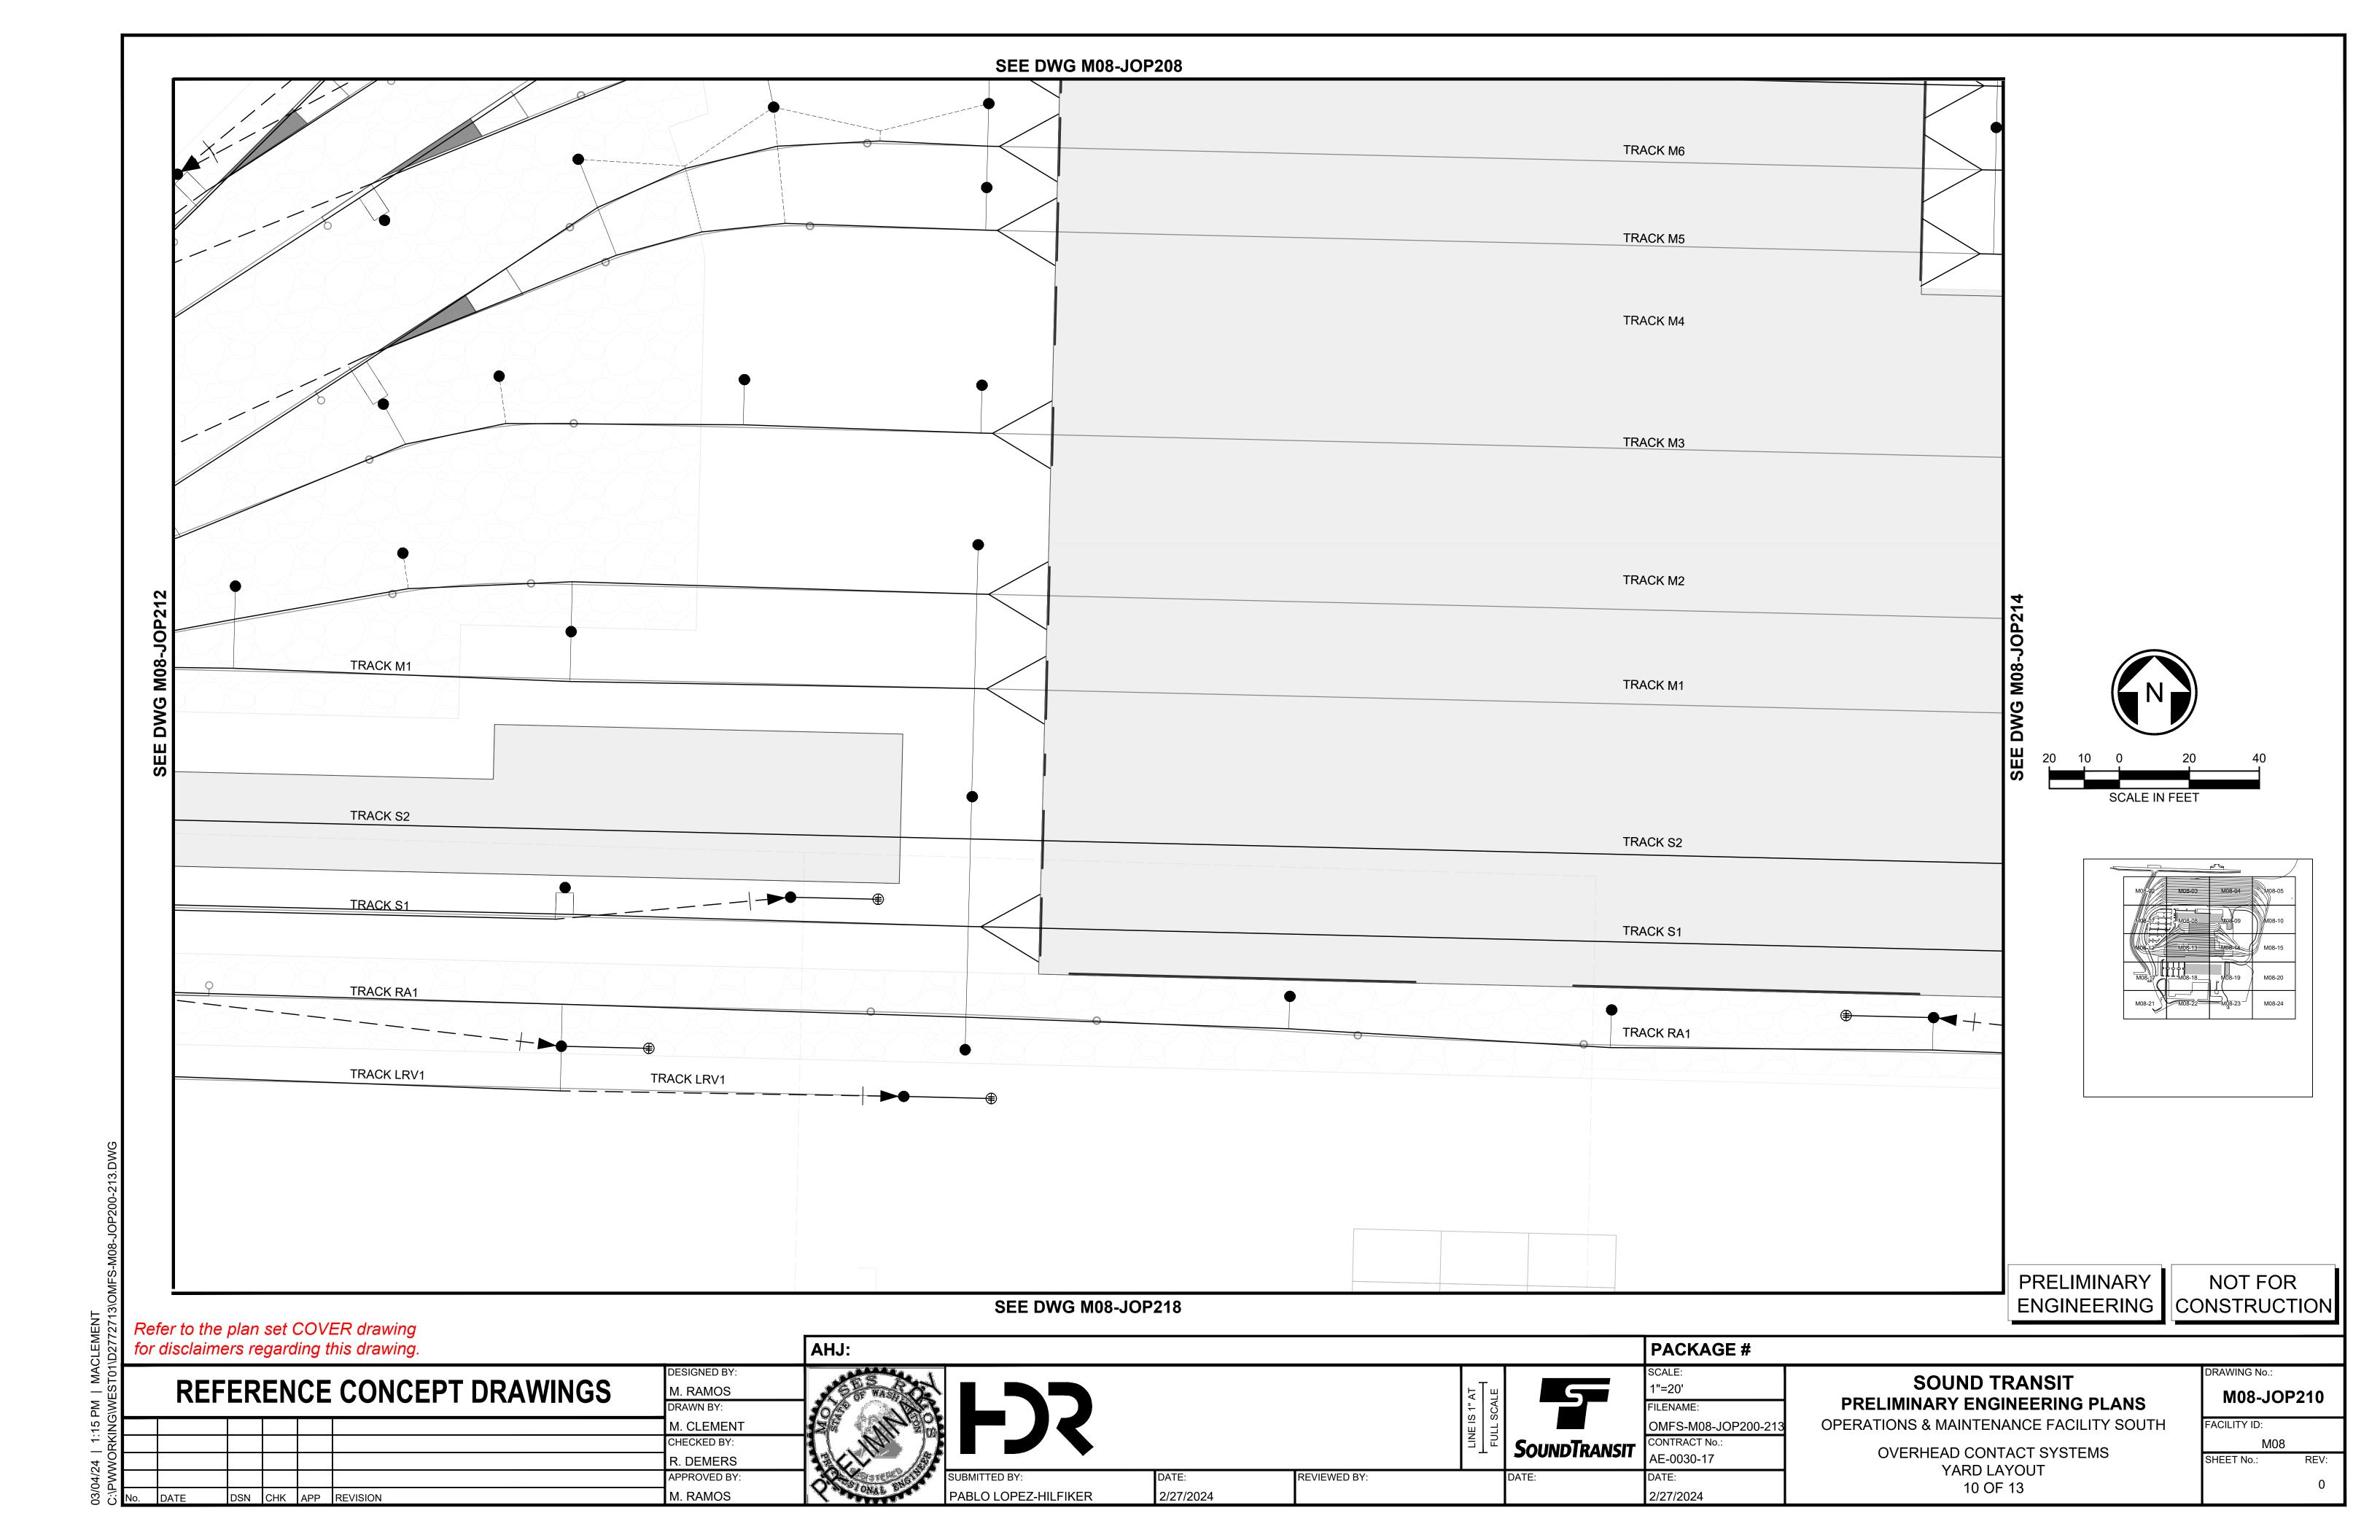


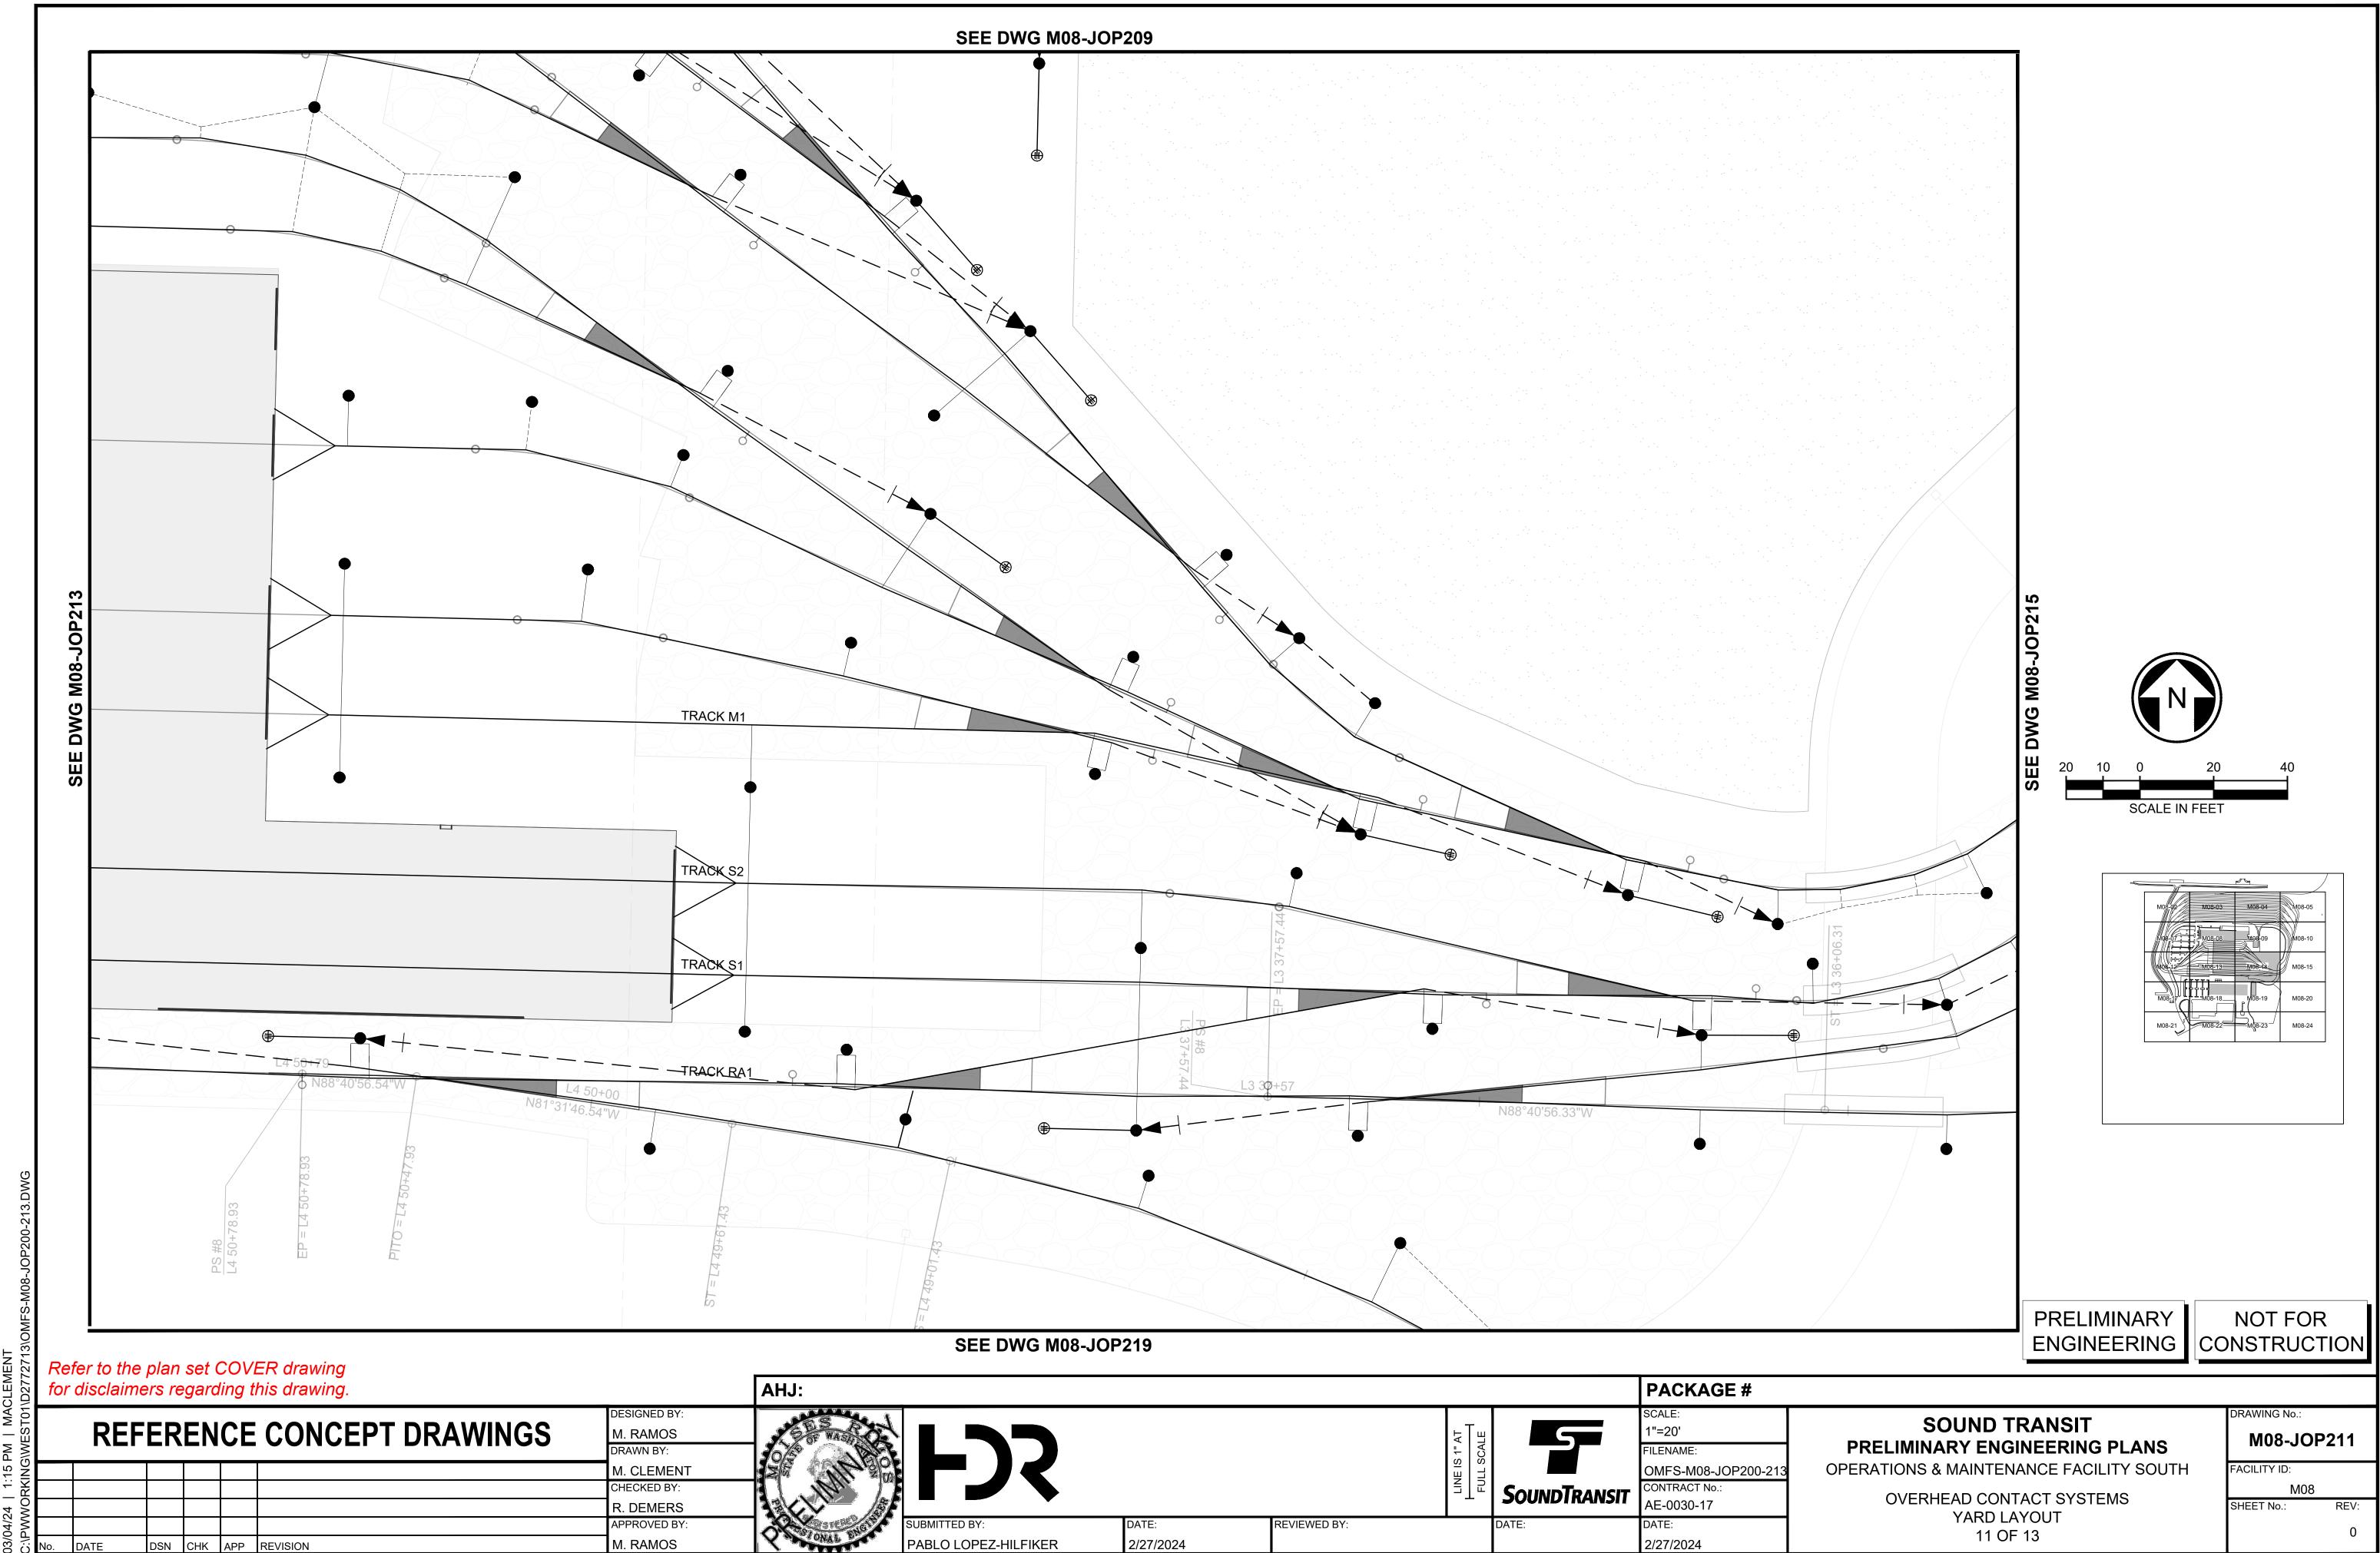

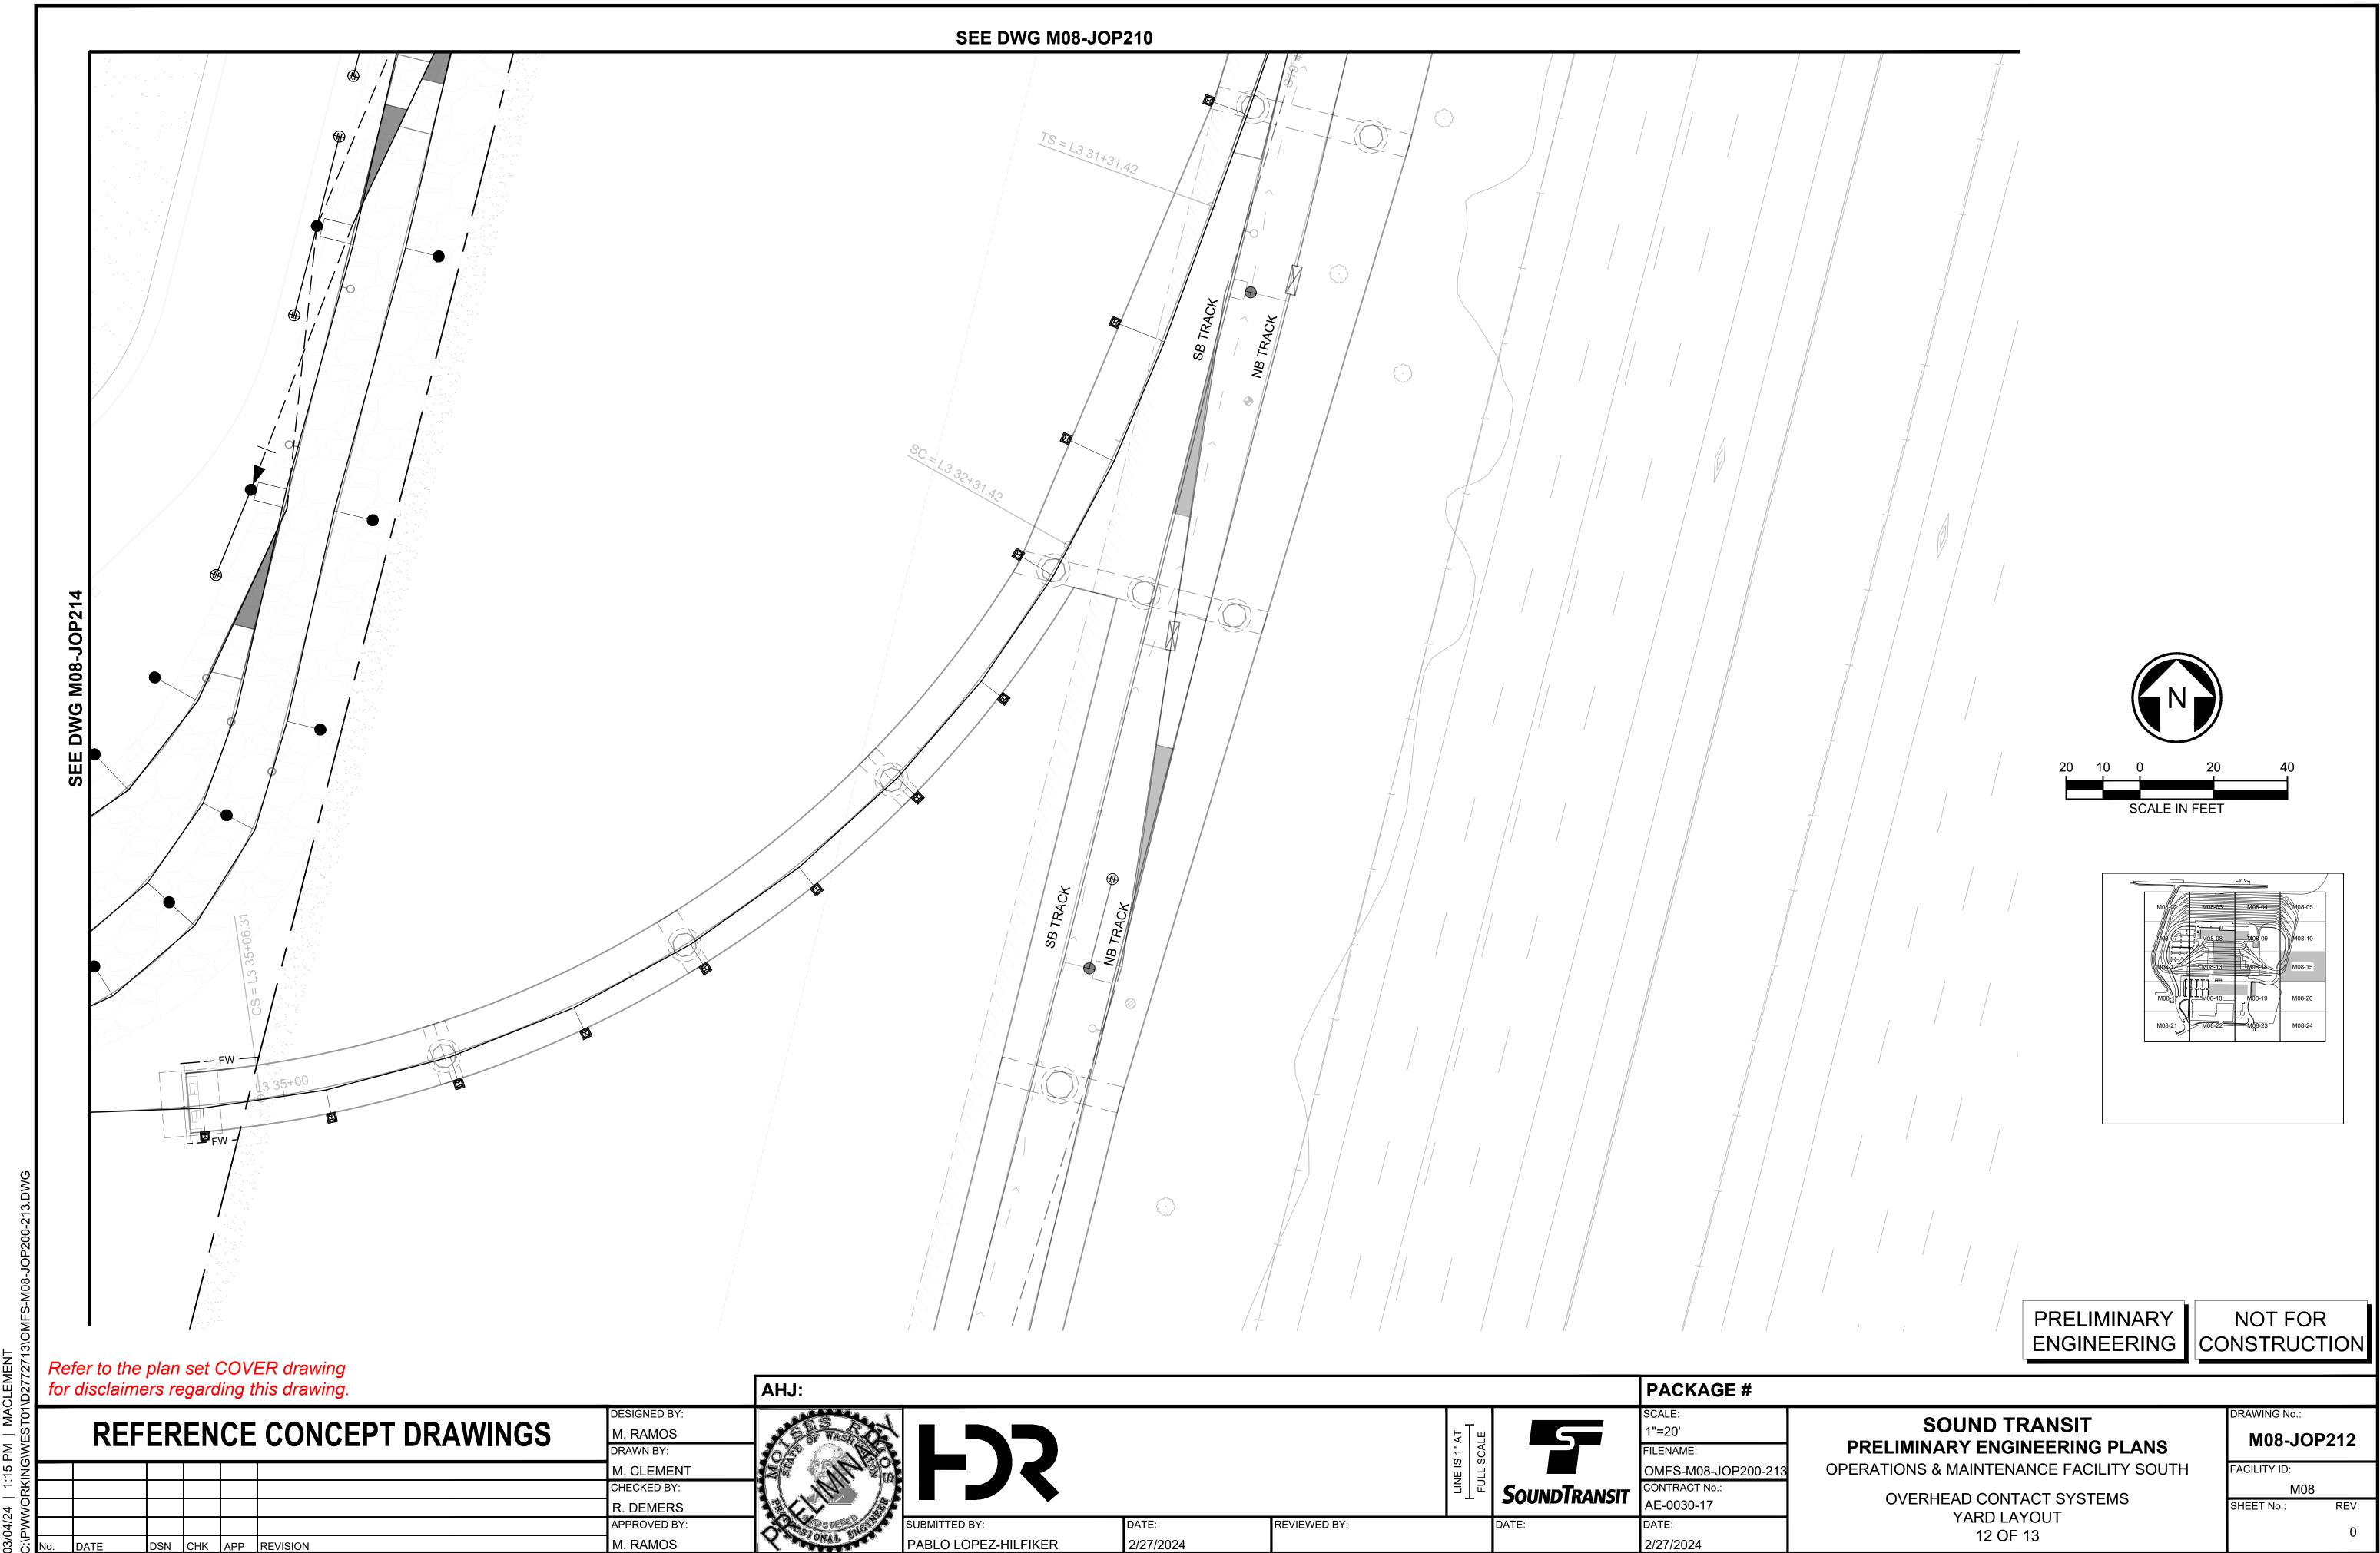

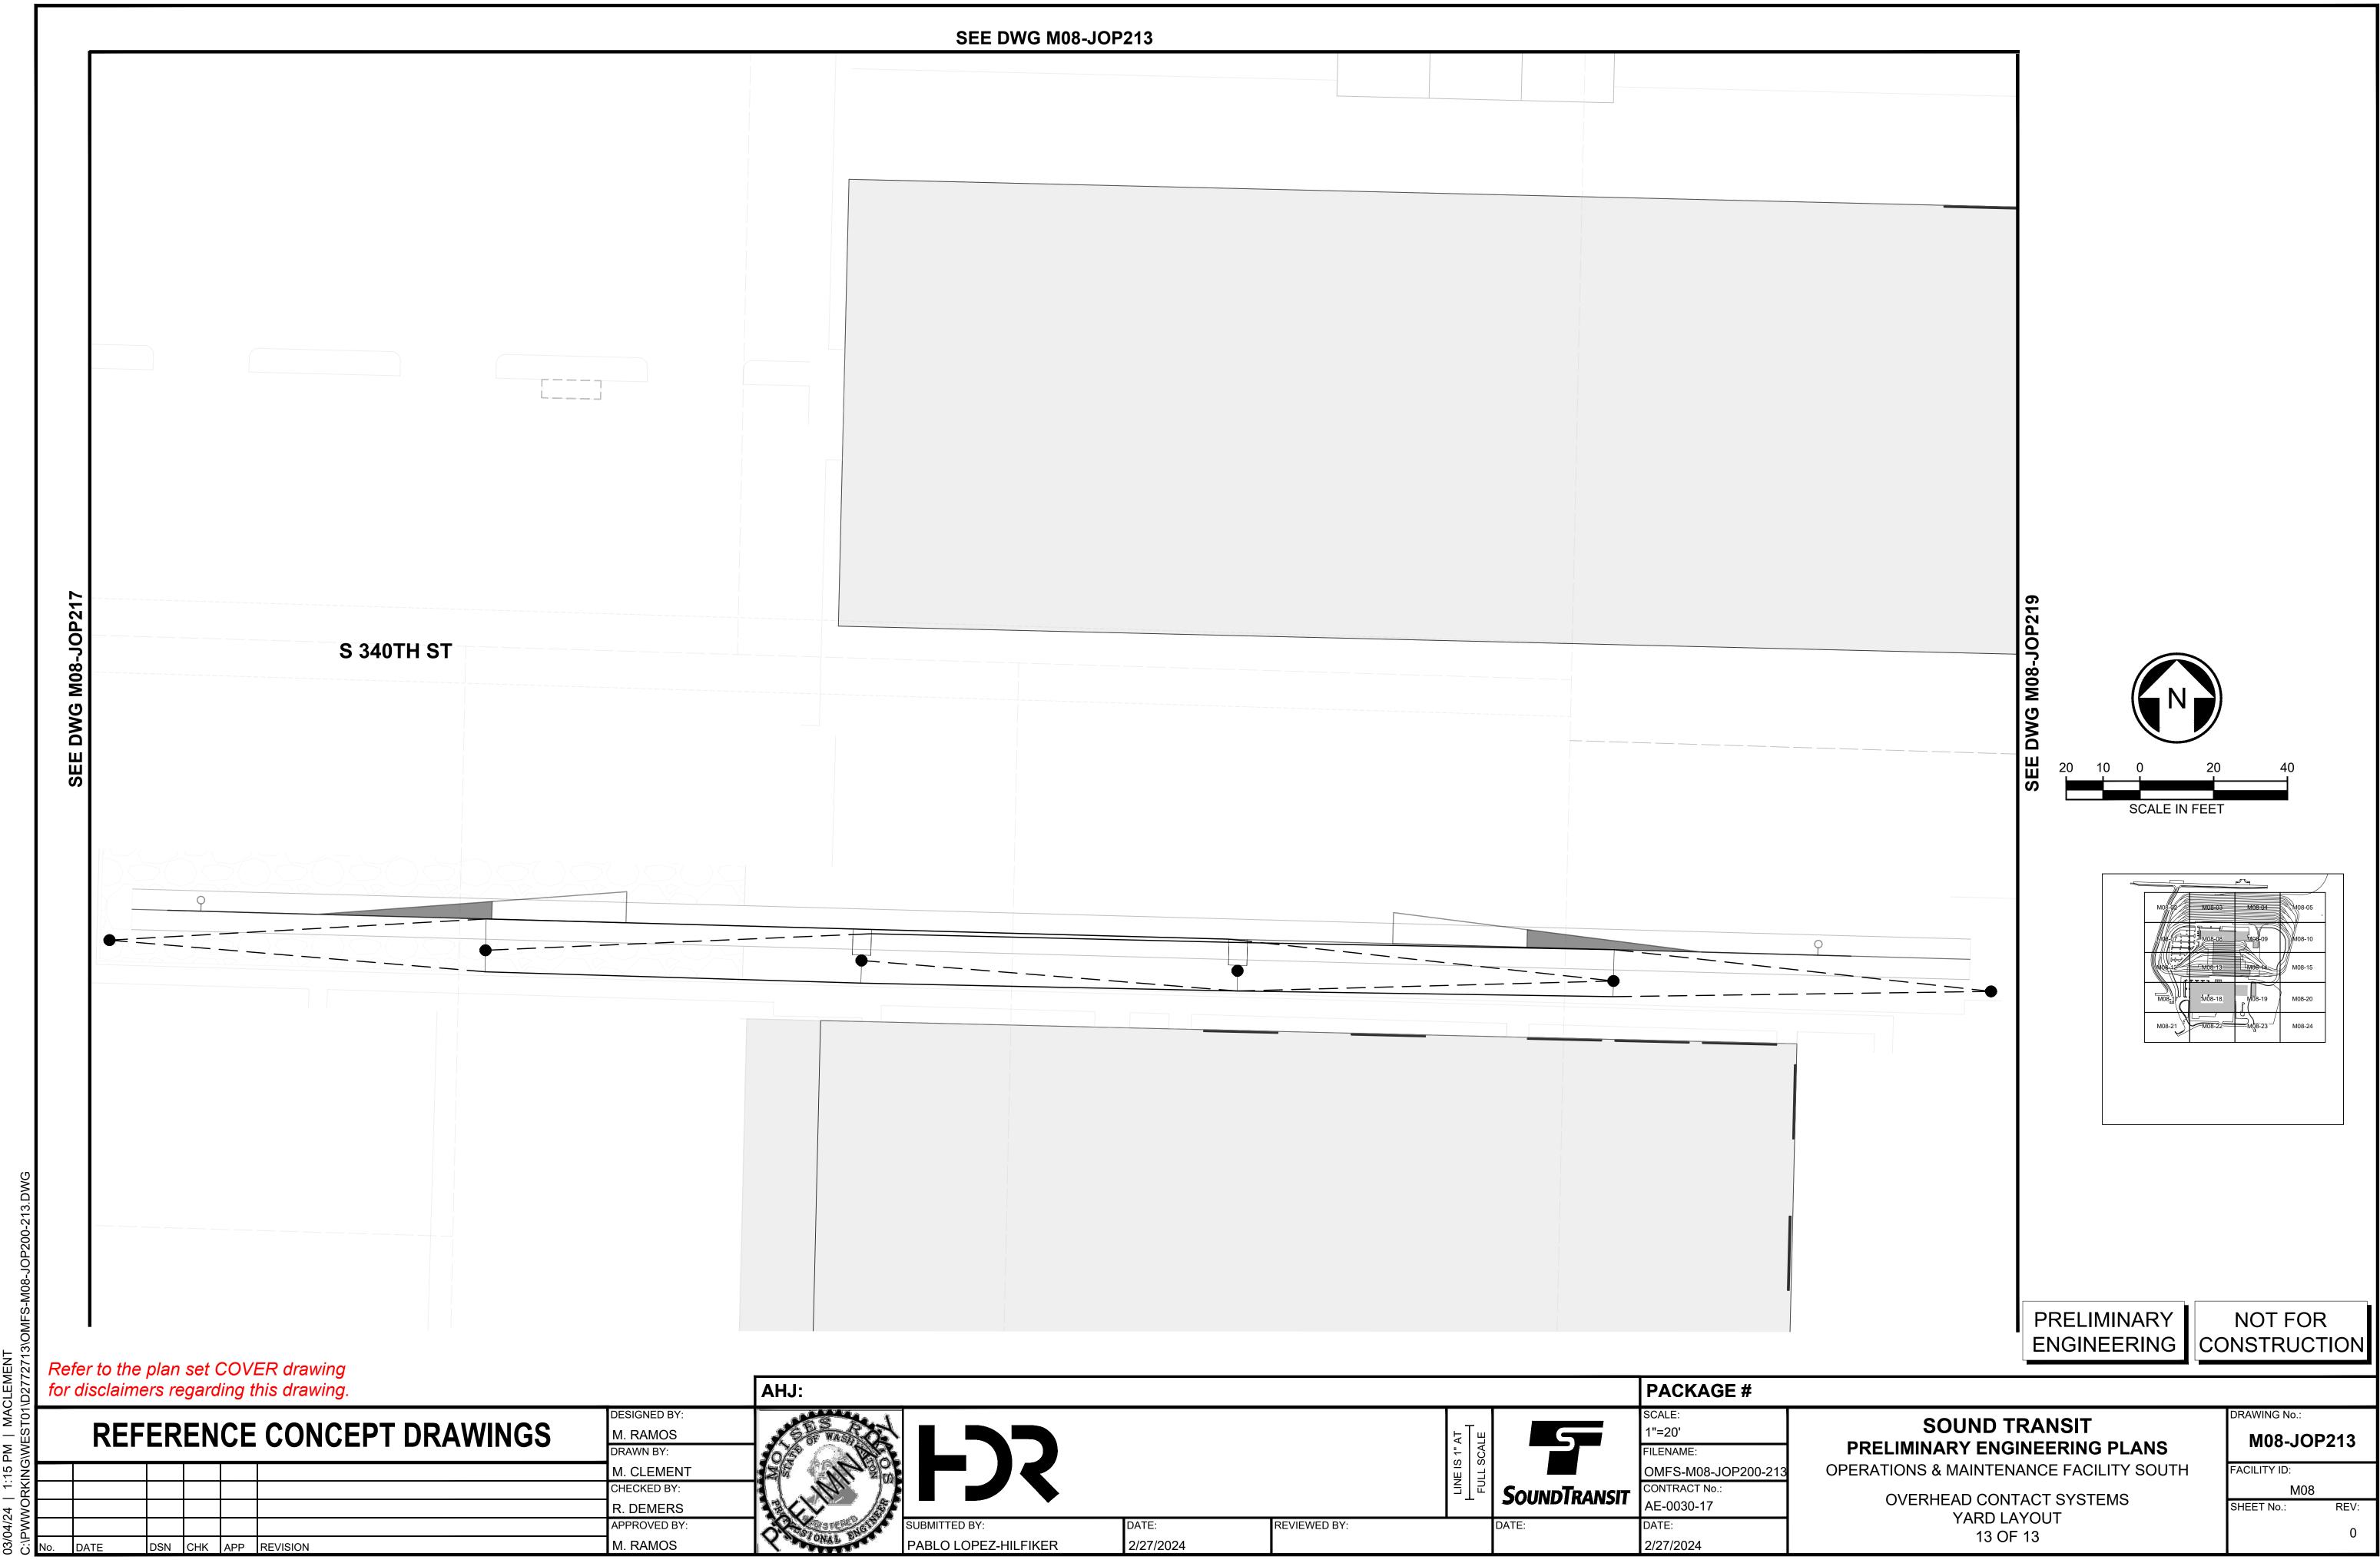

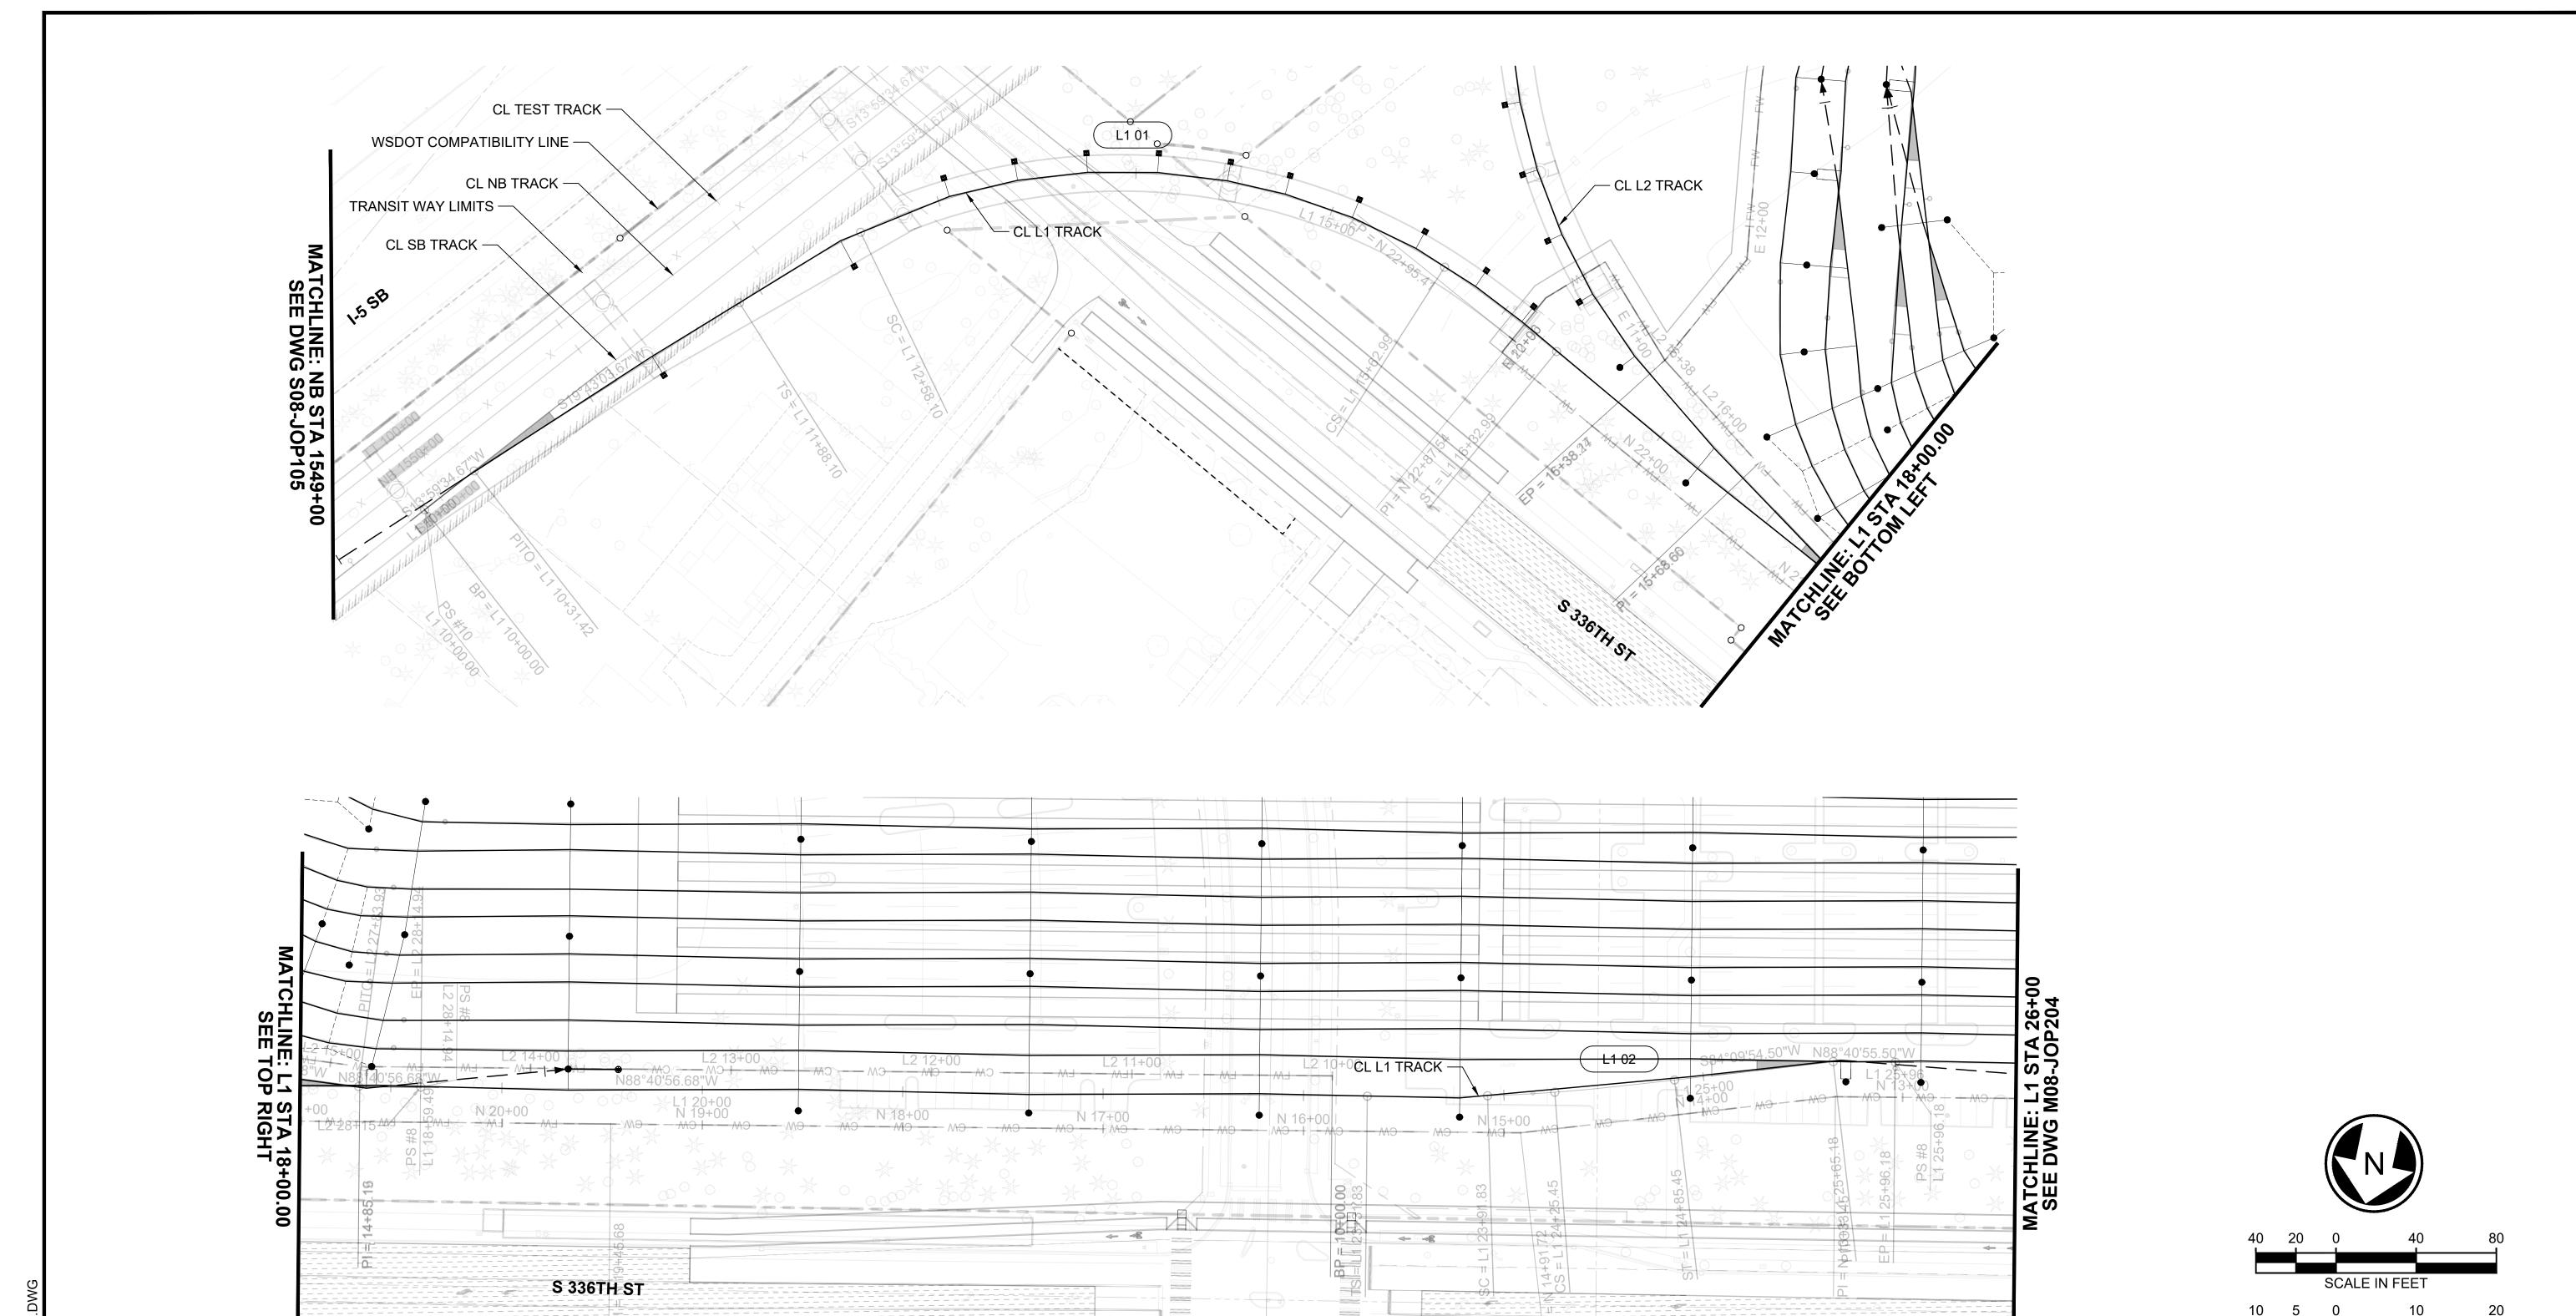

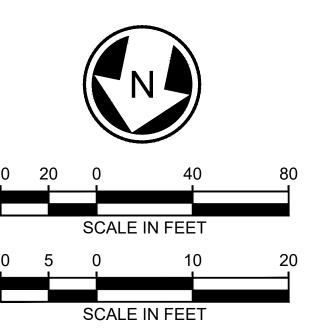

LEAD TRACK L1 LAYOUT

L1 STA 10+00 TO 25+96.12

NOT FOR CONSTRUCTION

M08

Refer to the plan set COVER drawing for disclaimers regarding this drawing. PACKAGE # AHJ: **DESIGNED BY** RAWING No.: **SOUND TRANSIT** REFERENCE CONCEPT DRAWINGS 5 1"=40' M. RAMOS M08-JOP300 PRELIMINARY ENGINEERING PLANS DRAWN BY: FILENAME: **OPERATIONS & MAINTENANCE FACILITY SOUTH** M. CLEMENT OMFS-M08-JOP300-303 FACILITY ID: CHECKED BY: CONTRACT No.: SOUNDTRANSIT OVERHEAD CONTACT SYSTEMS AE-0030-17 R. DEMERS SHEET No.:

2/27/2024

PABLO LOPEZ-HILFIKER


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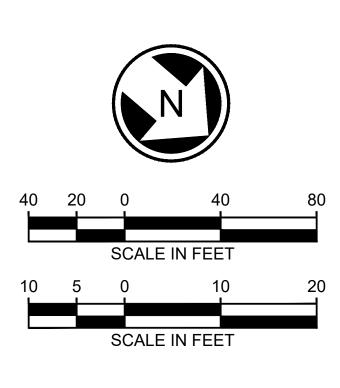
2/27/2024

2/27/2024

APPROVED BY:

M. RAMOS



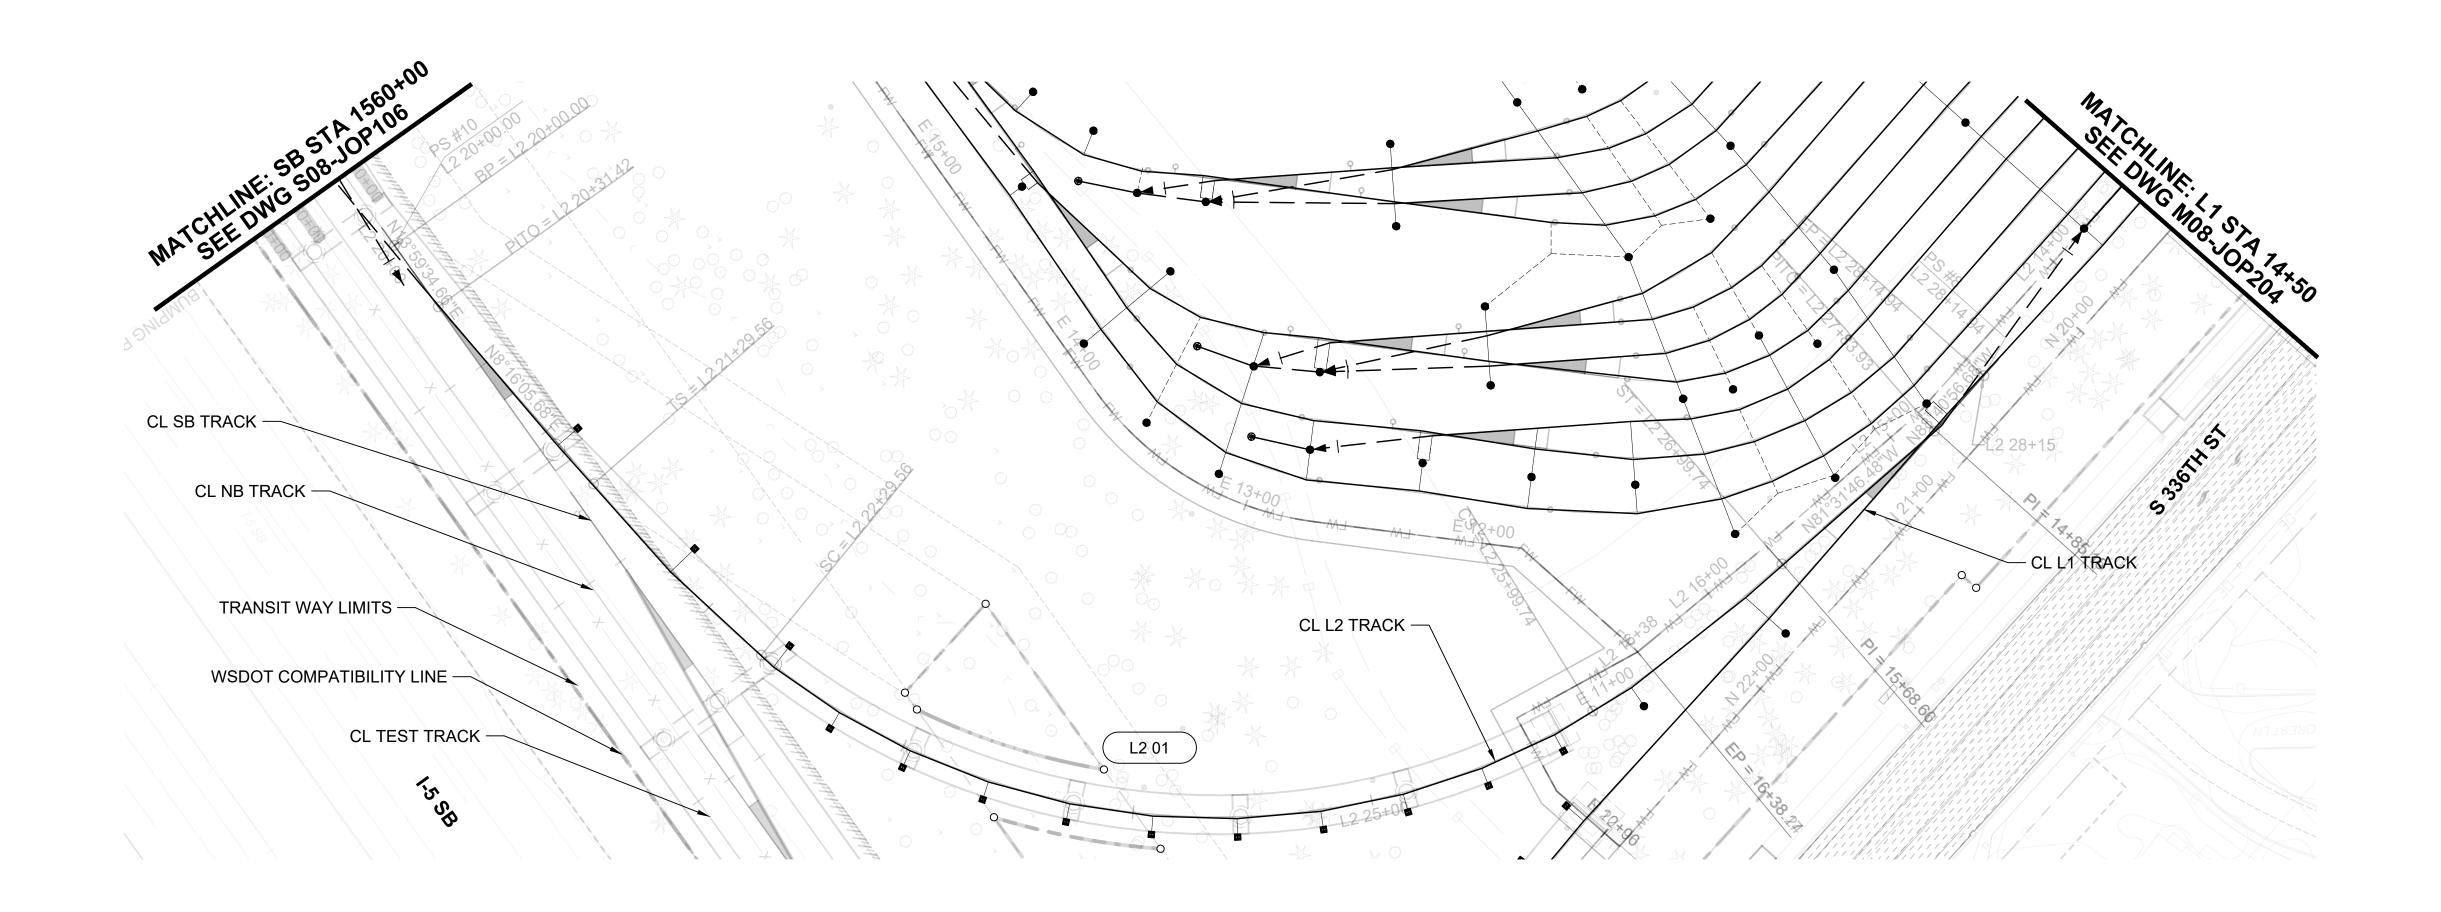

Refer to the plan set COVER drawing for disclaimers regarding this drawing.

						DESIGNED BY:
	REFERENCE CONCEPT DRAWINGS					M. RAMOS
						DRAWN BY:
						M. CLEMENT
						CHECKED BY:
						R. DEMERS
						APPROVED BY:
No.	DATE	DSN	CHK	APP	REVISION	M. RAMOS

PABLO LOPEZ-HILFIKER

AHJ:

REVIEWED BY:

2/27/2024

5 SoundTransit

2/27/2024


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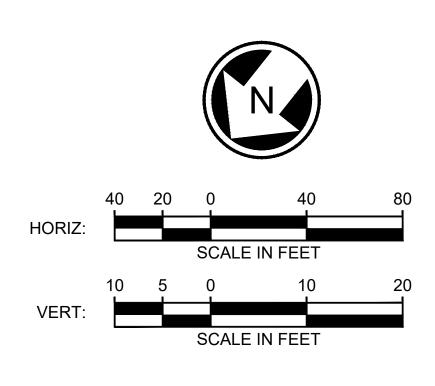
2/27/2024

SOUND TRANSIT PRELIMINARY ENGINEERING PLANS OPERATIONS & MAINTENANCE FACILITY SOUTH

OVERHEAD CONTACT SYSTEMS LEAD TRACK L2 LAYOUT L2 STA 20+00 TO 28+47.92

DRAWING No.: M08-JOP301 FACILITY ID:



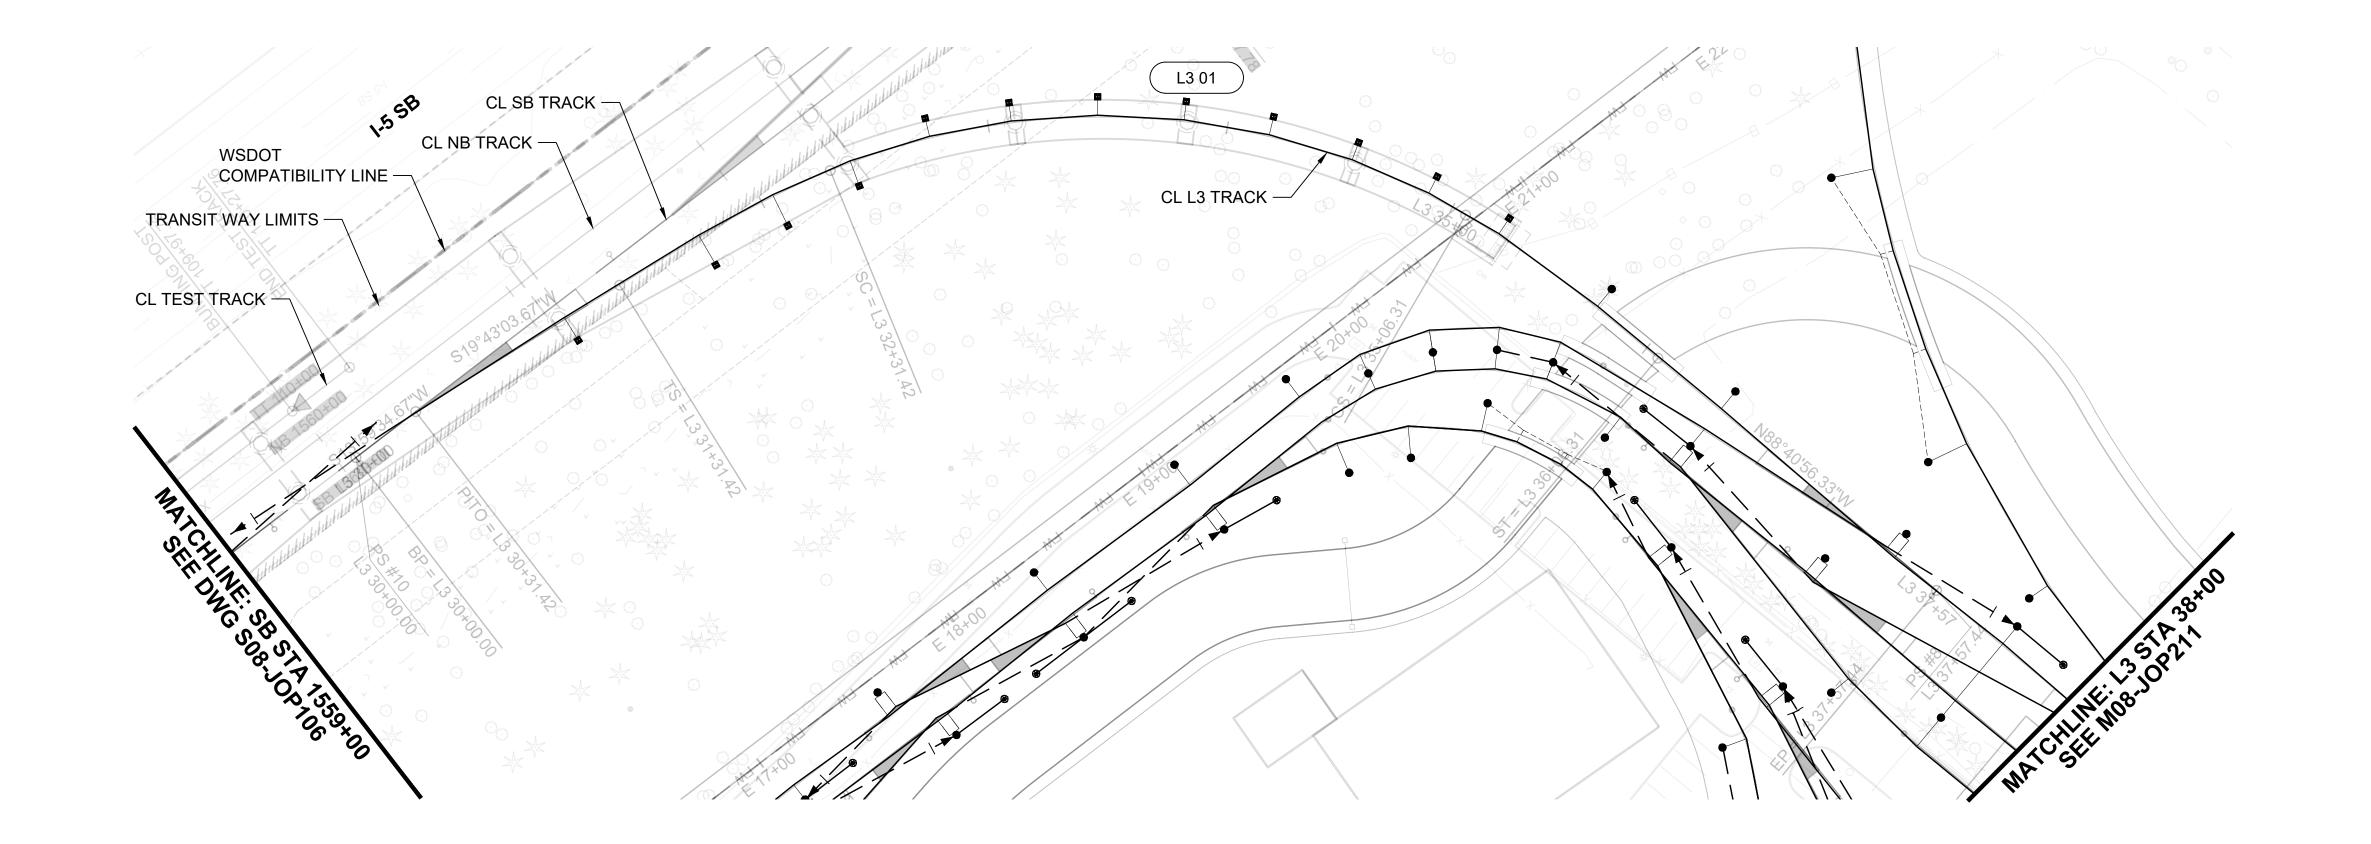

Refer to the plan set COVER drawing for disclaimers regarding this drawing.

DESIGNED BY: REFERENCE CONCEPT DRAWINGS M. RAMOS DRAWN BY: M. CLEMENT CHECKED BY: R. DEMERS APPROVED BY: M. RAMOS

AHJ: PABLO LOPEZ-HILFIKER

REVIEWED BY:

2/27/2024

5 SoundTransit

2/27/2024

1"=40' FILENAME: OMFS-M08-JOP300-303 CONTRACT No.: AE-0030-17

2/27/2024


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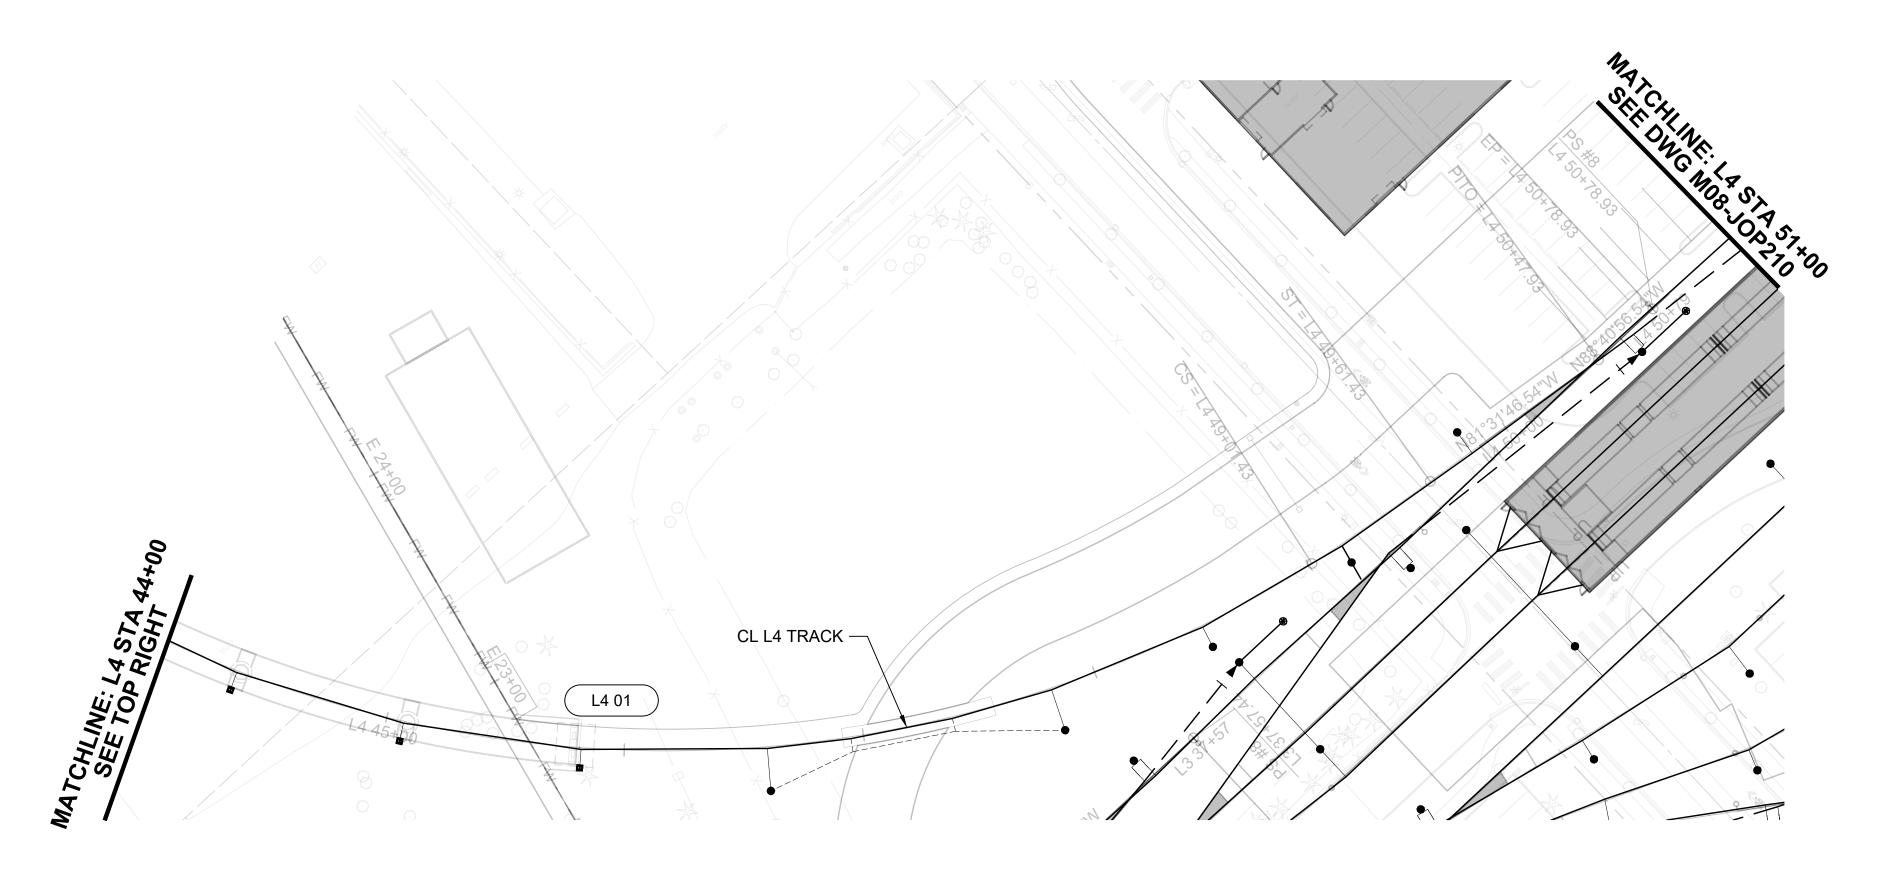
SOUND TRANSIT PRELIMINARY ENGINEERING PLANS OPERATIONS & MAINTENANCE FACILITY SOUTH


OVERHEAD CONTACT SYSTEMS LEAD TRACK L3 LAYOUT L3 STA 30+00 TO 37+57.44

DRAWING No.: M08-JOP302

FACILITY ID: M08 SHEET No.:



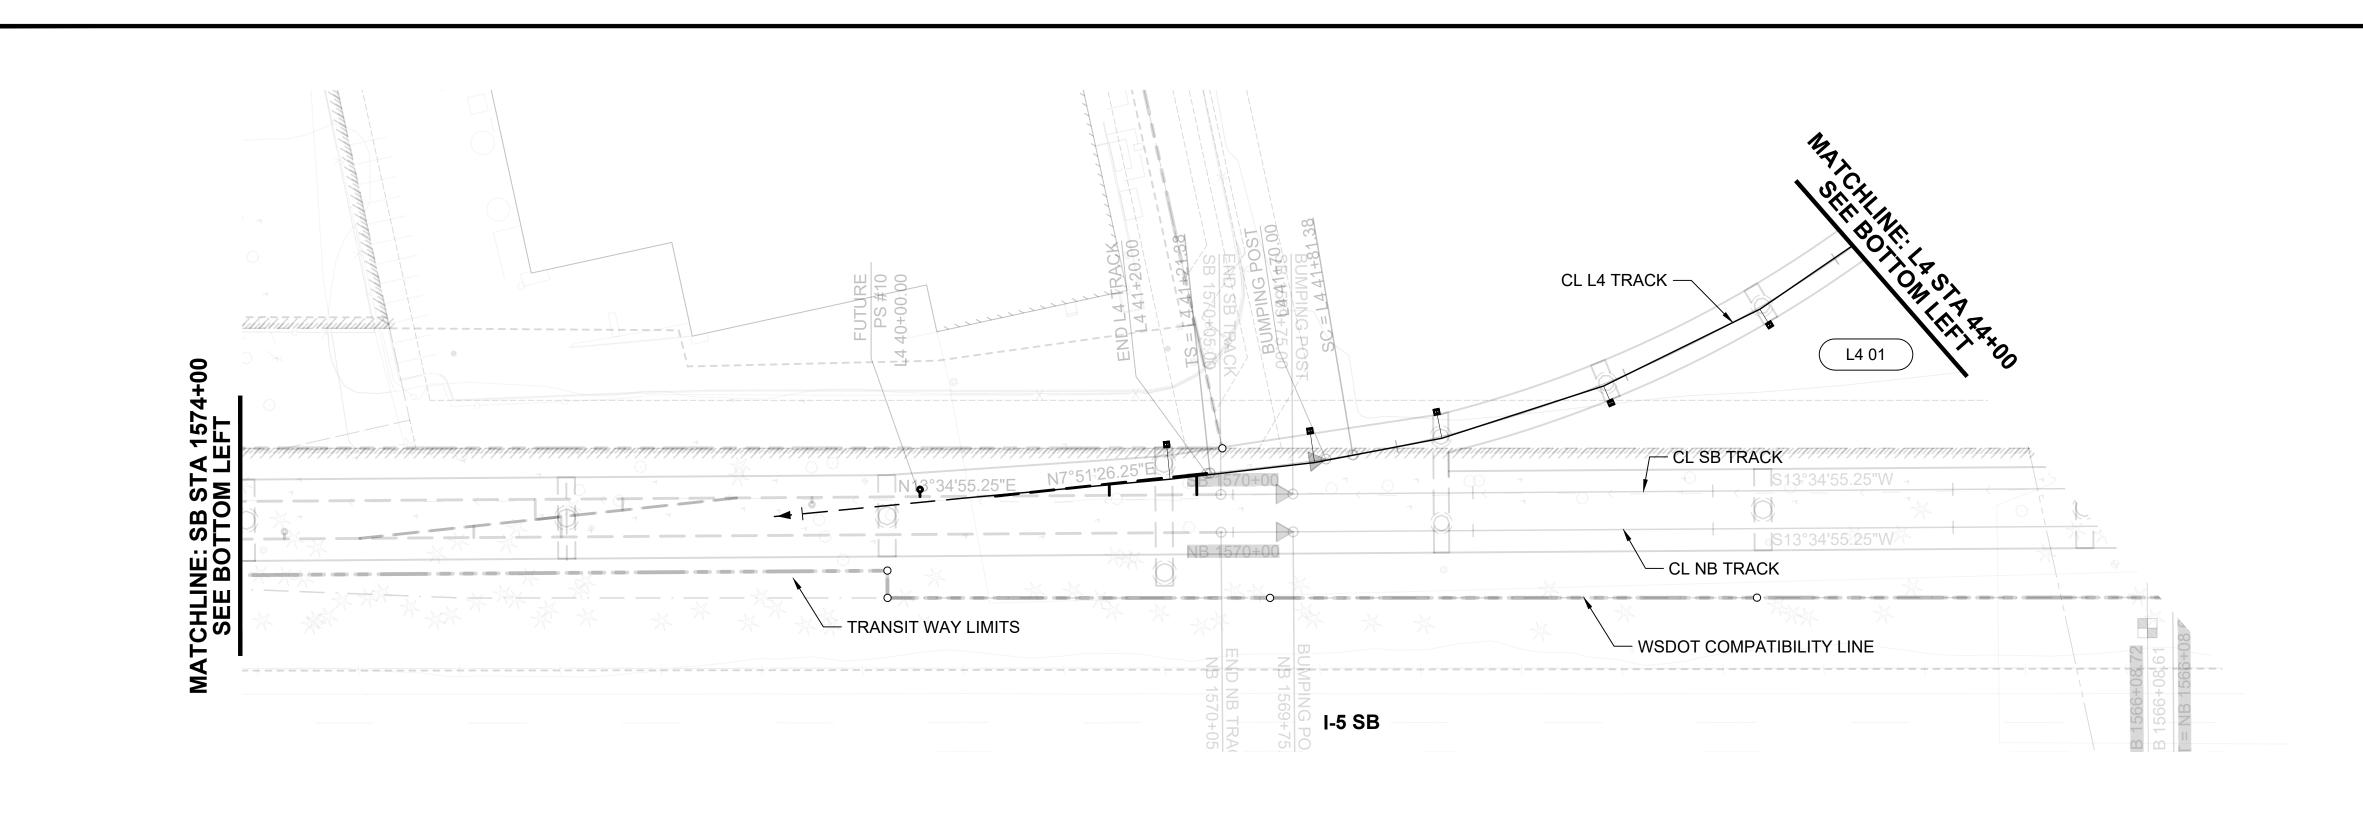

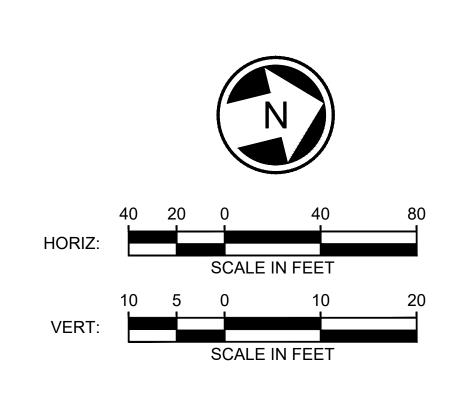

Refer to the plan set COVER drawing for disclaimers regarding this drawing.

DESIGNED BY: REFERENCE CONCEPT DRAWINGS M. RAMOS DRAWN BY: M. CLEMENT CHECKED BY: R. DEMERS APPROVED BY M. RAMOS

AHJ:

2/27/2024

REVIEWED BY:

5 SoundTransit

2/27/2024

1"=40' FILENAME: CONTRACT No.: AE-0030-17

2/27/2024

PACKAGE #


SOUND TRANSIT OMFS-M08-JOP300-303

PRELIMINARY ENGINEERING PLANS OPERATIONS & MAINTENANCE FACILITY SOUTH


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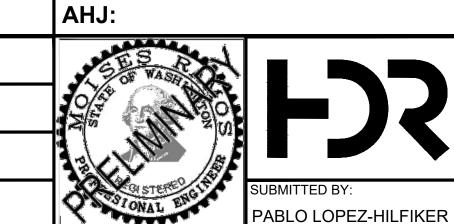
DRAWING No.: M08-JOP303

FACILITY ID: M08 SHEET No.:

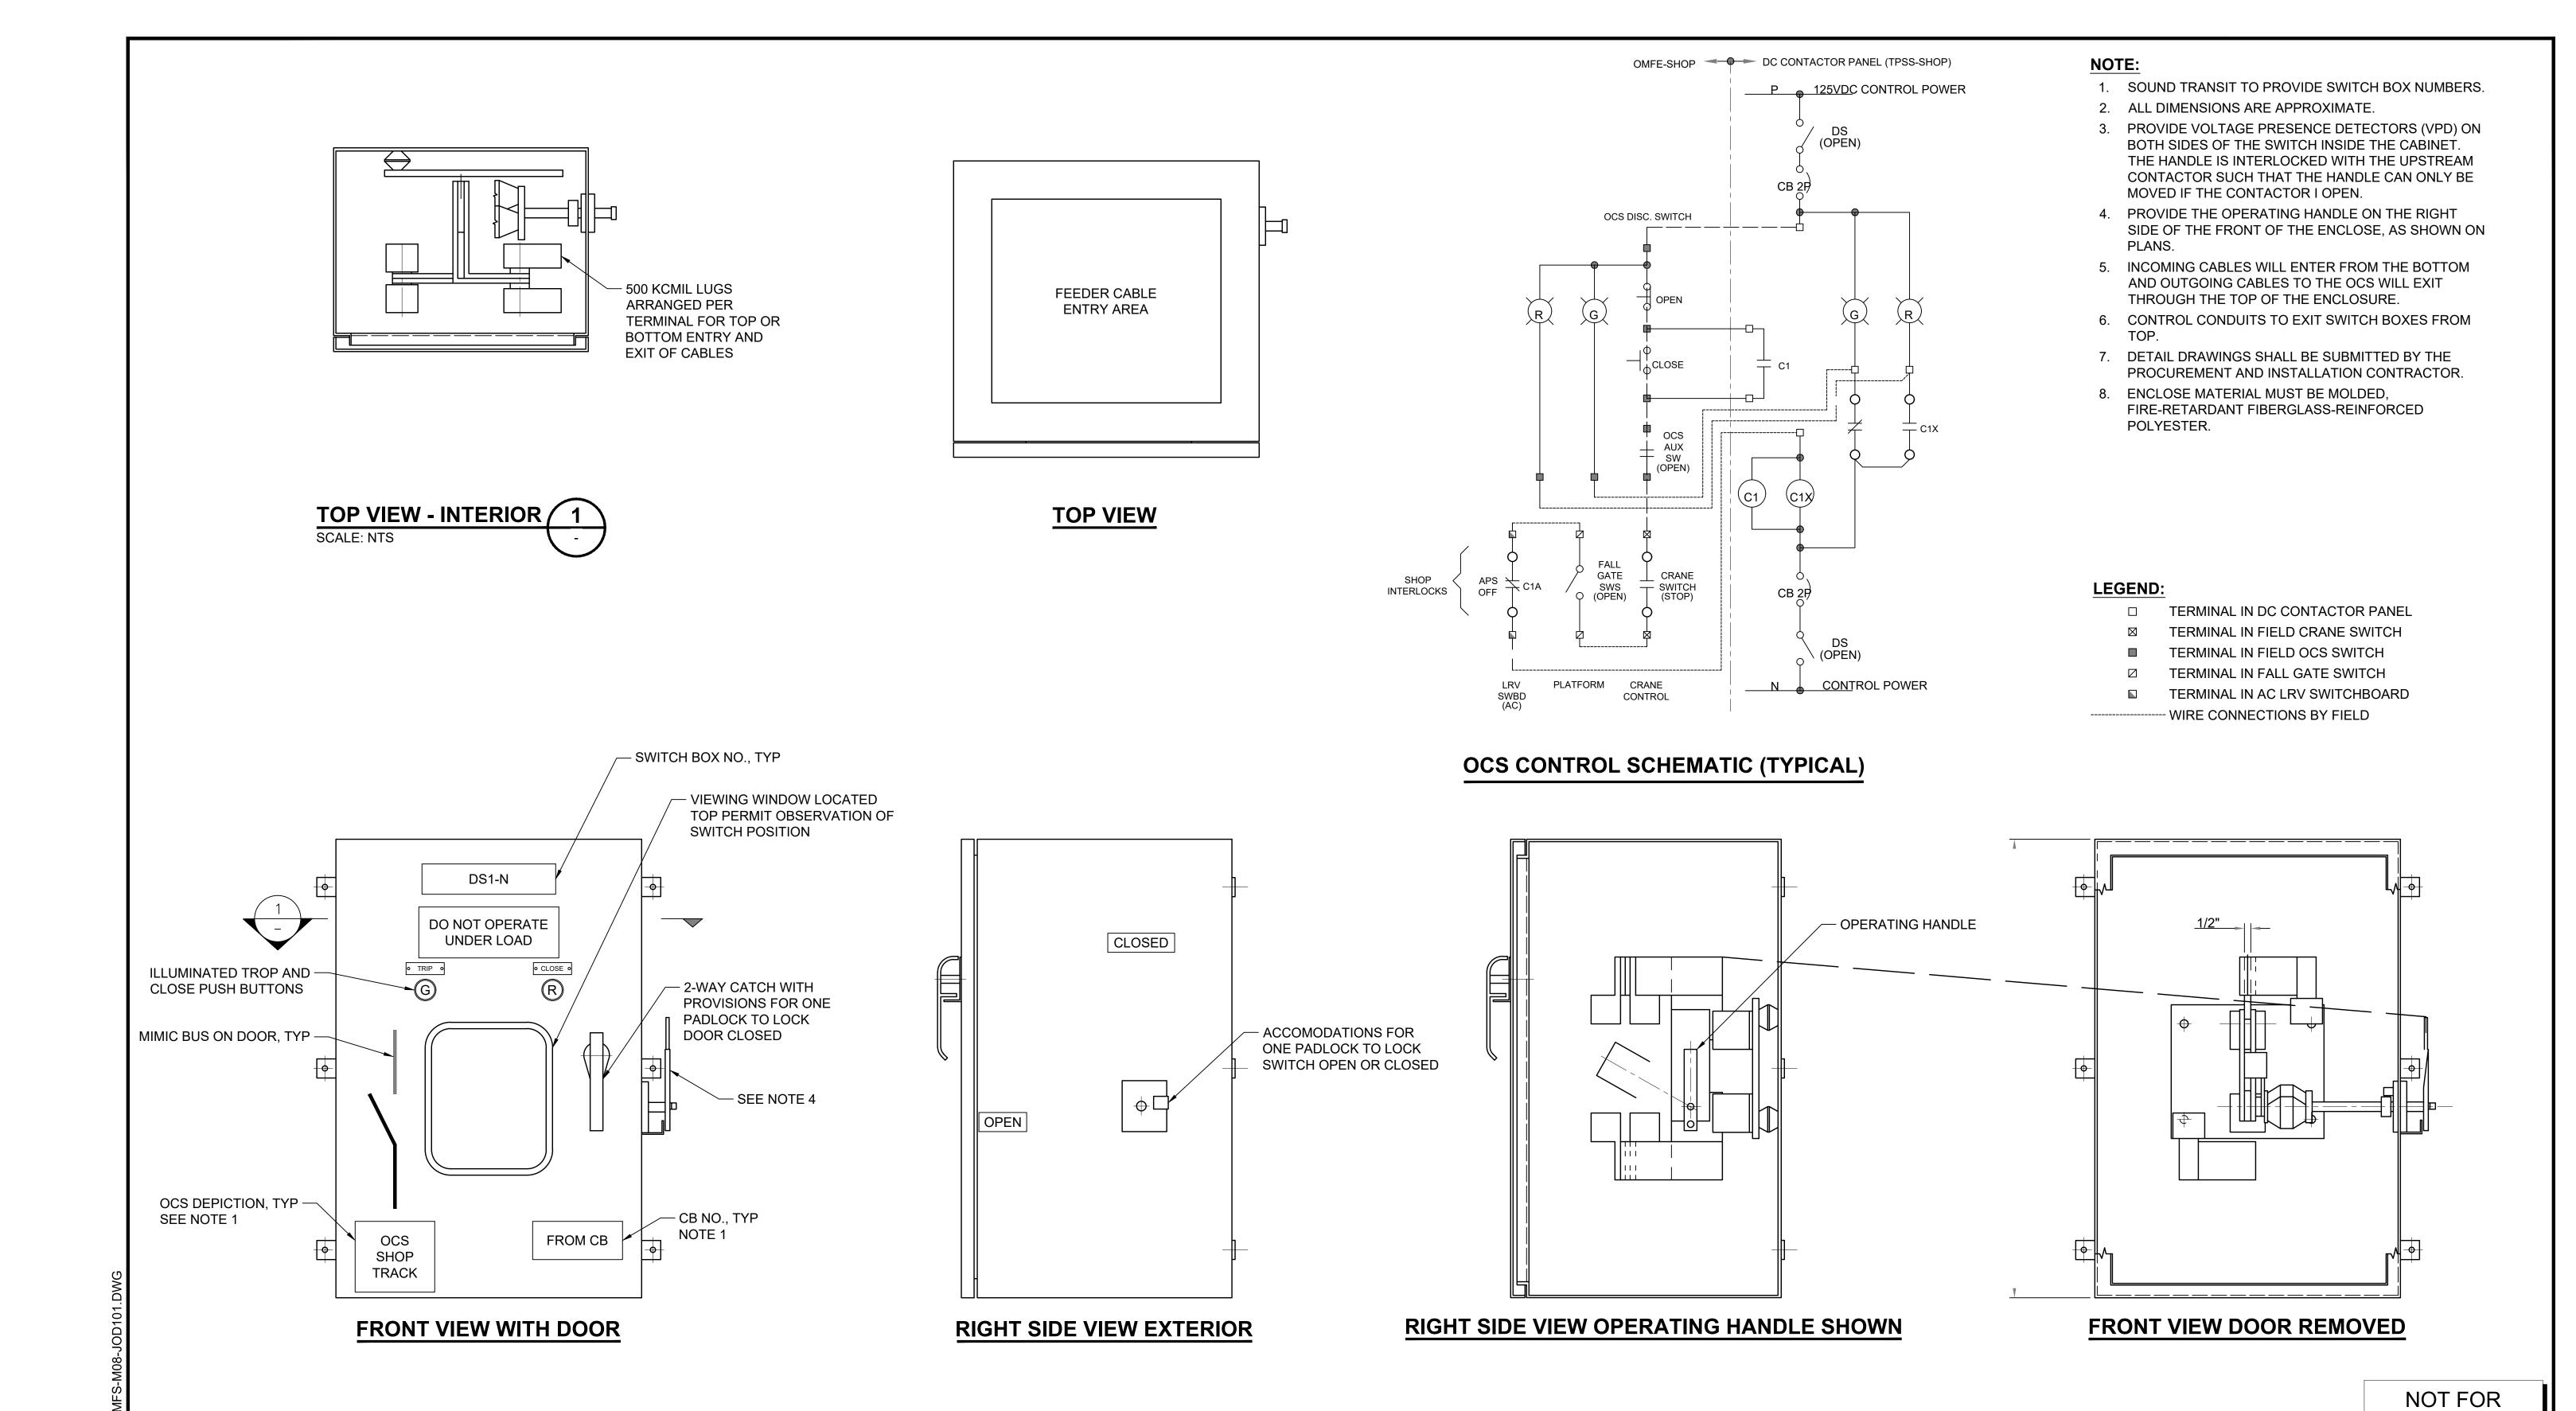

Refer to the plan set COVER drawing for disclaimers regarding this drawing.



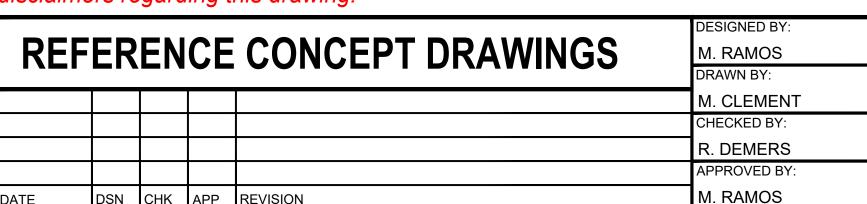

2/27/2024

REVIEWED BY:

5 SoundTransit PACKAGE # ILENAME: OMFS-M08-JOD101 CONTRACT No. AE-0030-17

2/27/2024

SOUND TRANSIT PRELIMINARY ENGINEERING PLANS **OPERATIONS & MAINTENANCE FACILITY SOUTH**

> OVERHEAD CONTACT SYSTEMS **ASSEMBLY**

M08-JOD101 FACILITY ID:


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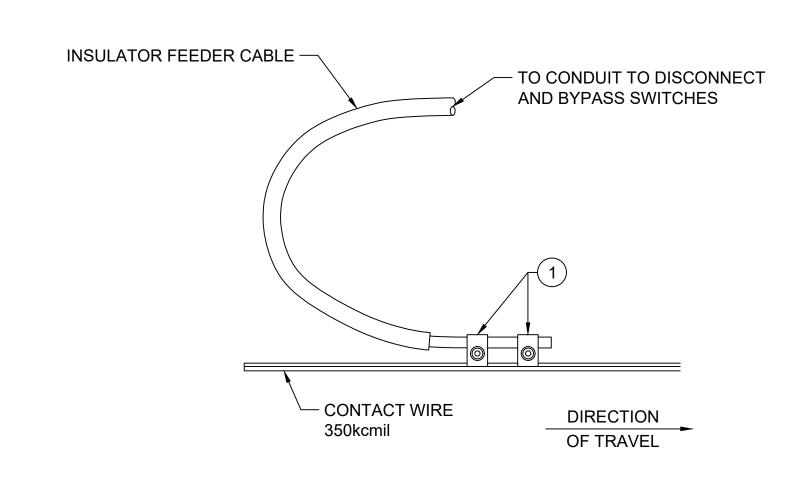
RAWING No.:

SHOP DISCONNECT SWITCH



1. VENDOR WILL PROVIDE SHOP DRAWING NUMBER.



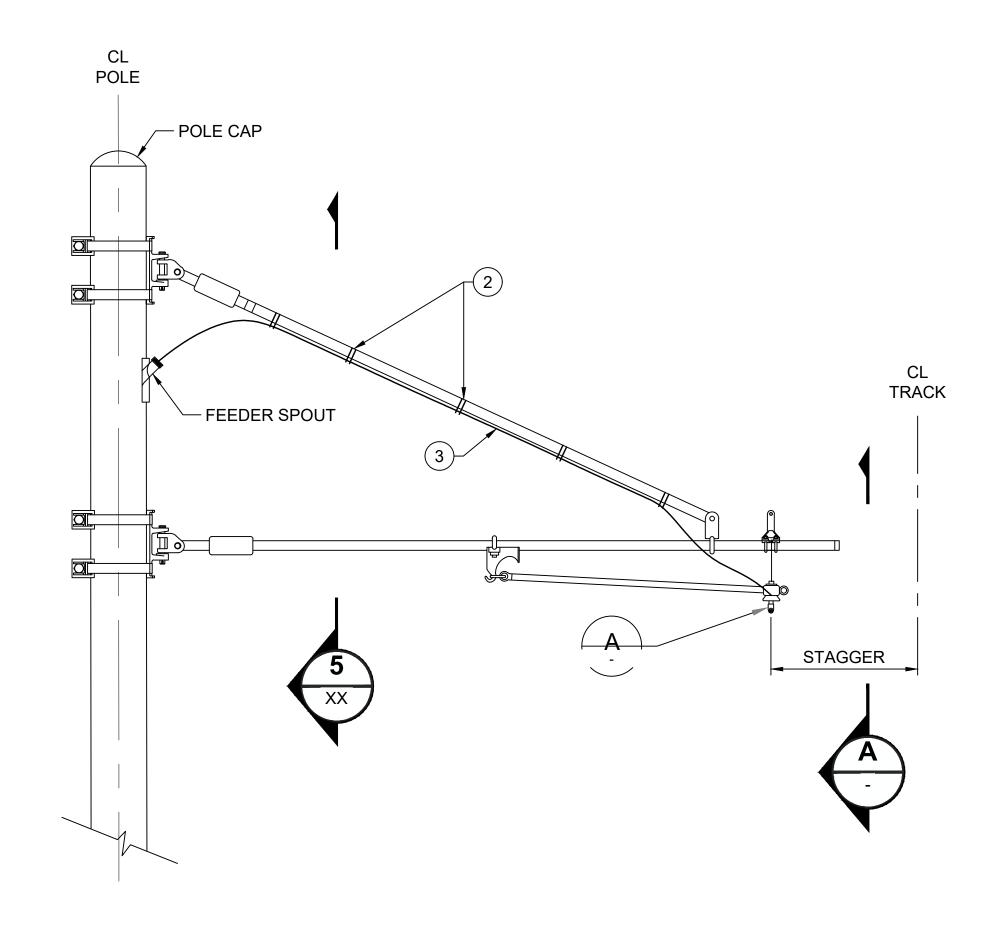

FEEDER CABLE ARRANGEMENT FOR SWFT SYSTEM FR-2 1



BILL OF MATERIAL						
ITEM	DESCRIPTION	QTY				
1	DUPLEX FEEDER CLAMP TO 350KCMIL CONTACT WIRE	2				
2	TIE WRAPS	AS REQ'D				
3	INSULATED FEEDER CABLE WITH TIE WRAPS	AS REQ'D				

NOT FOR CONSTRUCTION

Refer to the plan set COVER drawing for disclaimers regarding this drawing.

DESIGNED BY: REFERENCE CONCEPT DRAWINGS M. RAMOS DRAWN BY: M. CLEMENT CHECKED BY: R. DEMERS APPROVED BY: M. RAMOS DSN CHK APP REVISION

AHJ:	
ST S VASI	
S CH STERE	SUBMITTED BY:
WAL P	PABLO LOPEZ-HILFIKER

SUBMITTED BY:

2/27/2024

5 SoundTransit

REVIEWED BY:

PACKAGE # FILENAME: OMFS-M08-JOD102 CONTRACT No.: AE-0030-17


2/27/2024


SOUND TRANSIT PRELIMINARY ENGINEERING PLANS OPERATIONS & MAINTENANCE FACILITY SOUTH

OVERHEAD CONTACT SYSTEMS CANTILEVER - YARD - LONG REACH CL-03L, M, H

DRAWING No.: M08-JOD405 FACILITY ID: M08

SHEET No.:

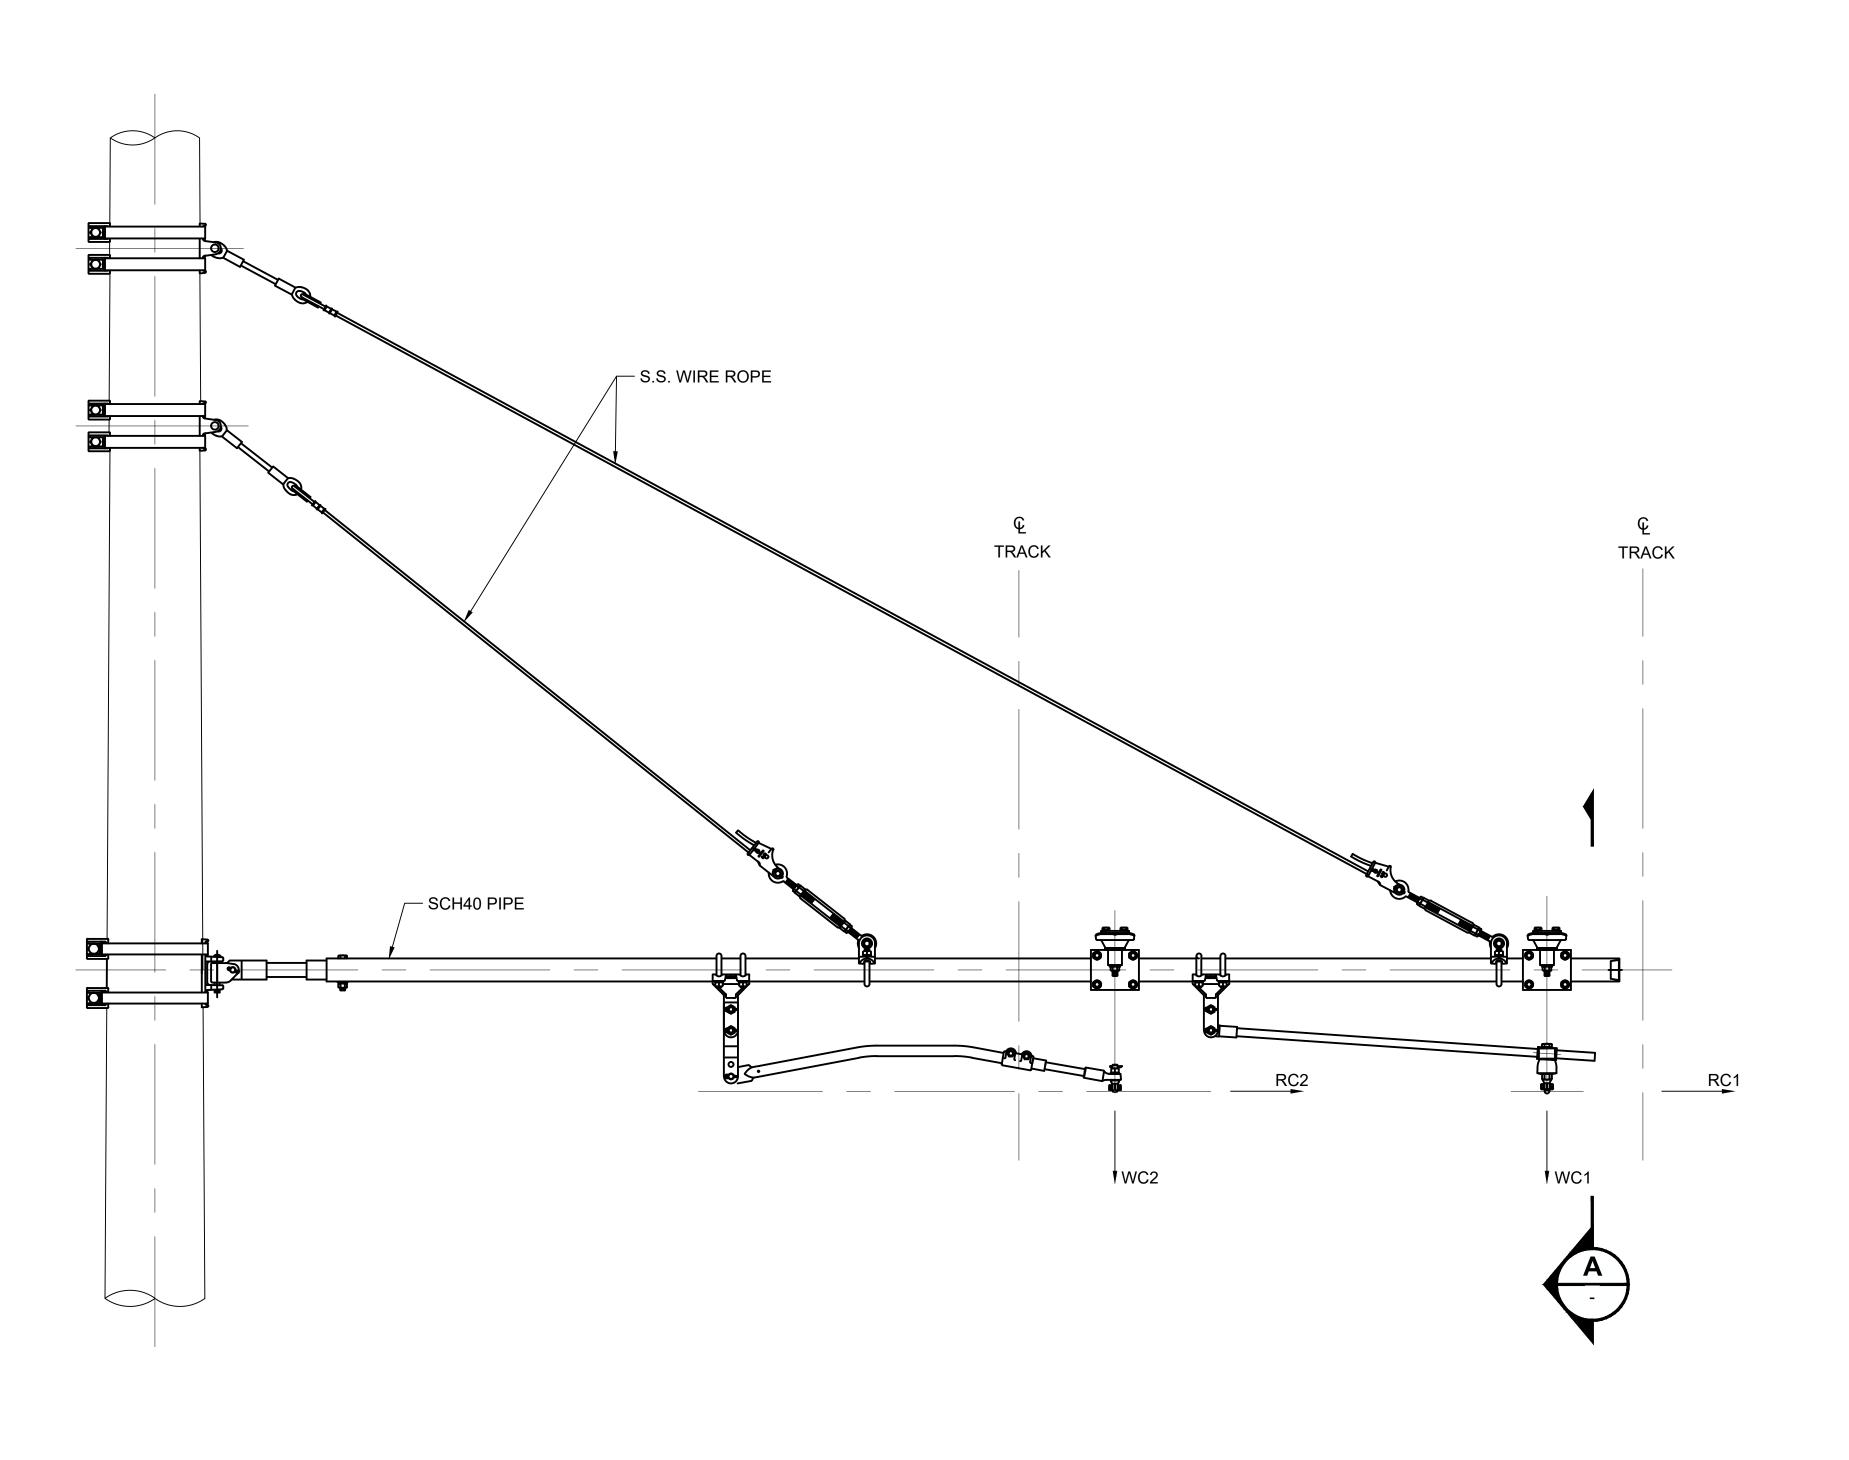

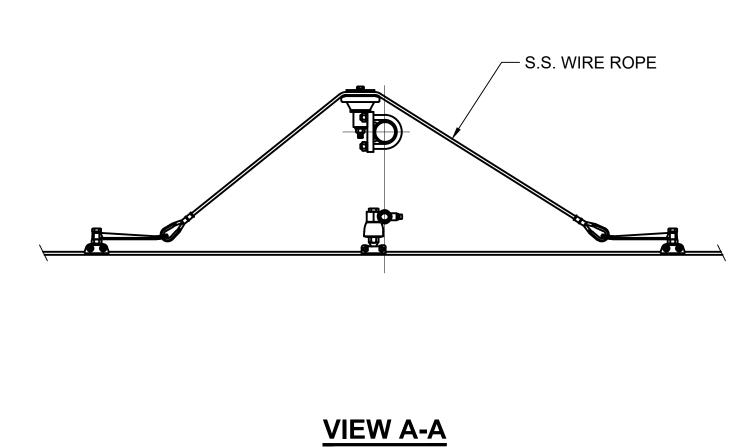

Refer to the plan set COVER drawing for disclaimers regarding this drawing.

DESIGNED BY: REFERENCE CONCEPT DRAWINGS M. RAMOS DRAWN BY: M. CLEMENT CHECKED BY: R. DEMERS APPROVED BY: M. RAMOS

AHJ: PABLO LOPEZ-HILFIKER

2/27/2024

REVIEWED BY:

5 SoundTransit


PACKAGE # FILENAME: OMFS-M08-JOD103 CONTRACT No.: AE-0030-17

2/27/2024

SOUND TRANSIT PRELIMINARY ENGINEERING PLANS OPERATIONS & MAINTENANCE FACILITY SOUTH


OVERHEAD CONTACT SYSTEMS CANTILEVER - TWO TRACK TTC-1 & TTC-2

DRAWING No.: M08-JOD410 FACILITY ID:

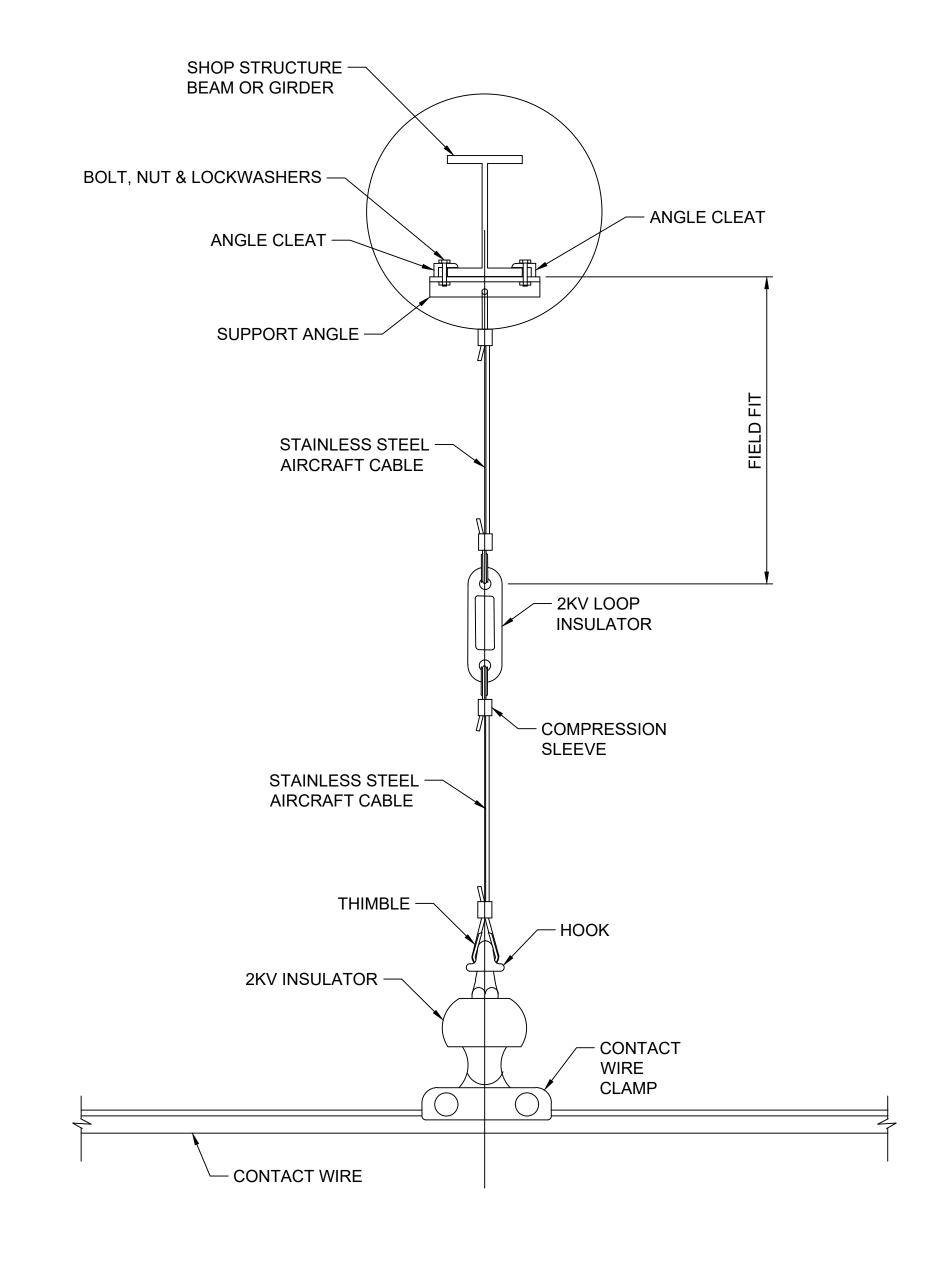


SHOP HANGER SH-01
SCALE: NTS

M. RAMOS

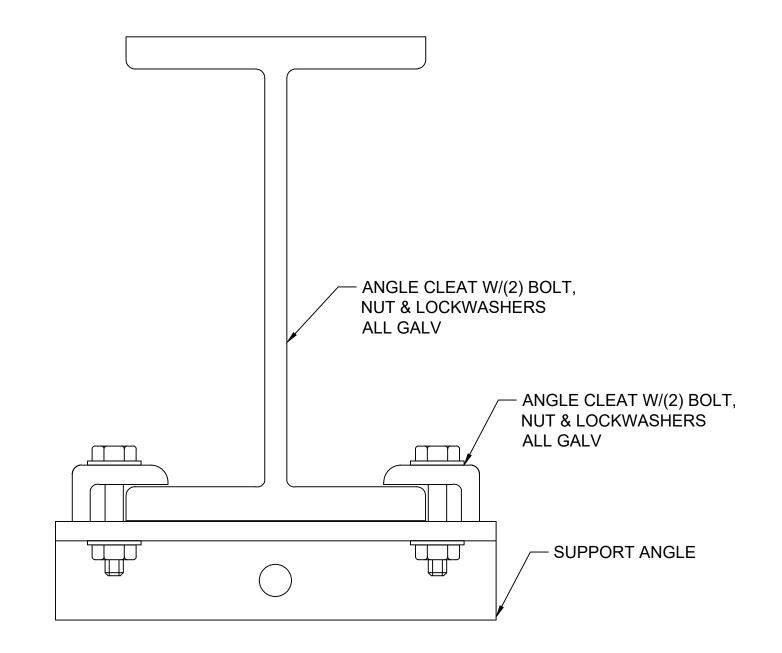

SUPPORT ANGLE DETAIL
SCALE: NTS

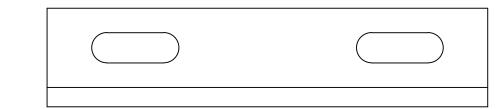

PLAN SCALE: NTS

2/27/2024


NOT FOR CONSTRUCTION


Refer to the plan set COVER drawing PACKAGE # for disclaimers regarding this drawing. AHJ: DESIGNED BY: DRAWING No.: **SOUND TRANSIT** REFERENCE CONCEPT DRAWINGS 5 M. RAMOS DRAWN BY: M08-JOD430 PRELIMINARY ENGINEERING PLANS FILENAME: OPERATIONS & MAINTENANCE FACILITY SOUTH M. CLEMENT OMFS-M08-JOD106 FACILITY ID: CHECKED BY: CONTRACT No.: SoundTransit M08 OVERHEAD CONTACT SYSTEMS AE-0030-17 R. DEMERS SHEET No.: SHOP HANGERS APPROVED BY REVIEWED BY:

2/27/2024

PABLO LOPEZ-HILFIKER

WWORKING\WEST01\D2772713\OMFS-M08-JOD106.DWG

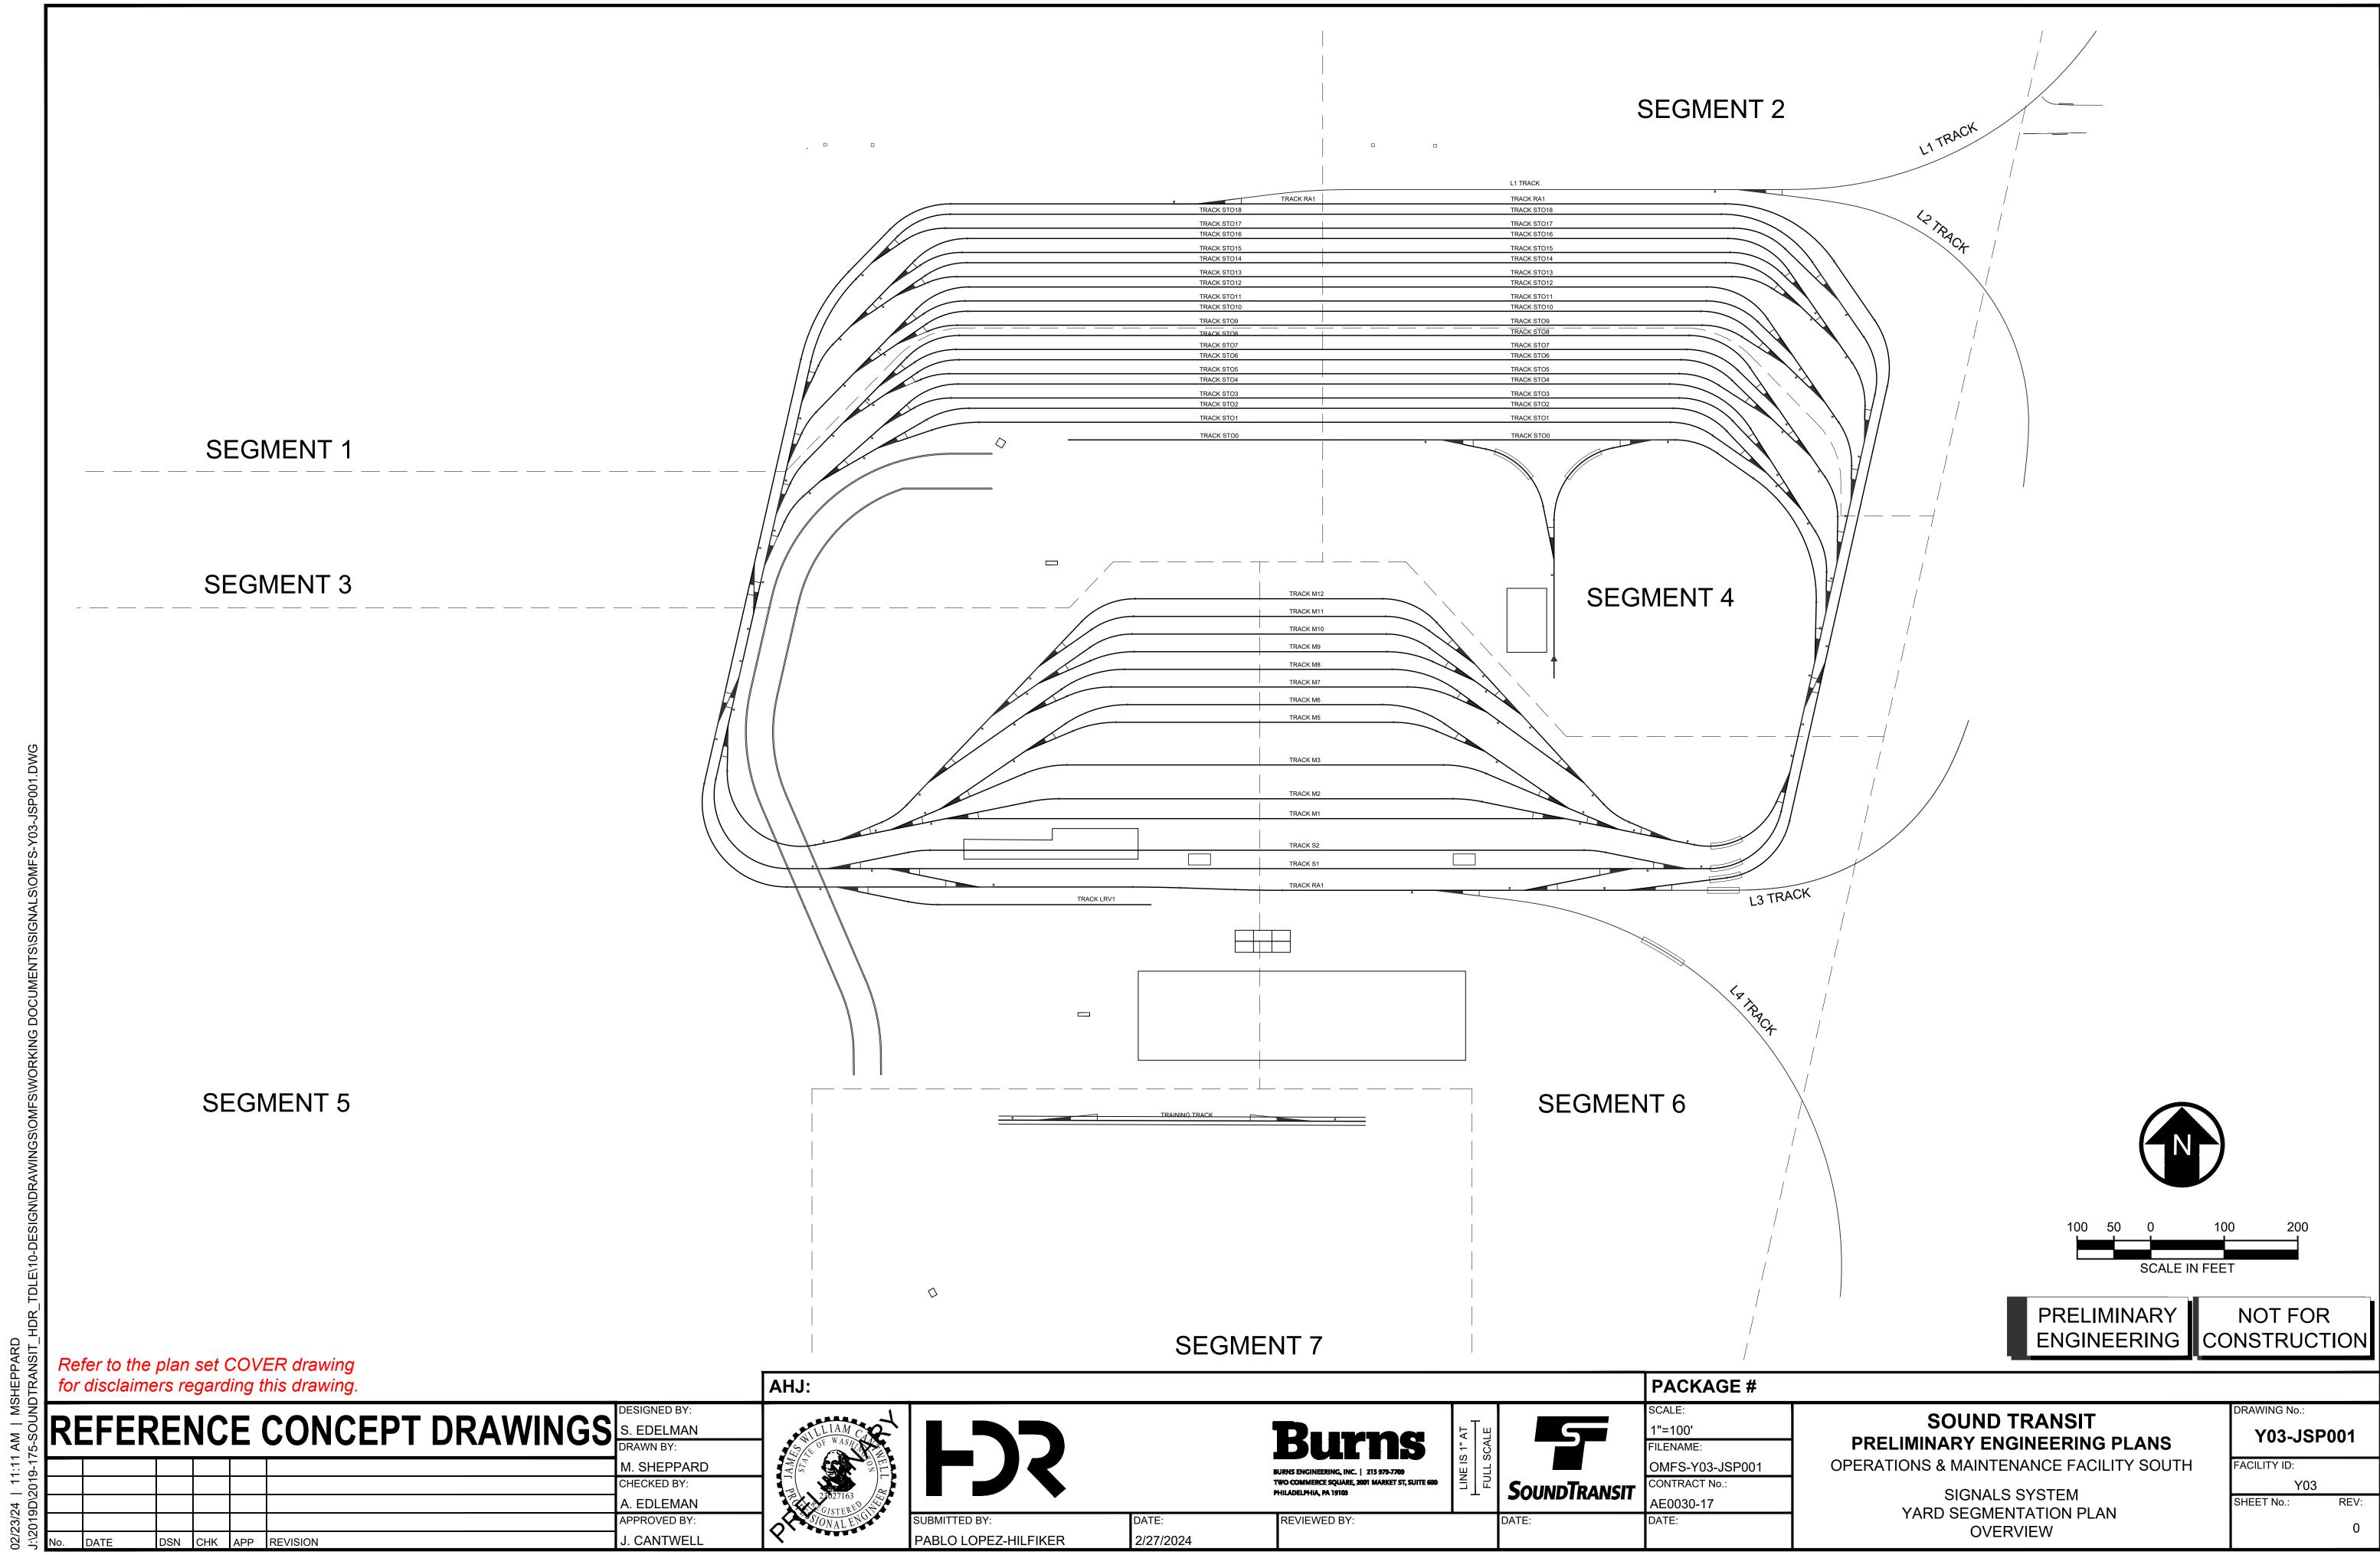

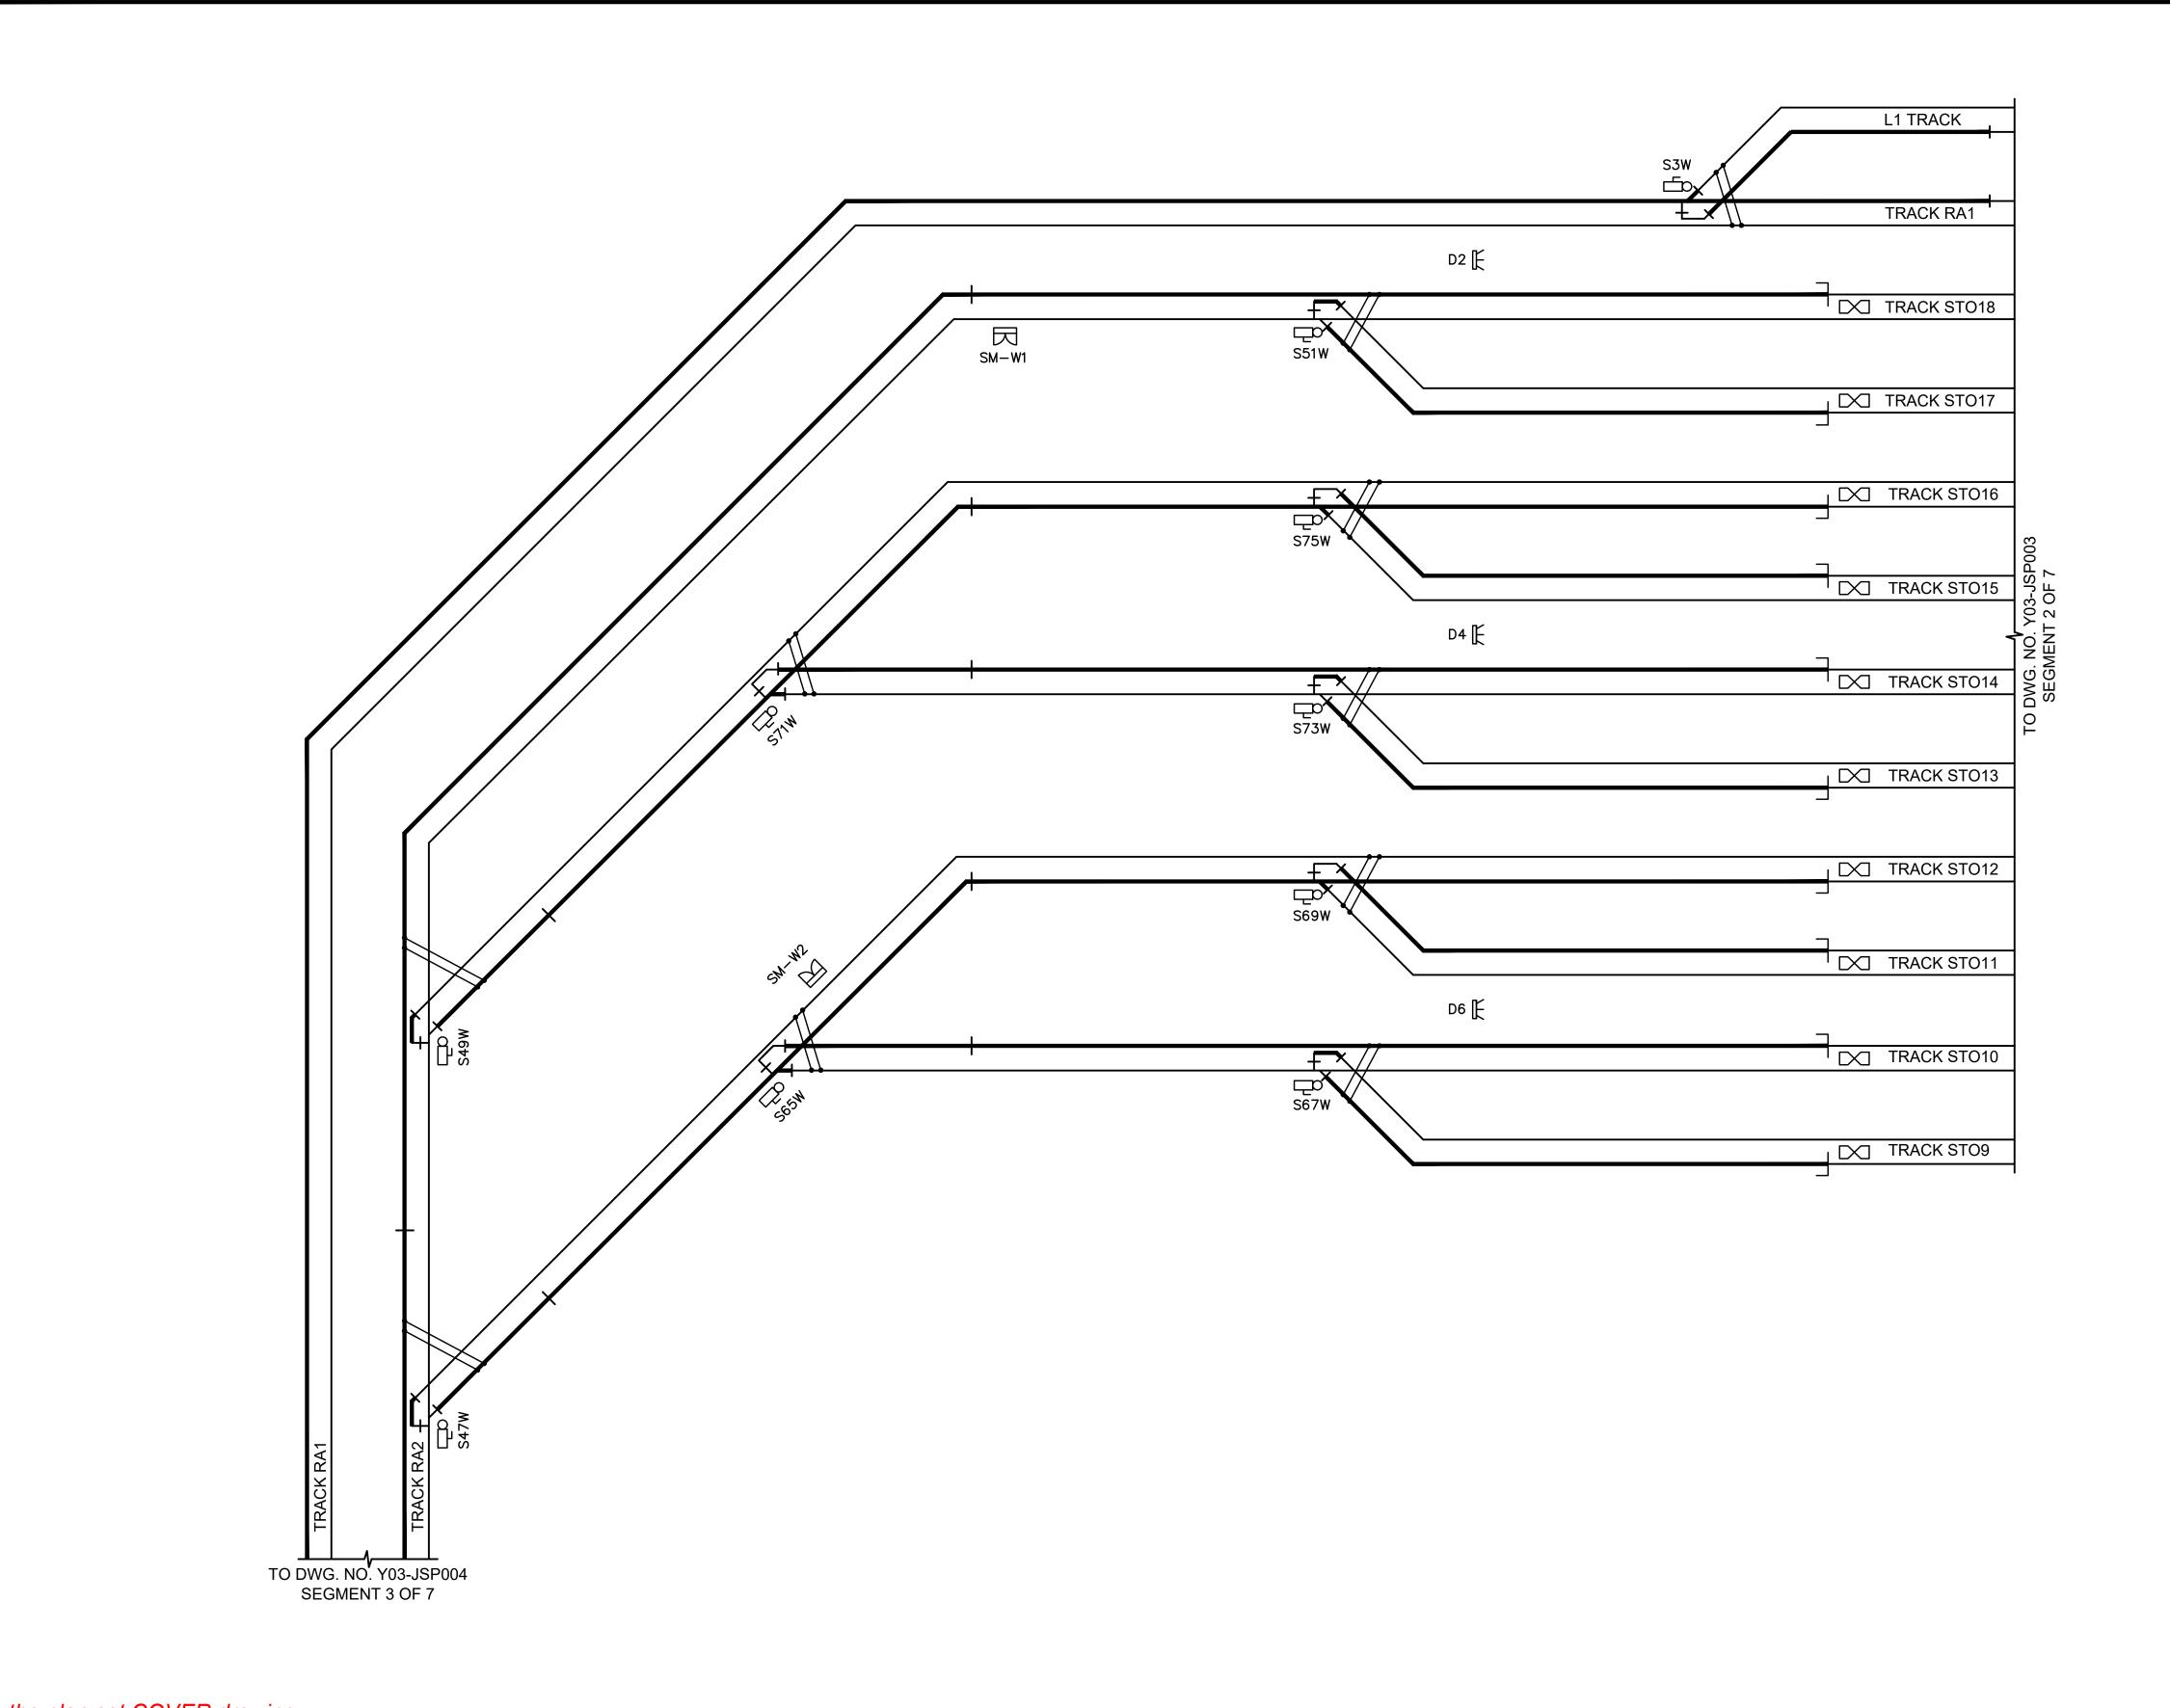



PRELIMINARY

NOT FOR ENGINEERING CONSTRUCTION

Refer to the plan set COVER drawing for disclaimers regarding this drawing.

REFERENCE CONCEPT DRAWINGS S. EDELMAN DRAWN BY: M. SHEPPARD CHECKED BY: A. EDLEMAN APPROVED BY: J. CANTWELL CHK APP REVISION

AHJ:

PABLO LOPEZ-HILFIKER

Burns TWO COMMERCE SQUARE, 2001 MARKET ST, SUITE 600 PHILADELPHIA, PA 19103 REVIEWED BY:

2/27/2024

5 SoundTransit

FILENAME: OMFS-Y03-JSP002 CONTRACT No.: AE0030-17


PACKAGE #

SOUND TRANSIT PRELIMINARY ENGINEERING PLANS OPERATIONS & MAINTENANCE FACILITY SOUTH

FACILITY ID: SIGNALS SYSTEM YARD DOUBLE LINE TRACK PLAN SEGMENT 1 OF 7

RAWING No.: Y03-JSP002

Y03 SHEET No.:

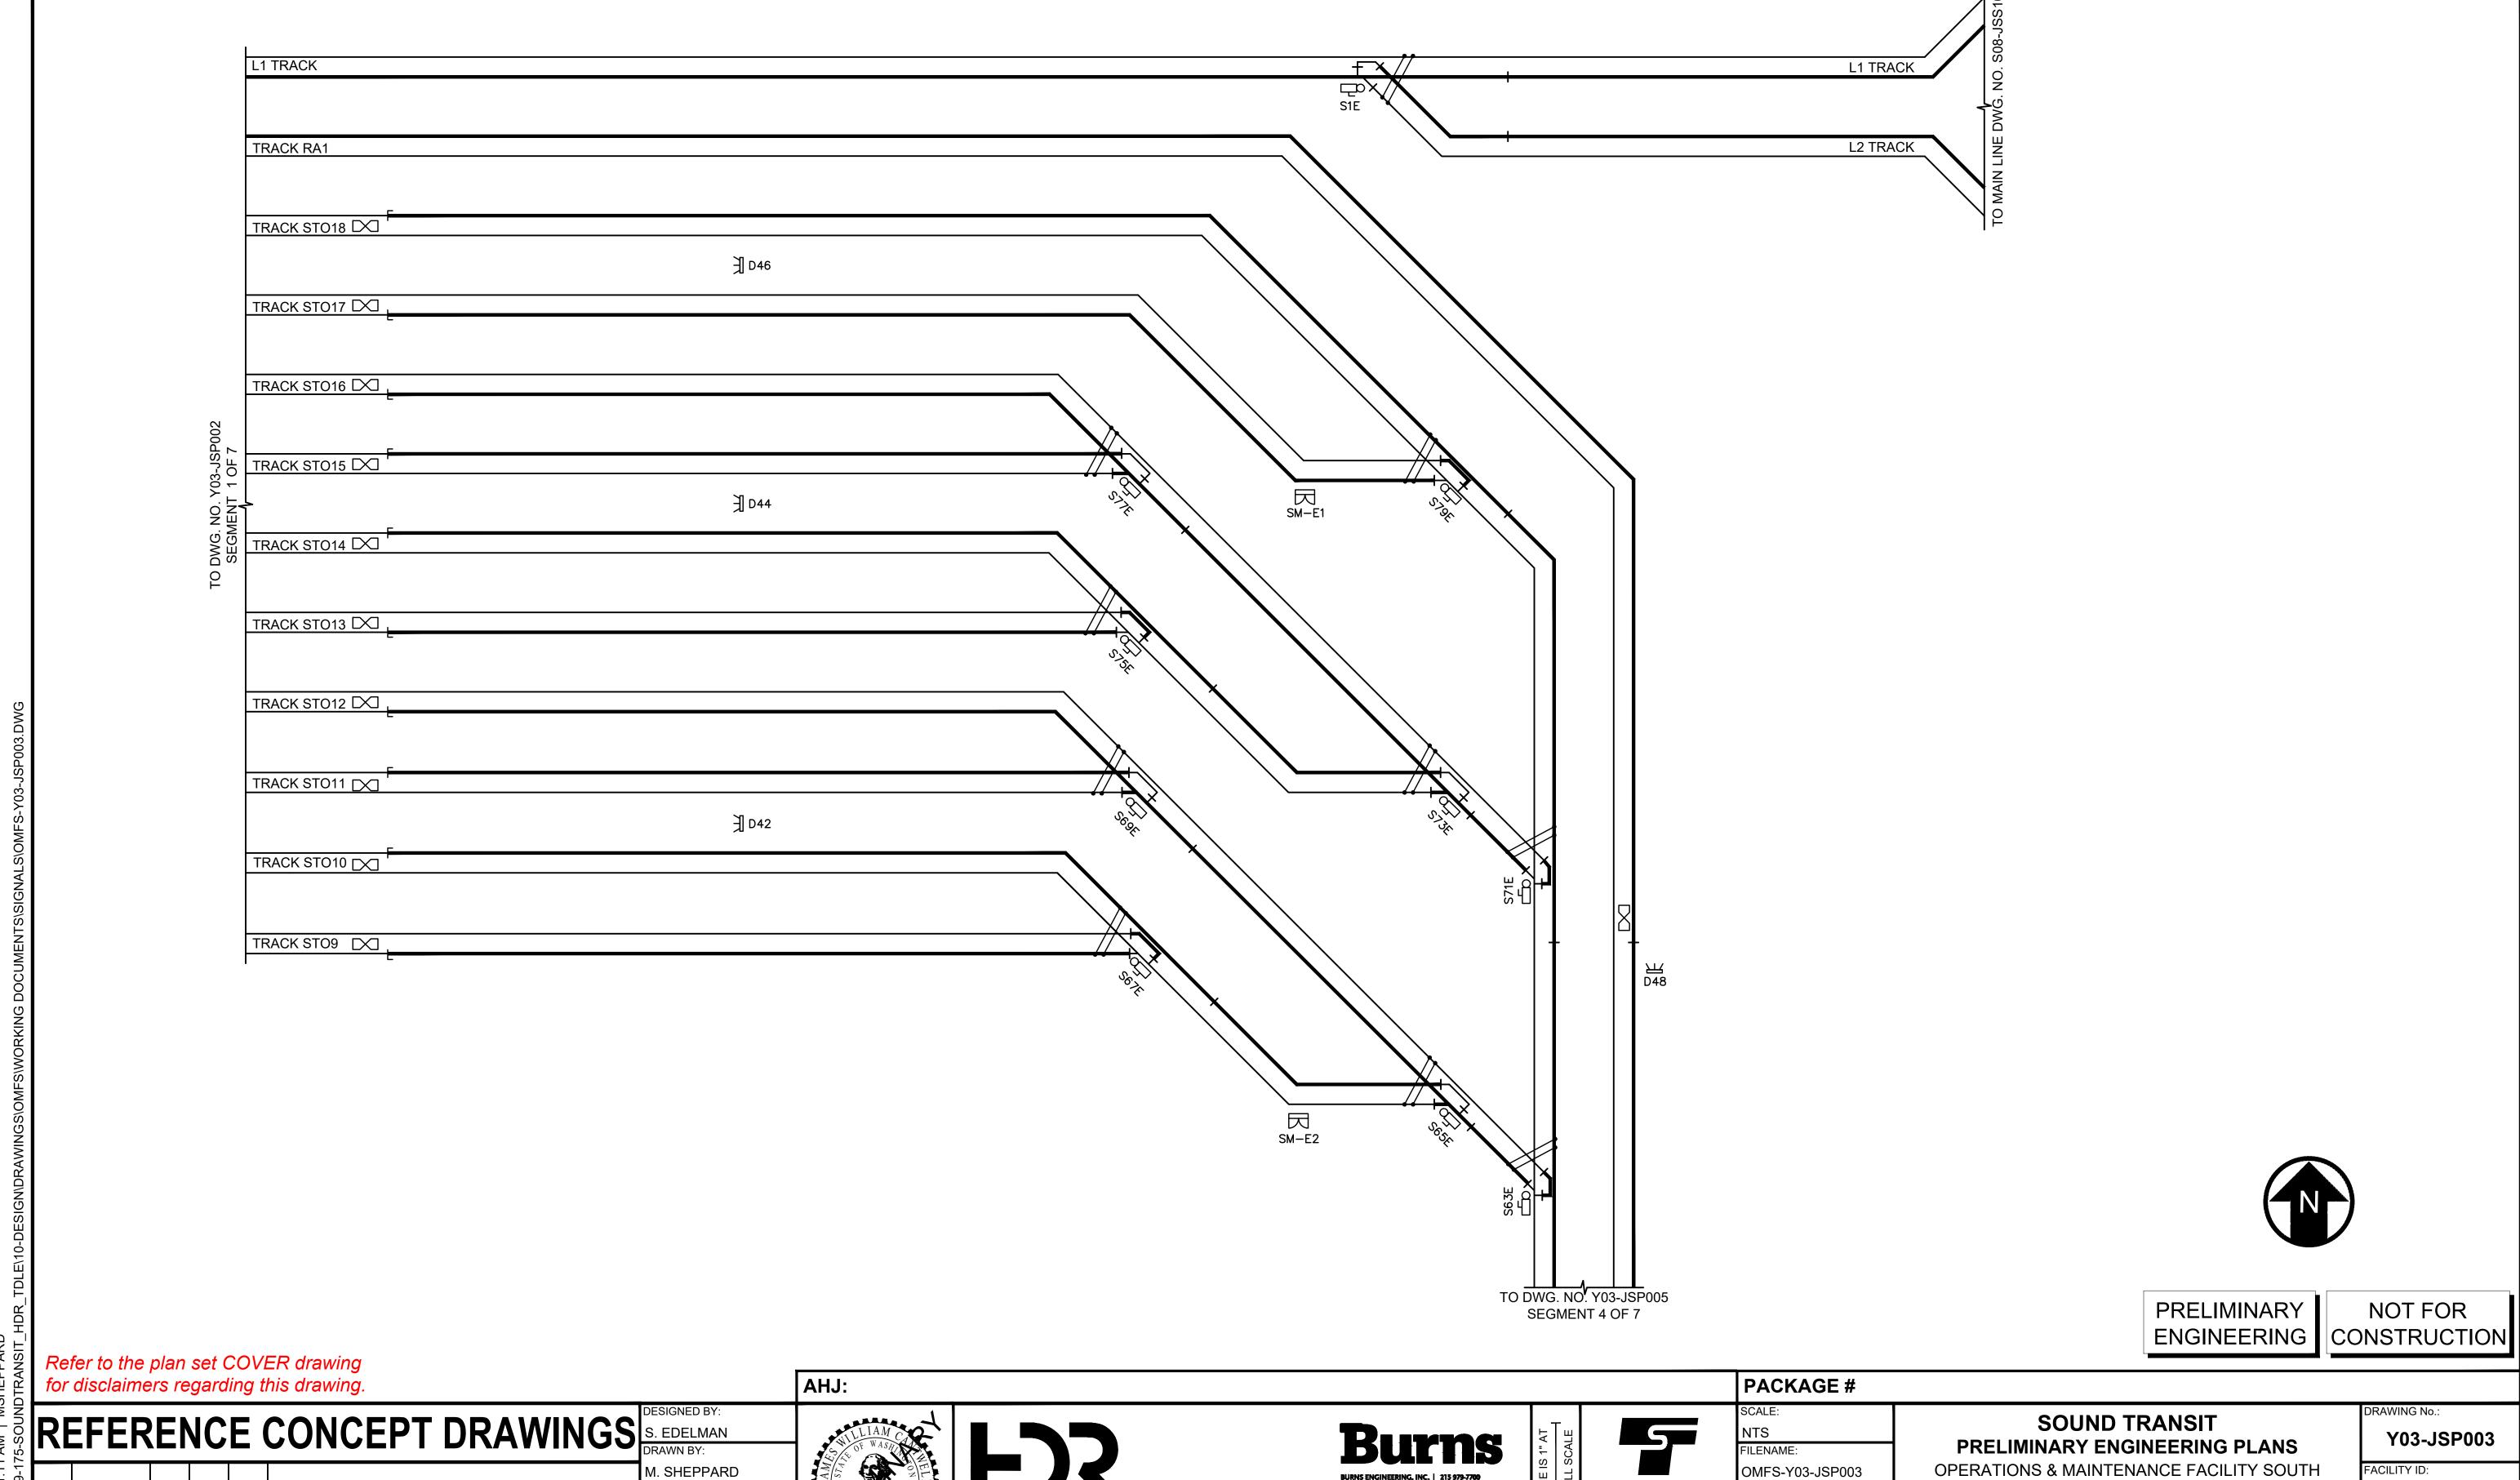

2/27/2024

PABLO LOPEZ-HILFIKER

CONTRACT No.:

AE0030-17

Y03

SHEET No.:

SIGNALS SYSTEM

YARD DOUBLE LINE TRACK PLAN

SEGMENT 2 OF 7

SoundTransit

PHILADELPHIA, PA 19103

REVIEWED BY:


02/23/24 | 11:11 AM | MSHEPPARD J:\2019D\2019-175-SOUNDTRANSIT HDR TDLE\10-

CHECKED BY:

A. EDLEMAN

APPROVED BY:

J. CANTWELL

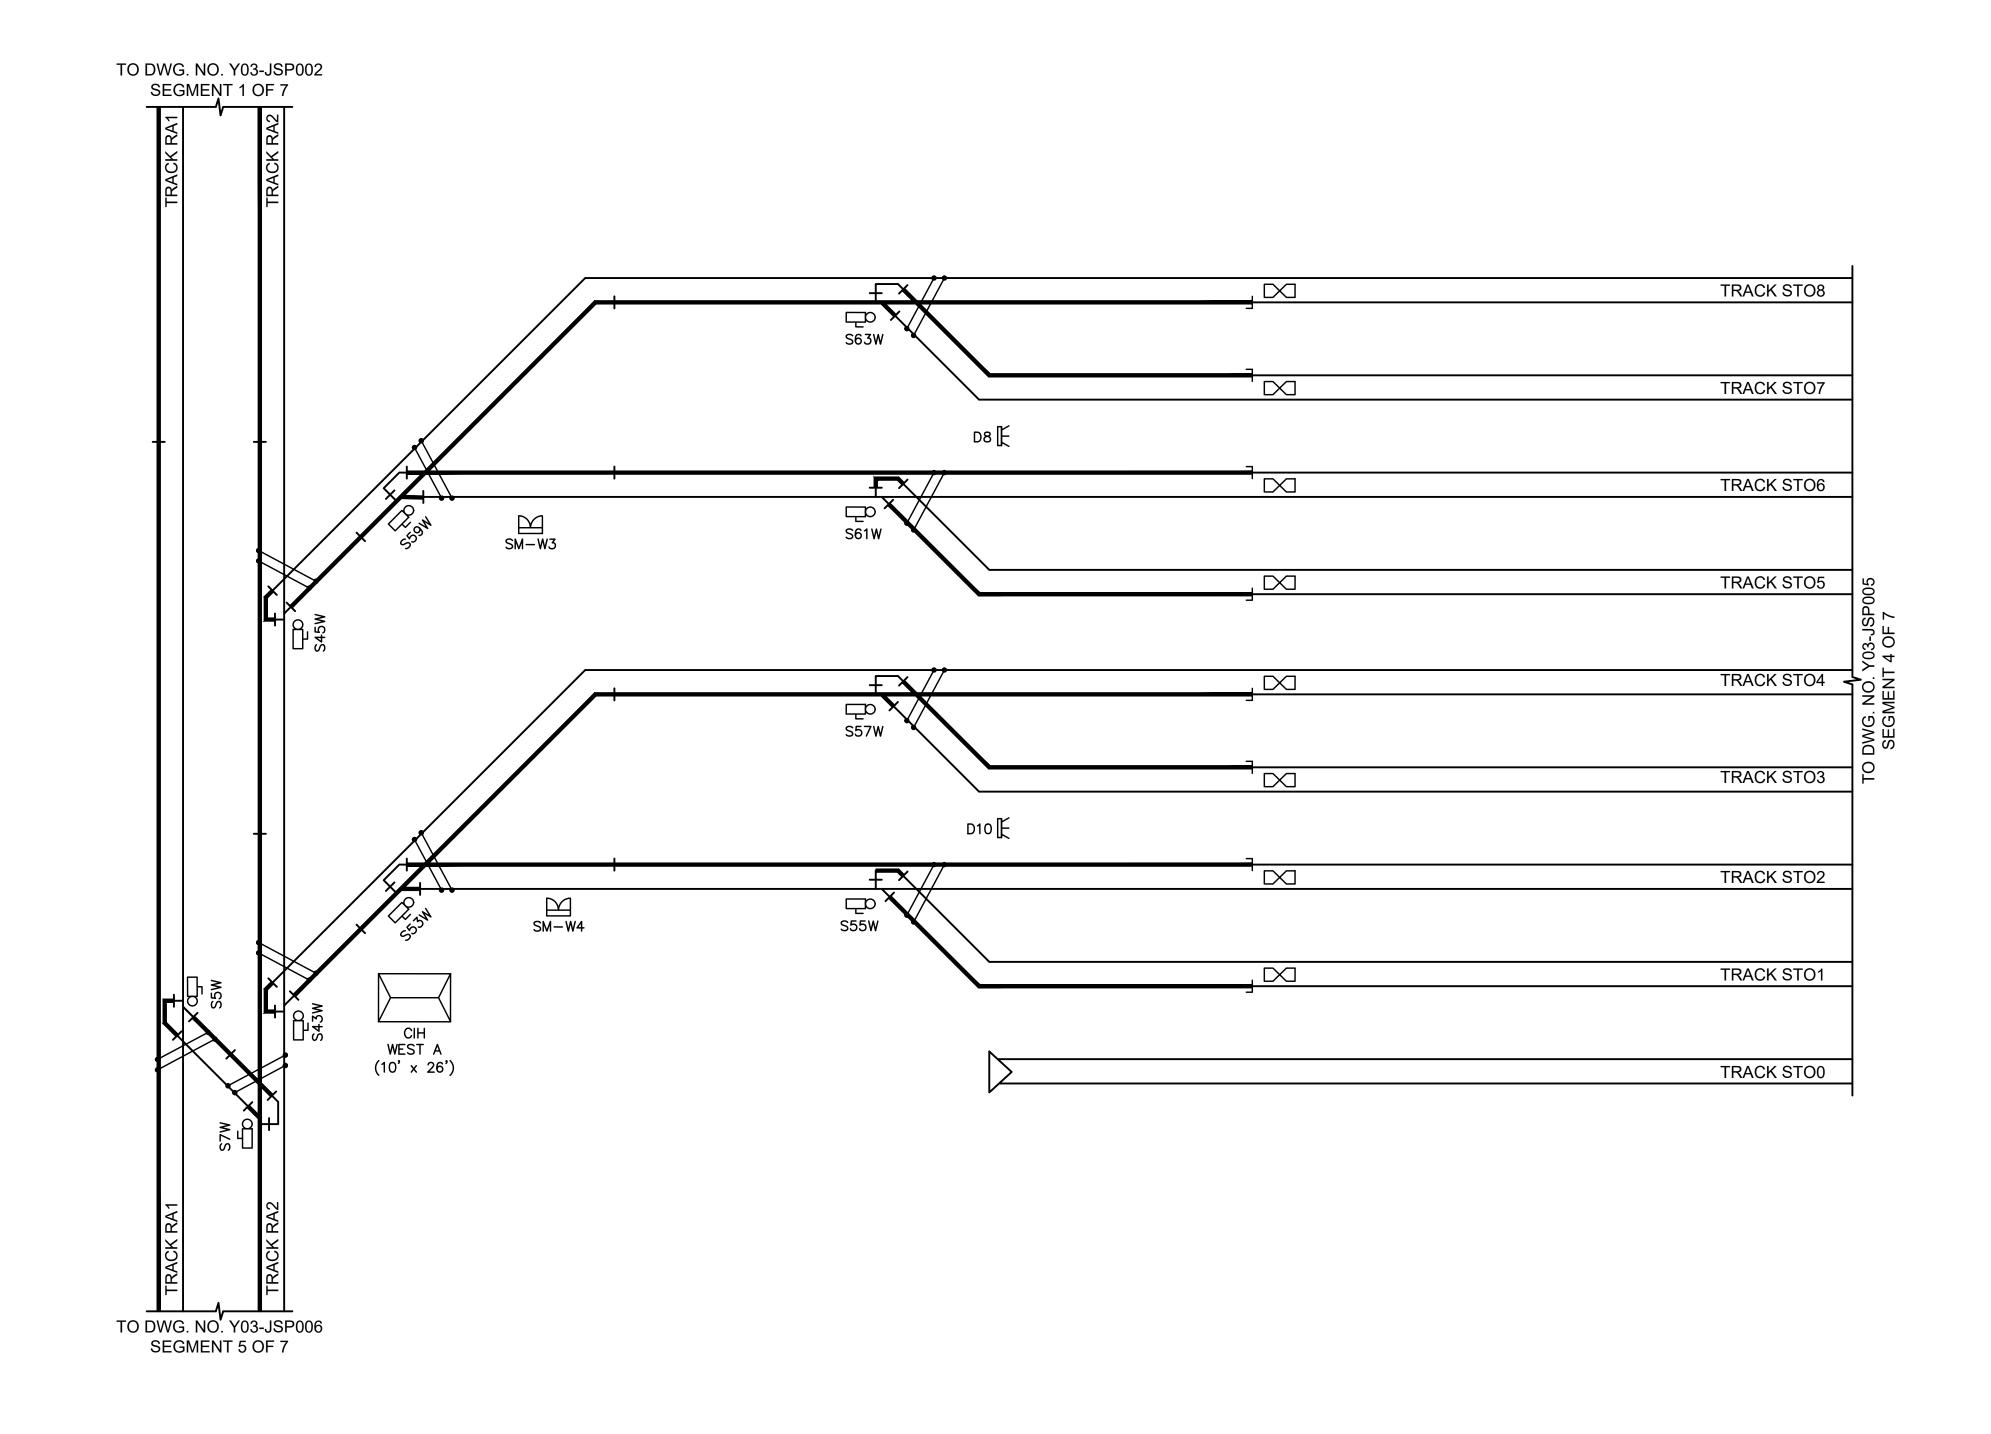



PRELIMINARY

NOT FOR ENGINEERING CONSTRUCTION

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for disclaimers regarding this drawing.							
RI	EFER	E	NC	E	CONCEPT DRAWINGS	DESIGNED BY: S. EDELMAN DRAWN BY:	SWILL SWOF
						M. SHEPPARD	JAM STAZ
						CHECKED BY: A. EDLEMAN	
						APPROVED BY:	\$510
No.	DATE	DSN	CHK	APP	REVISION	J. CANTWELL	X Y

PABLO LOPEZ-HILFIKER

Burns BURNS ENGINEERING, INC. | 215 979-7700 TWO COMMERCE SQUARE, 2001 MARKET ST, SUITE 600 PHILADELPHIA, PA 19103 REVIEWED BY:

2/27/2024

5 SoundTransit

FILENAME: OMFS-Y03-JSP004 CONTRACT No.: AE0030-17


PACKAGE #

SOUND TRANSIT PRELIMINARY ENGINEERING PLANS OPERATIONS & MAINTENANCE FACILITY SOUTH

SIGNALS SYSTEM YARD DOUBLE LINE TRACK PLAN SEGMENT 3 OF 7

RAWING No.: Y03-JSP004 FACILITY ID:

Y03 SHEET No.:

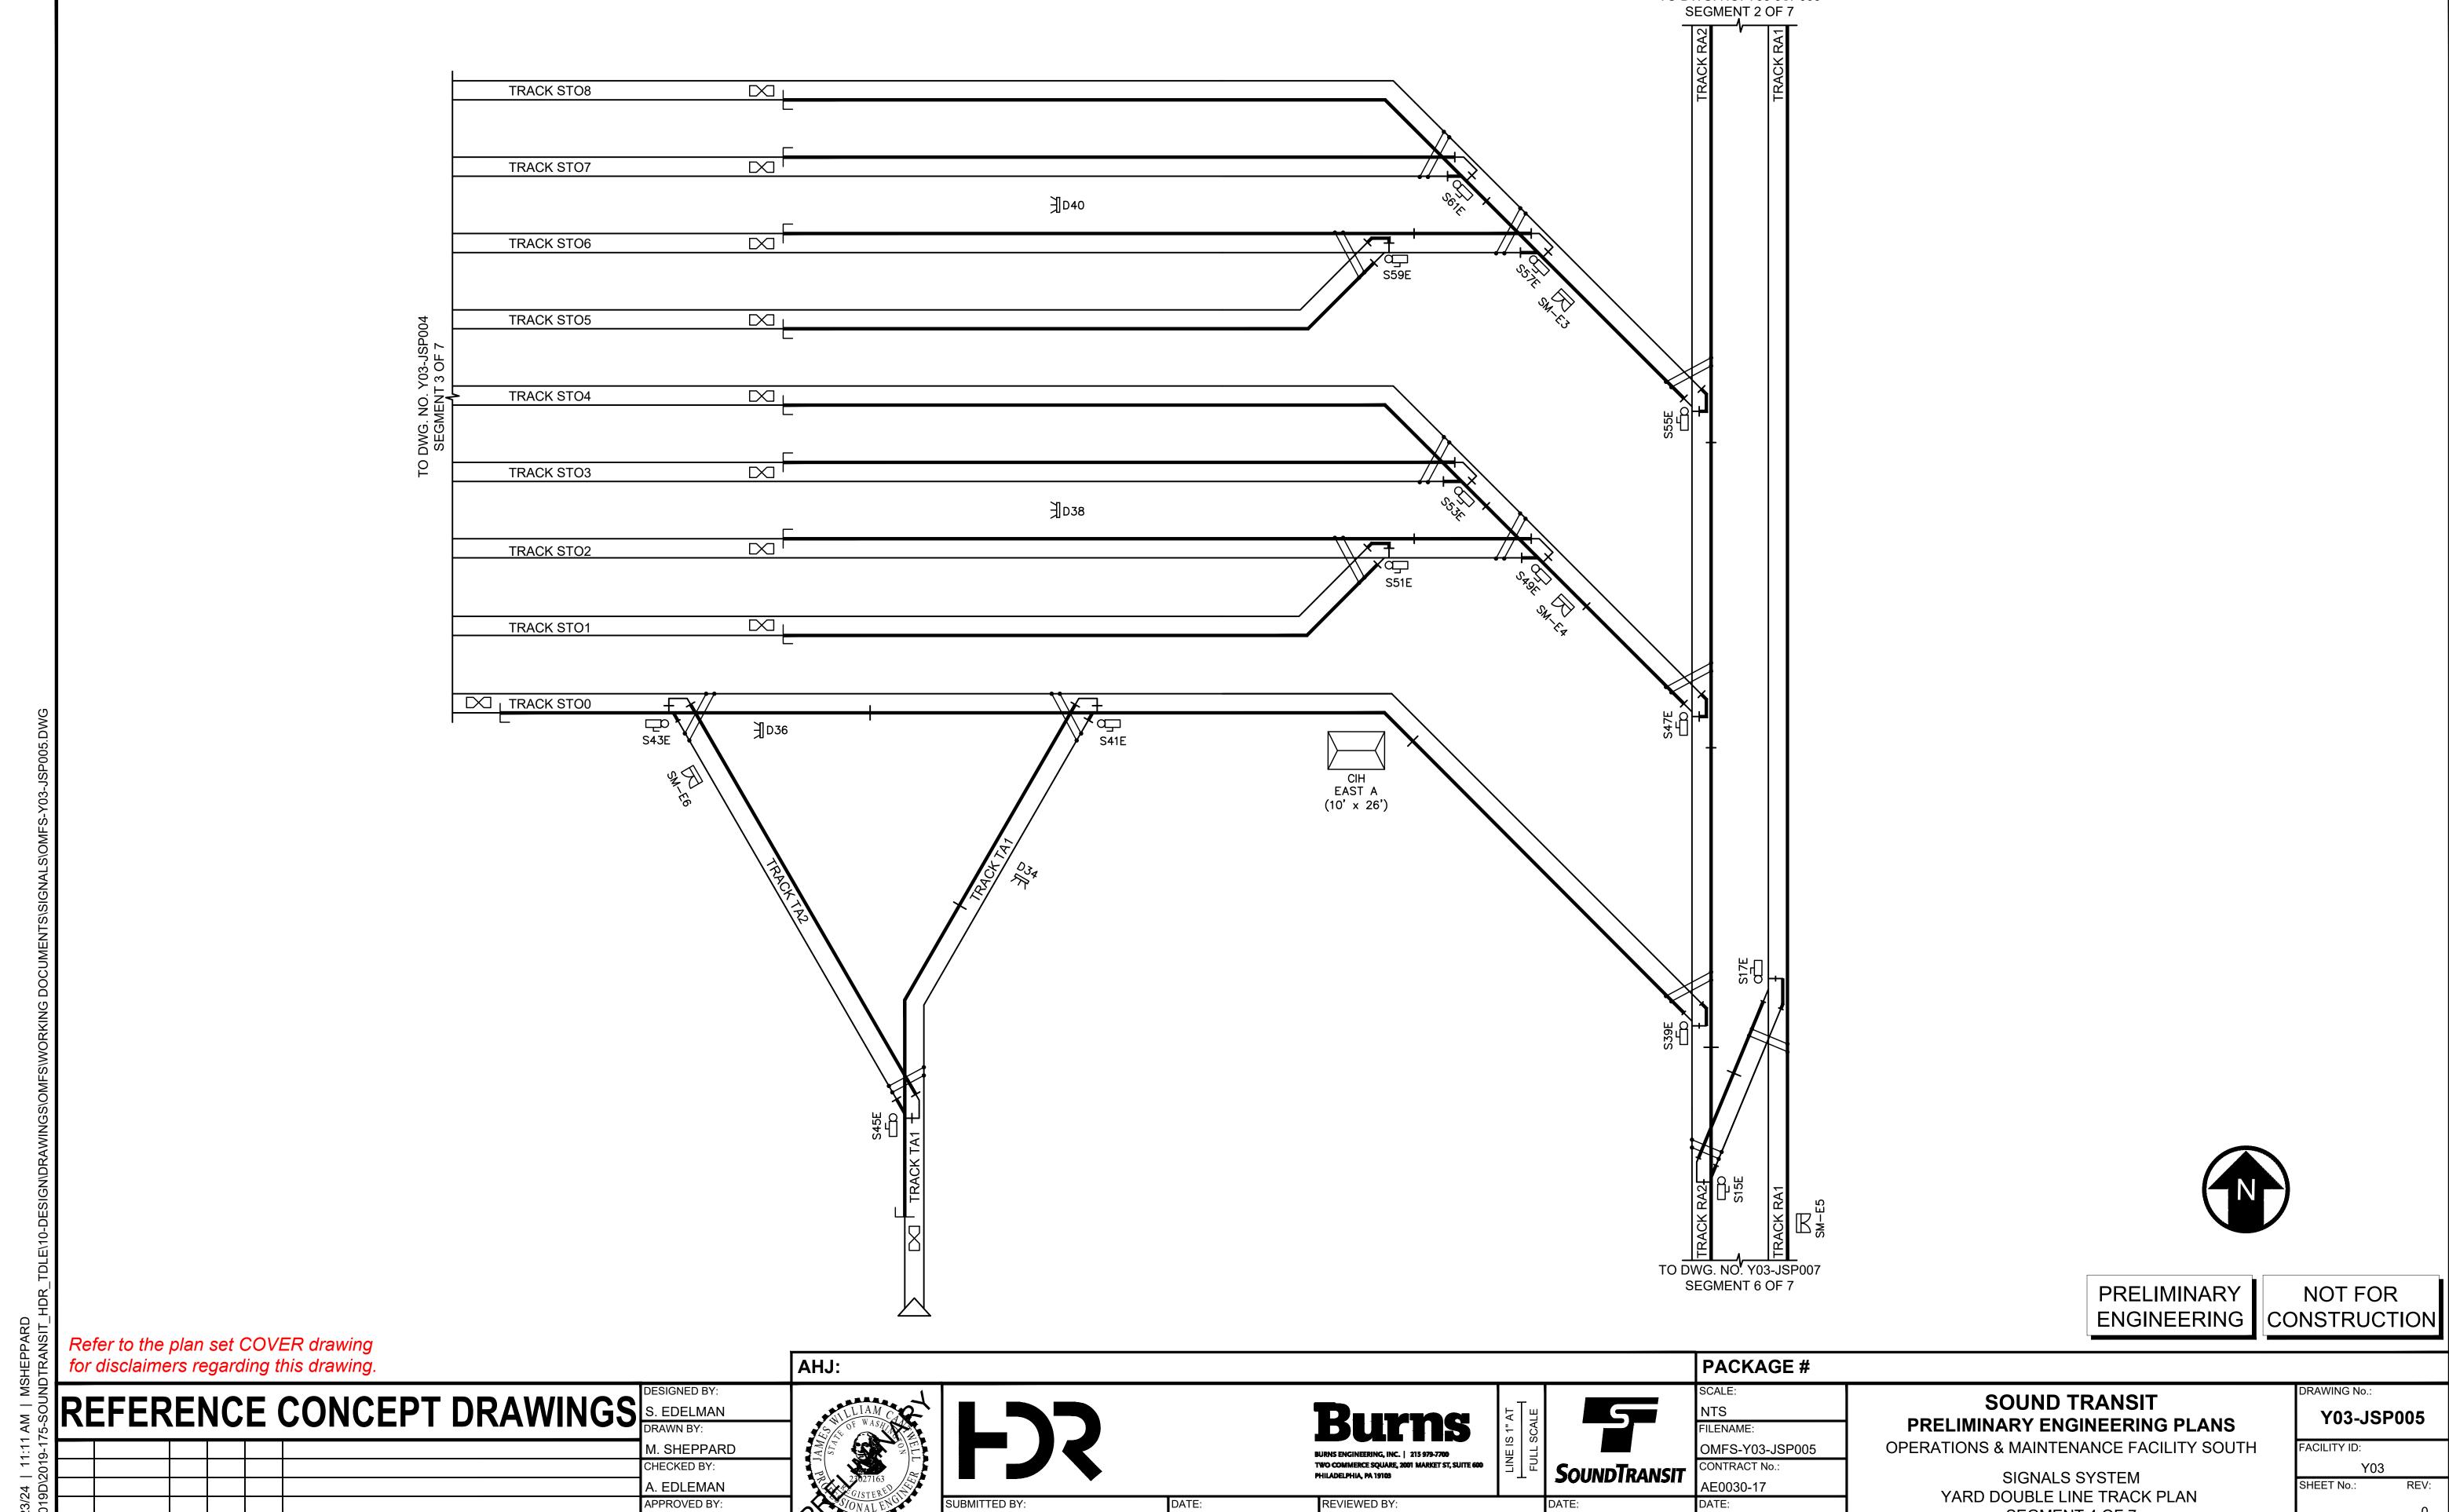

REVIEWED BY:


2/27/2024

PABLO LOPEZ-HILFIKER

J. CANTWELL

TO DWG. NO. Y03-JSP003


SEGMENT 4 OF 7

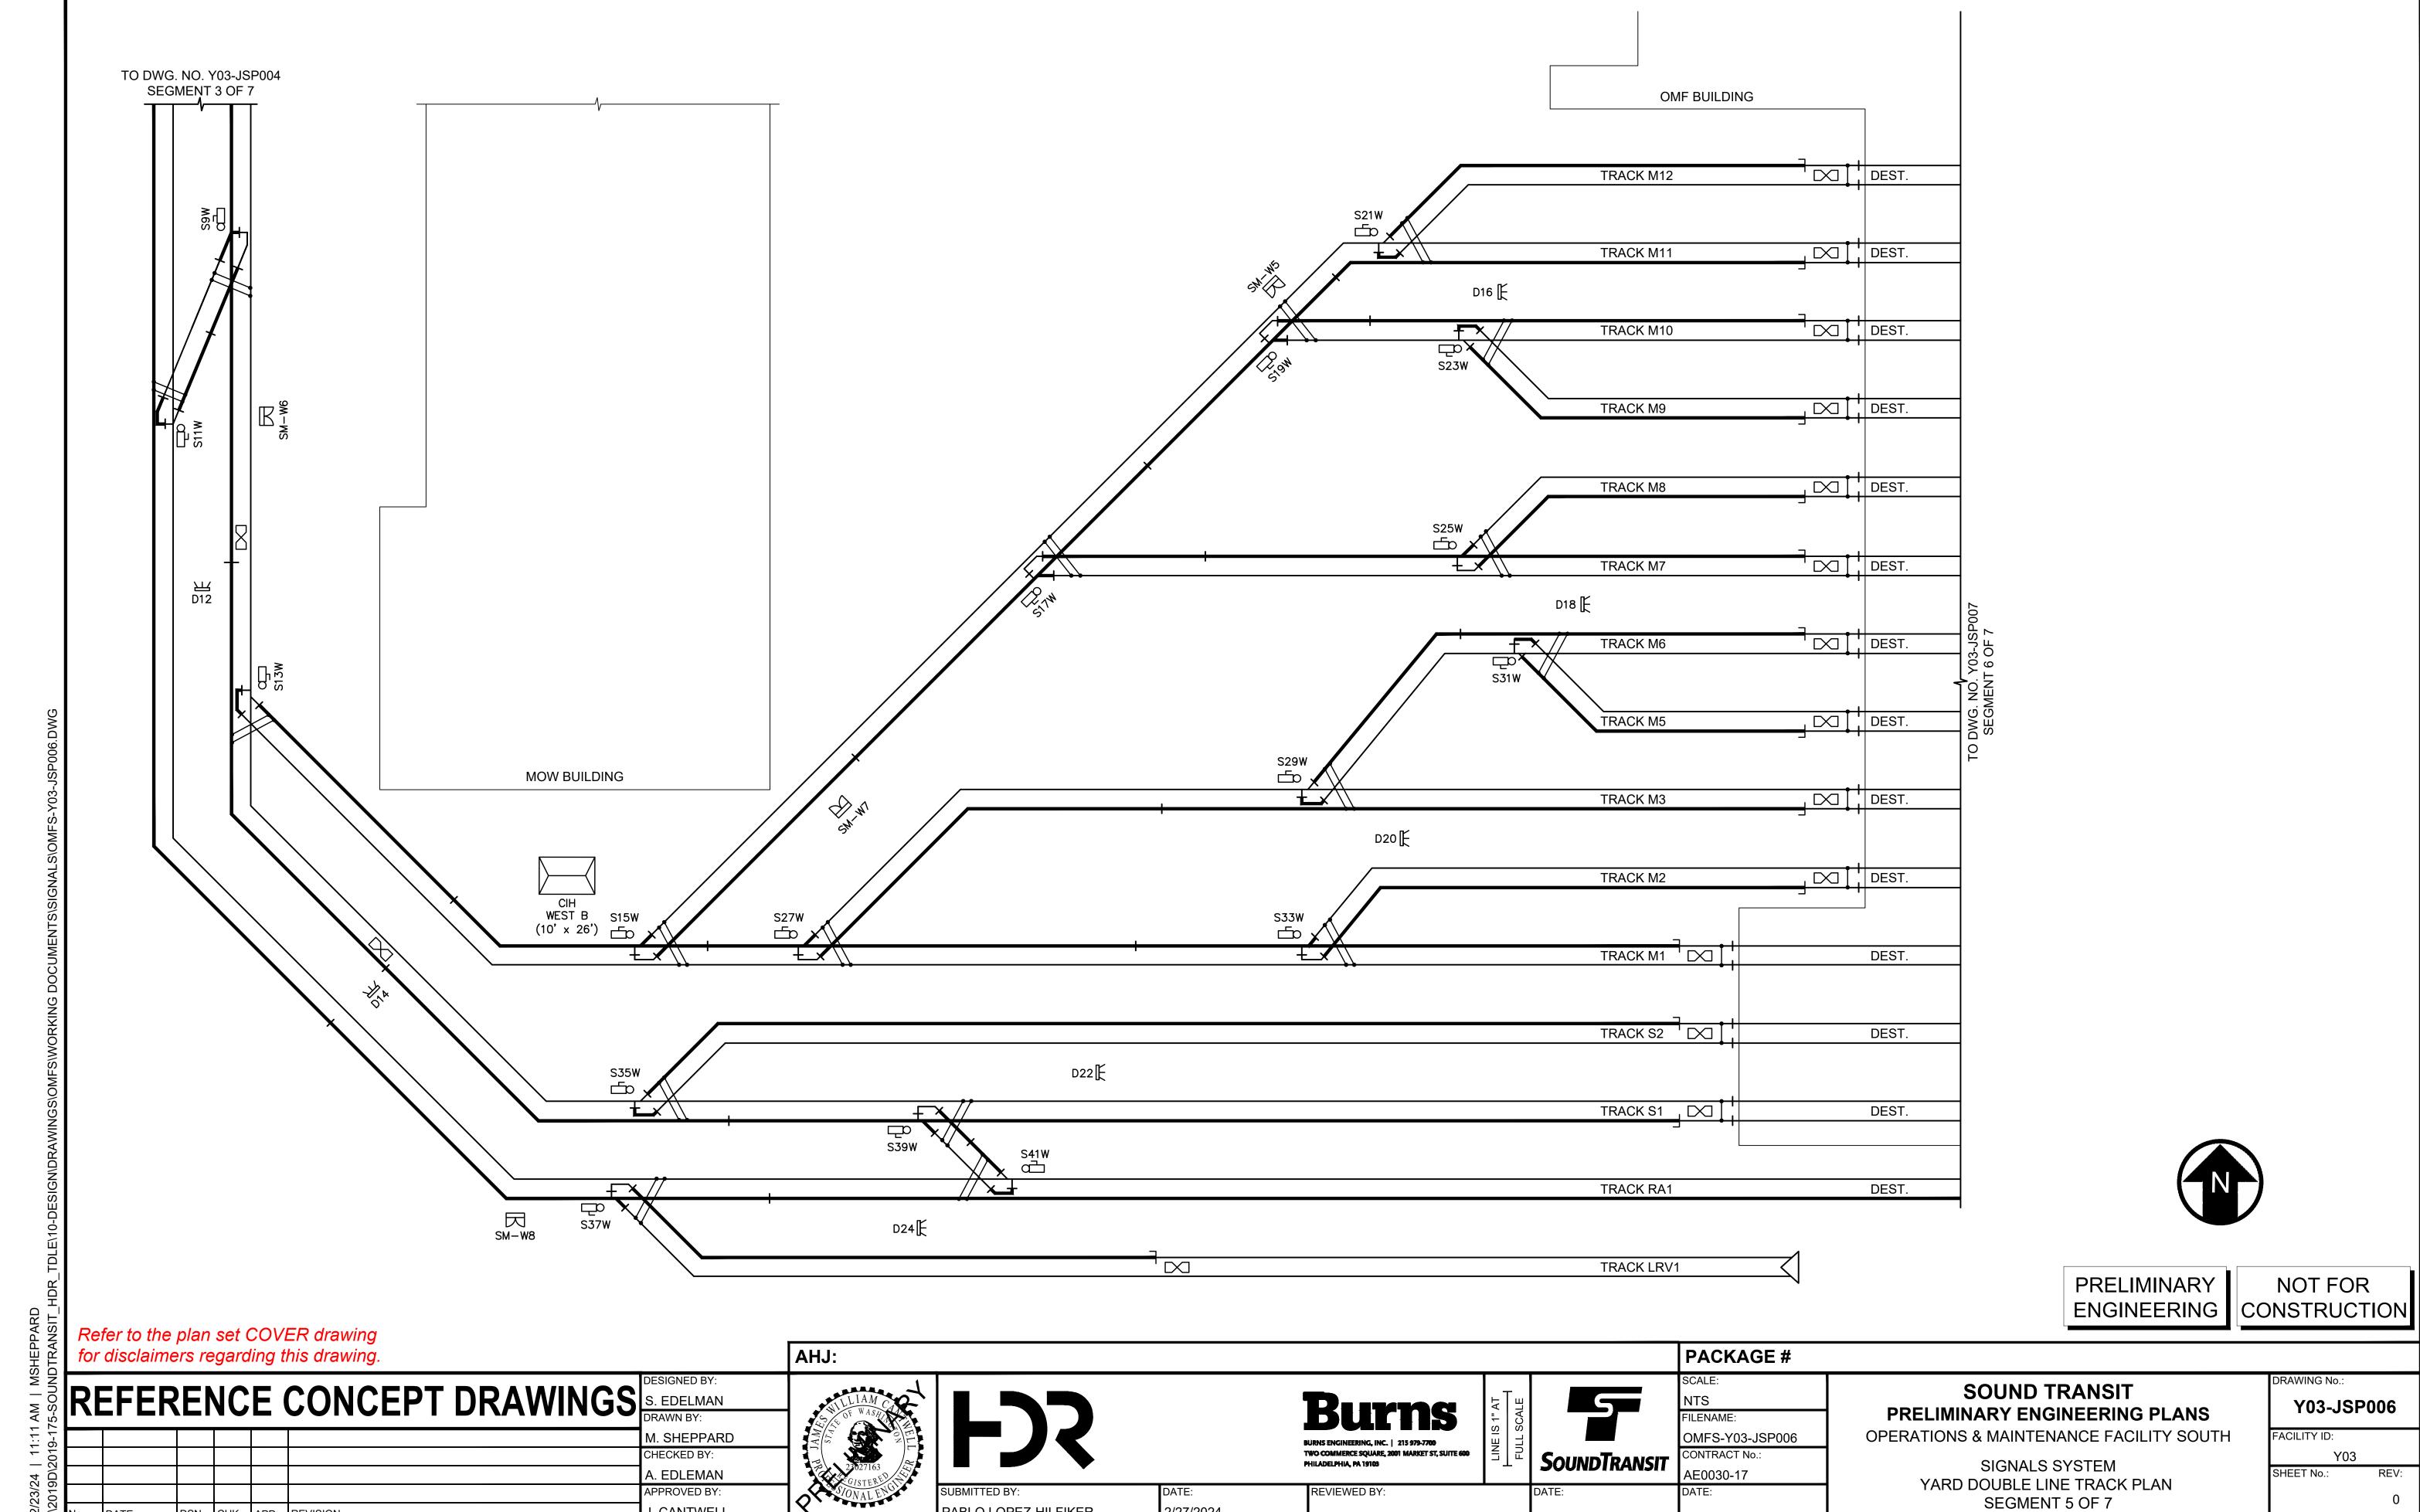

2/27/2024

J. CANTWELL

PABLO LOPEZ-HILFIKER

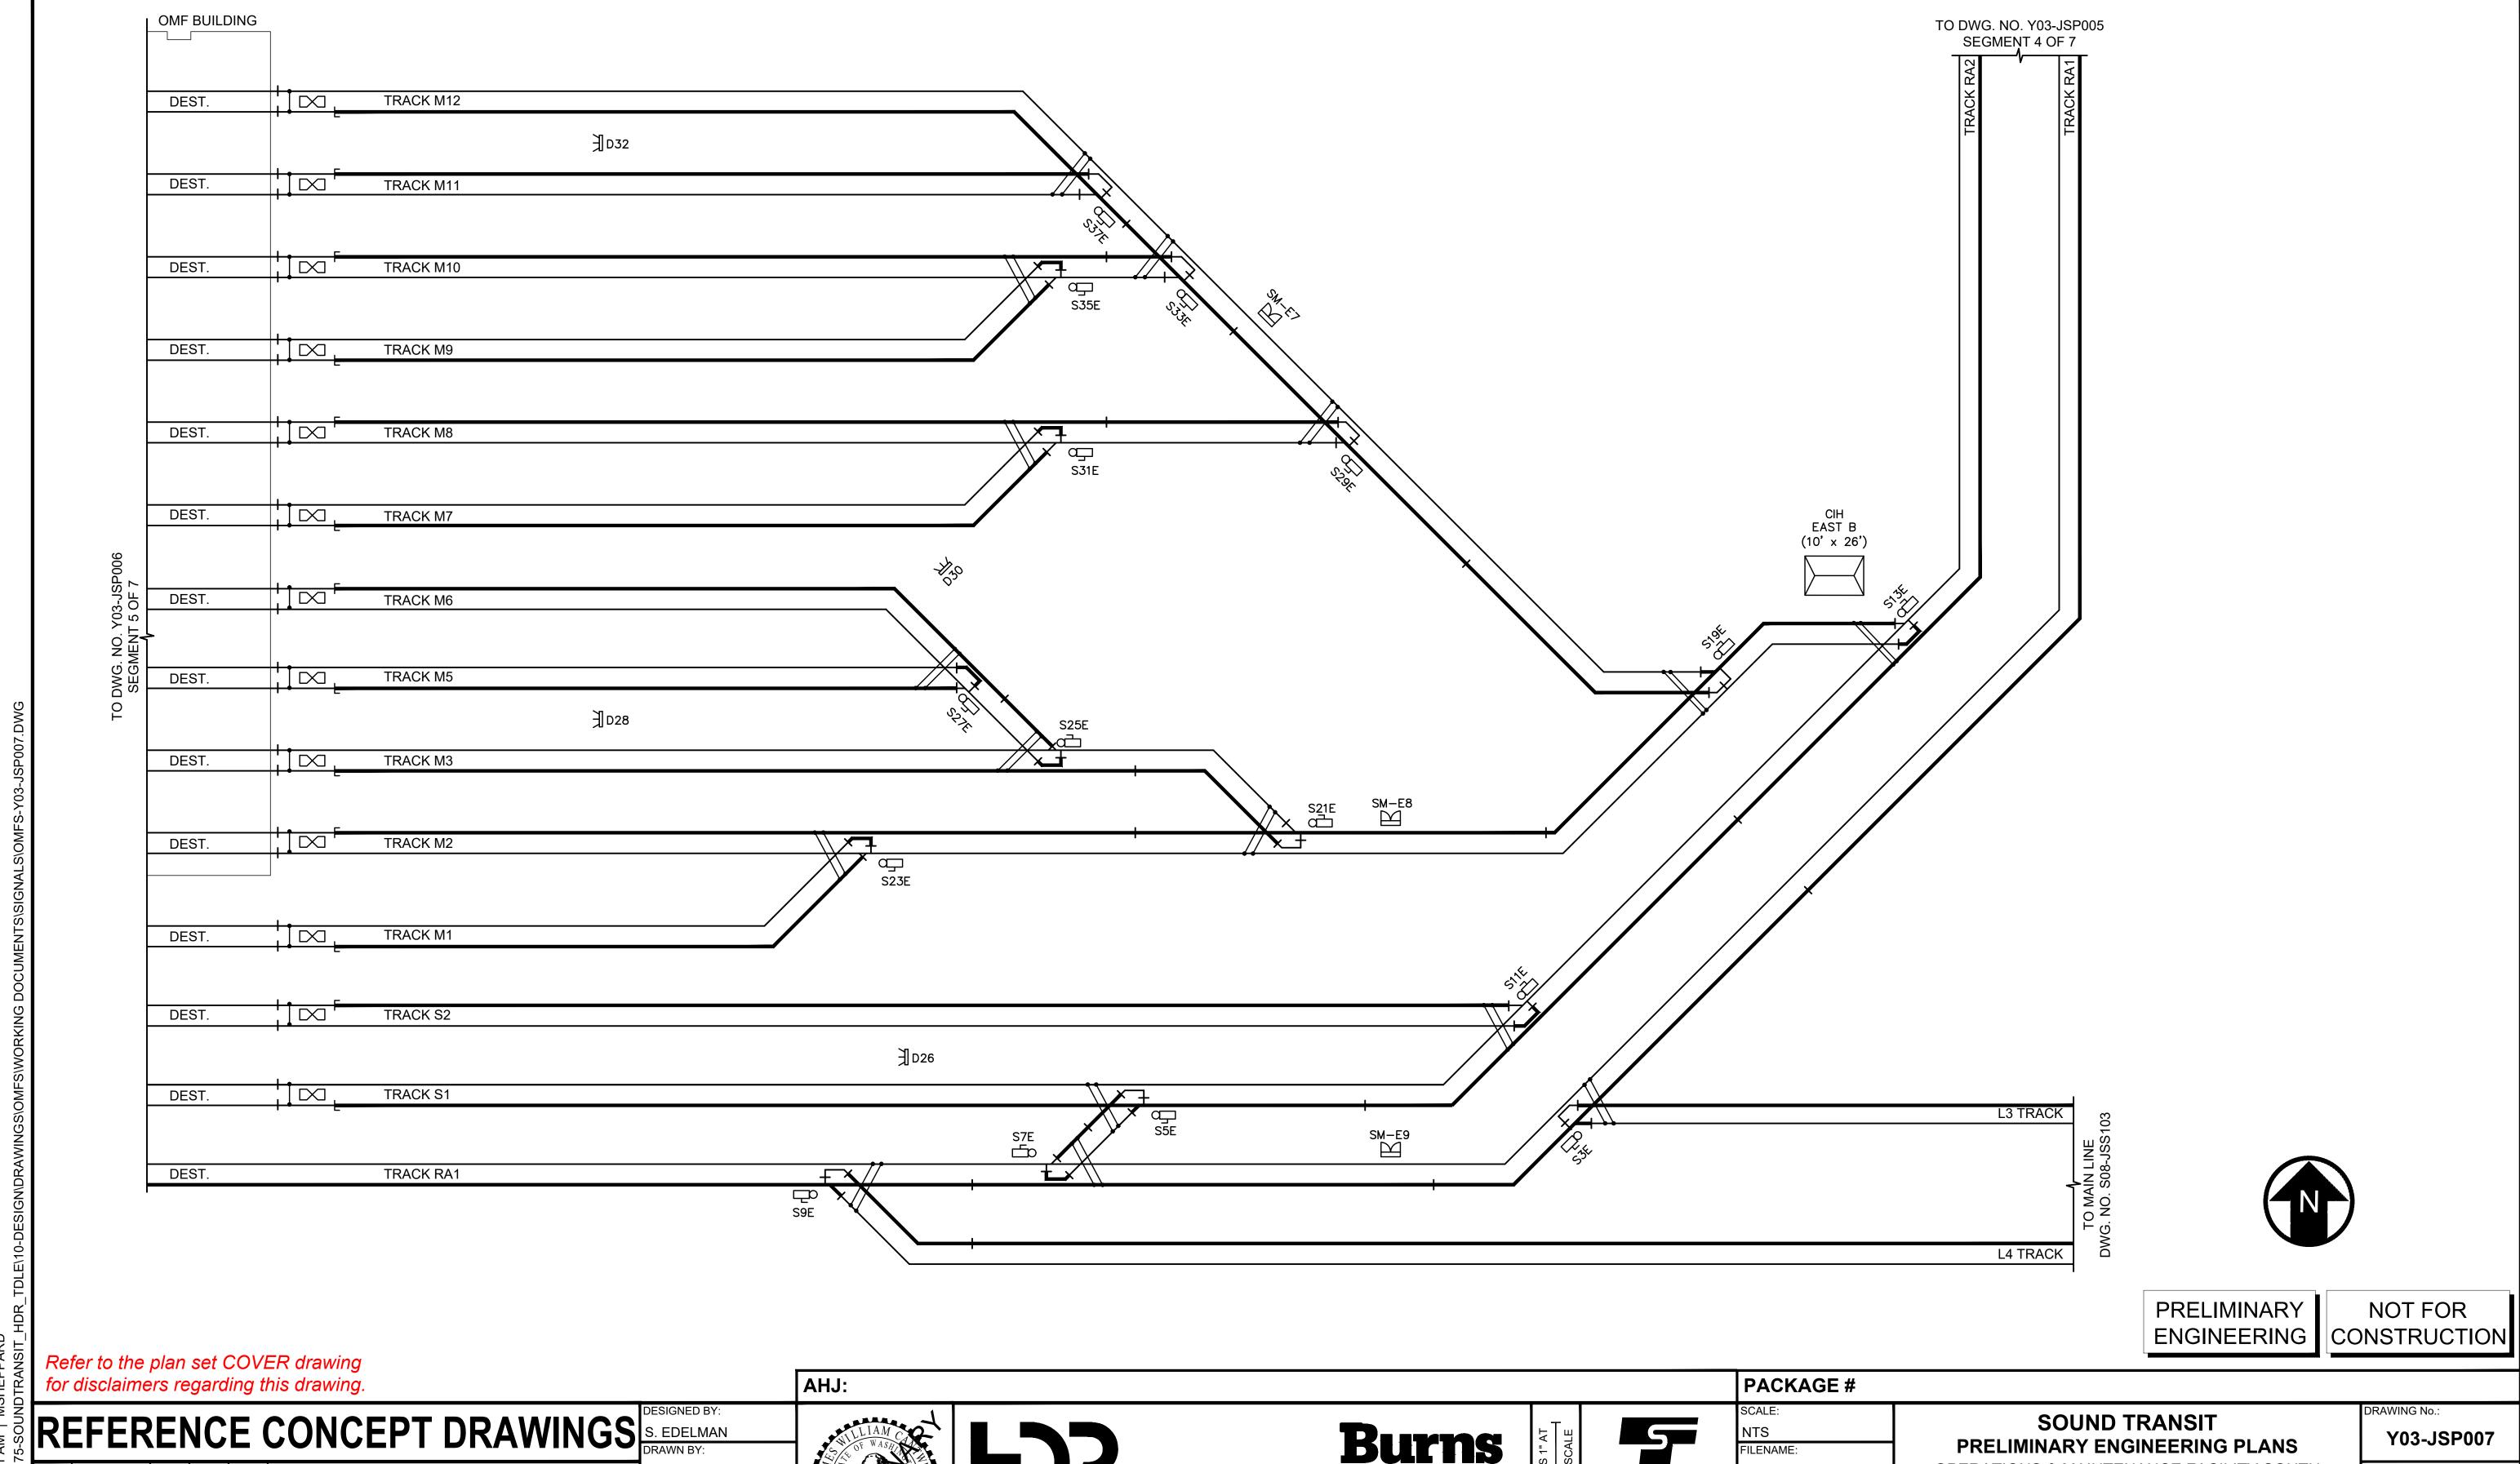

PABLO LOPEZ-HILFIKER

M. SHEPPARD

A. EDLEMAN

J. CANTWELL

APPROVED BY

CHECKED BY:

OPERATIONS & MAINTENANCE FACILITY SOUTH

SIGNALS SYSTEM

YARD DOUBLE LINE TRACK PLAN

SEGMENT 6 OF 7

FACILITY ID:

SHEET No.:

Y03

OMFS-Y03-JSP007

CONTRACT No.:

AE0030-17

SoundTransit


TWO COMMERCE SQUARE, 2001 MARKET ST, SUITE 600


PHILADELPHIA, PA 19103

REVIEWED BY:

2/27/2024

02/23/24 | 11:11 AM | MSHEPPARD

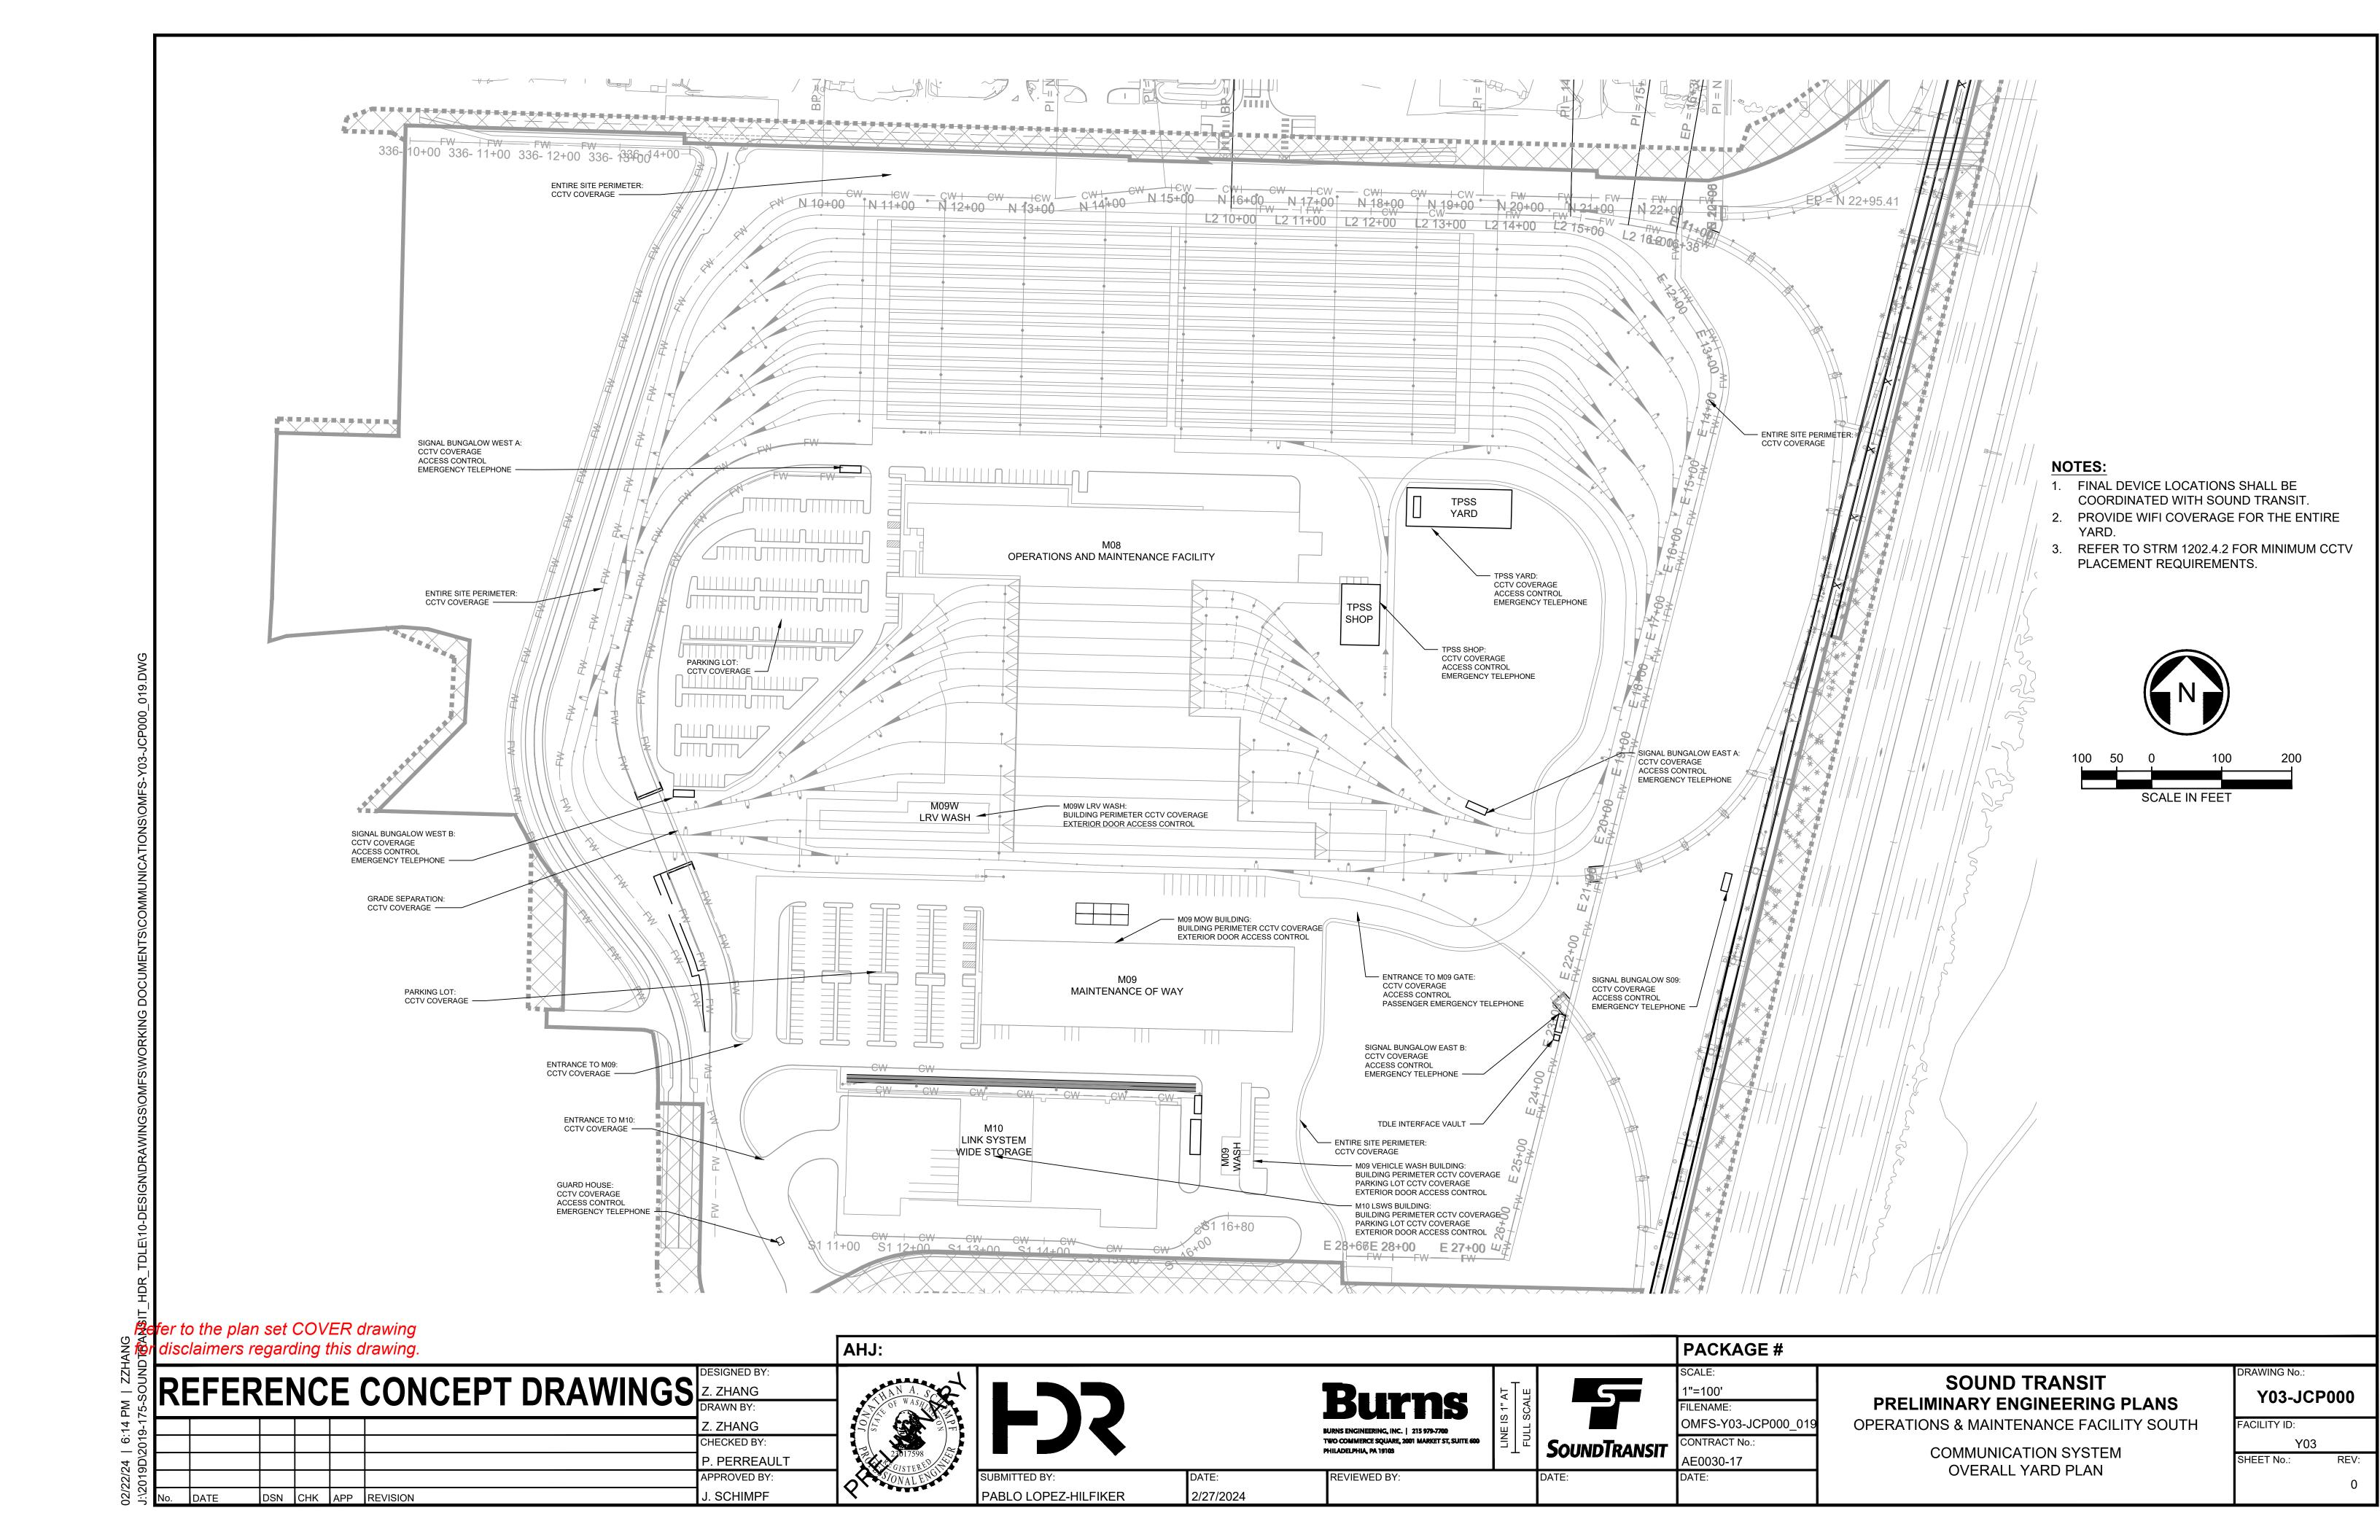

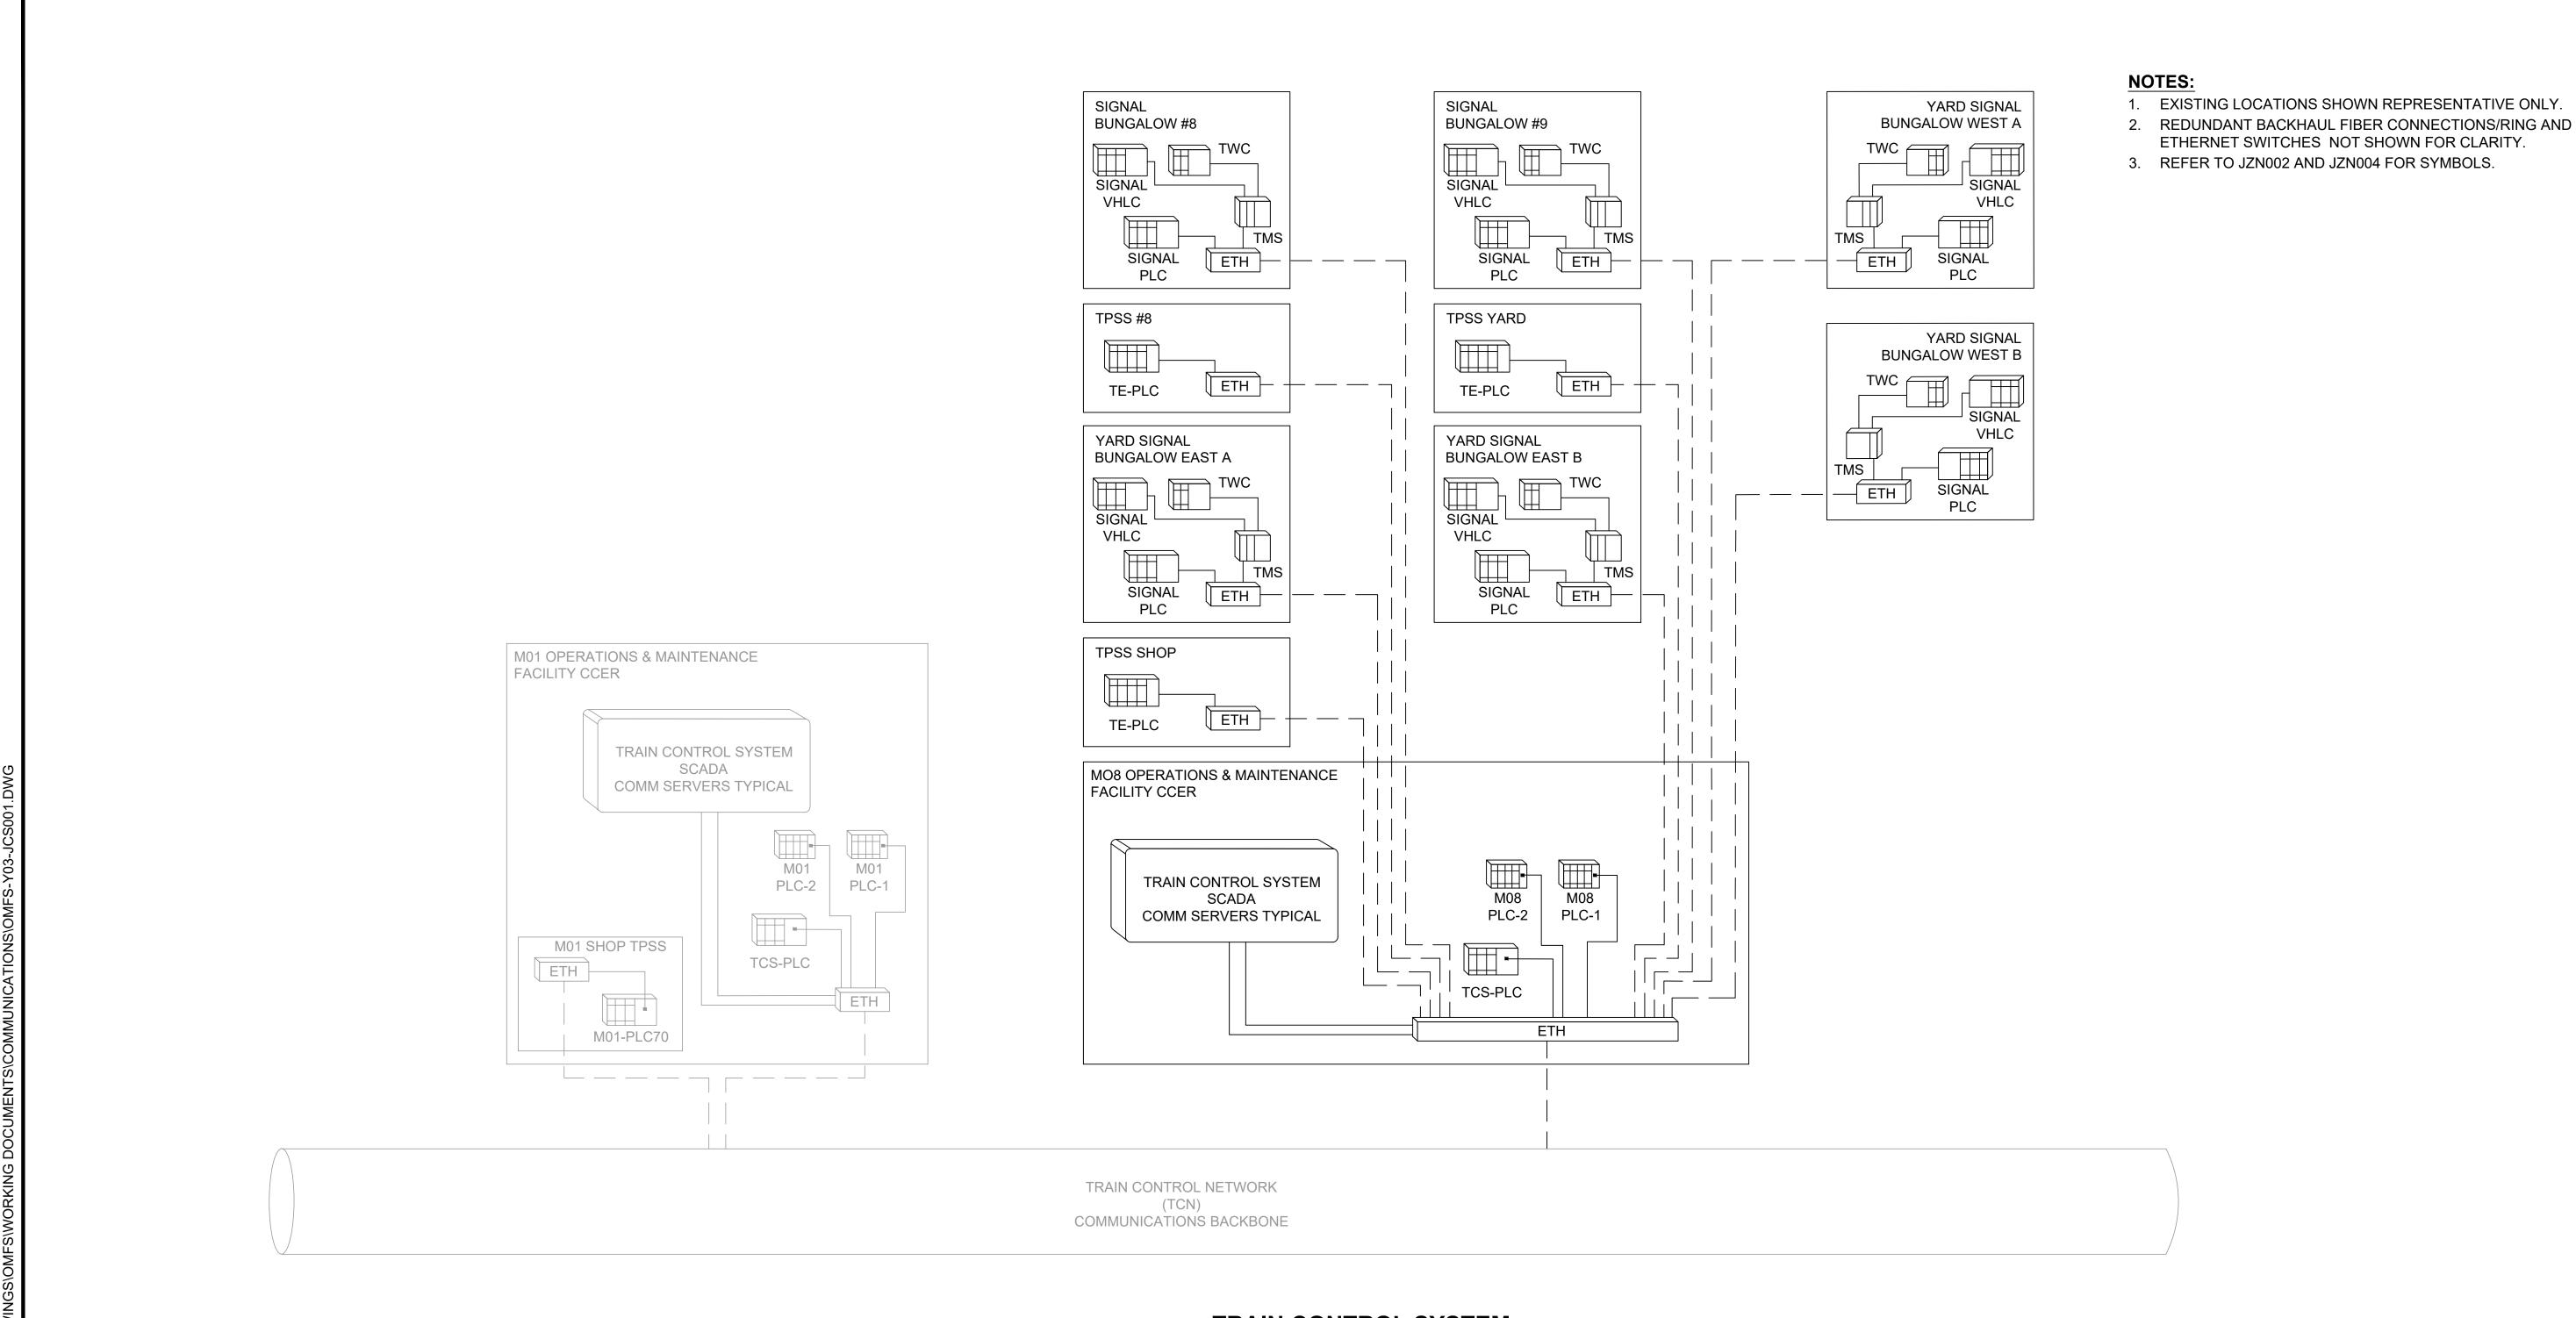

TRAIN CONTROL SYSTEM SCALE: NTS

2/27/2024

PRELIMINARY ENGINEERING CONSTRUCTION

NOT FOR

Refer to the plan set COVER drawing for disclaimers regarding this drawing.

REFERENCE CONCEPT DRAWINGS Z. ZHANG DRAWN BY: Z. ZHANG CHECKED BY: P. PERREAUL^{*} APPROVED BY: J. SCHIMPF DSN CHK APP REVISION

AHJ: PABLO LOPEZ-HILFIKER

Burns BURNS ENGINEERING, INC. | 215 979-7700 TWO COMMERCE SQUARE, 2001 MARKET ST, SUITE 600

REVIEWED BY:

SOUNDTRANSIT

PACKAGE # FILENAME: OMFS-Y03-JCS001 AE0030-17


SOUND TRANSIT PRELIMINARY ENGINEERING PLANS

OPERATIONS & MAINTENANCE FACILITY SOUTH COMMUNICATION SYSTEM SYSTEM WIDE OVERVIEW DIAGRAM

TRAIN CONTROL SYSTEM

Y03-JCS001 FACILITY ID:

Y03, M08, S08

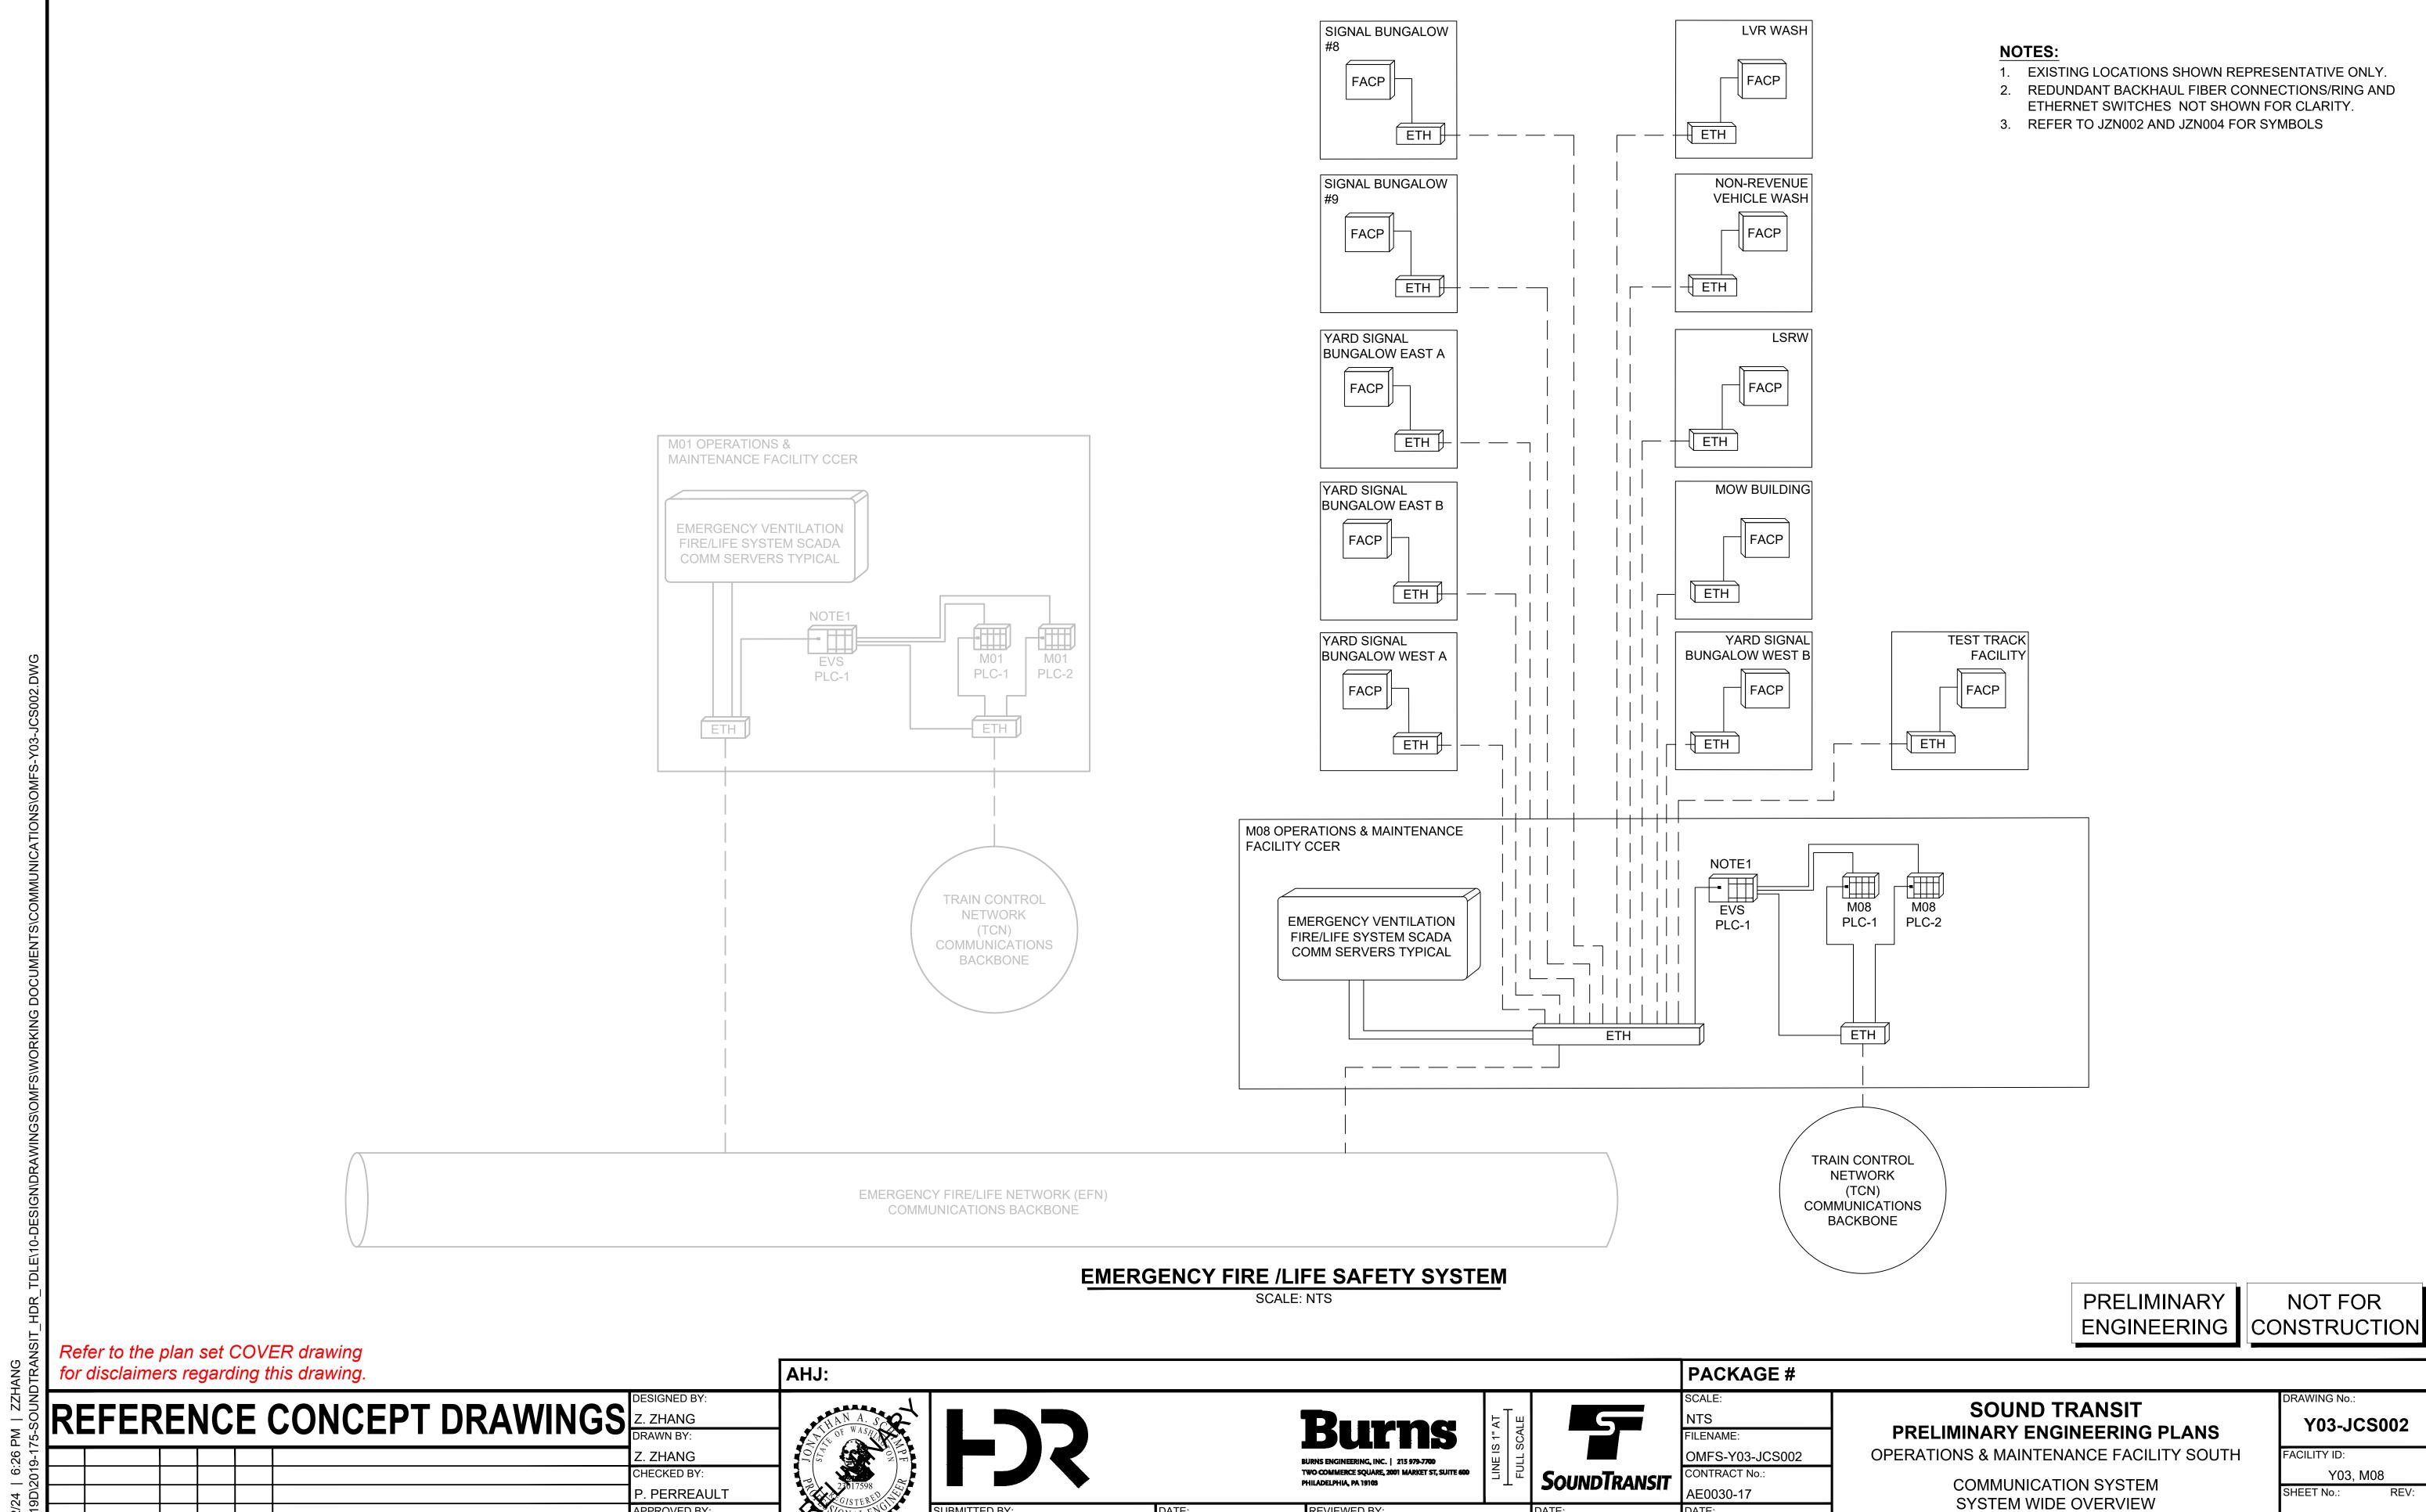

REVIEWED BY:

2/27/2024


PABLO LOPEZ-HILFIKER

EMERGENCY FIRE/LIFE SAFETY SYSTEM

CHK APP REVISION

APPROVED BY

J. SCHIMPF

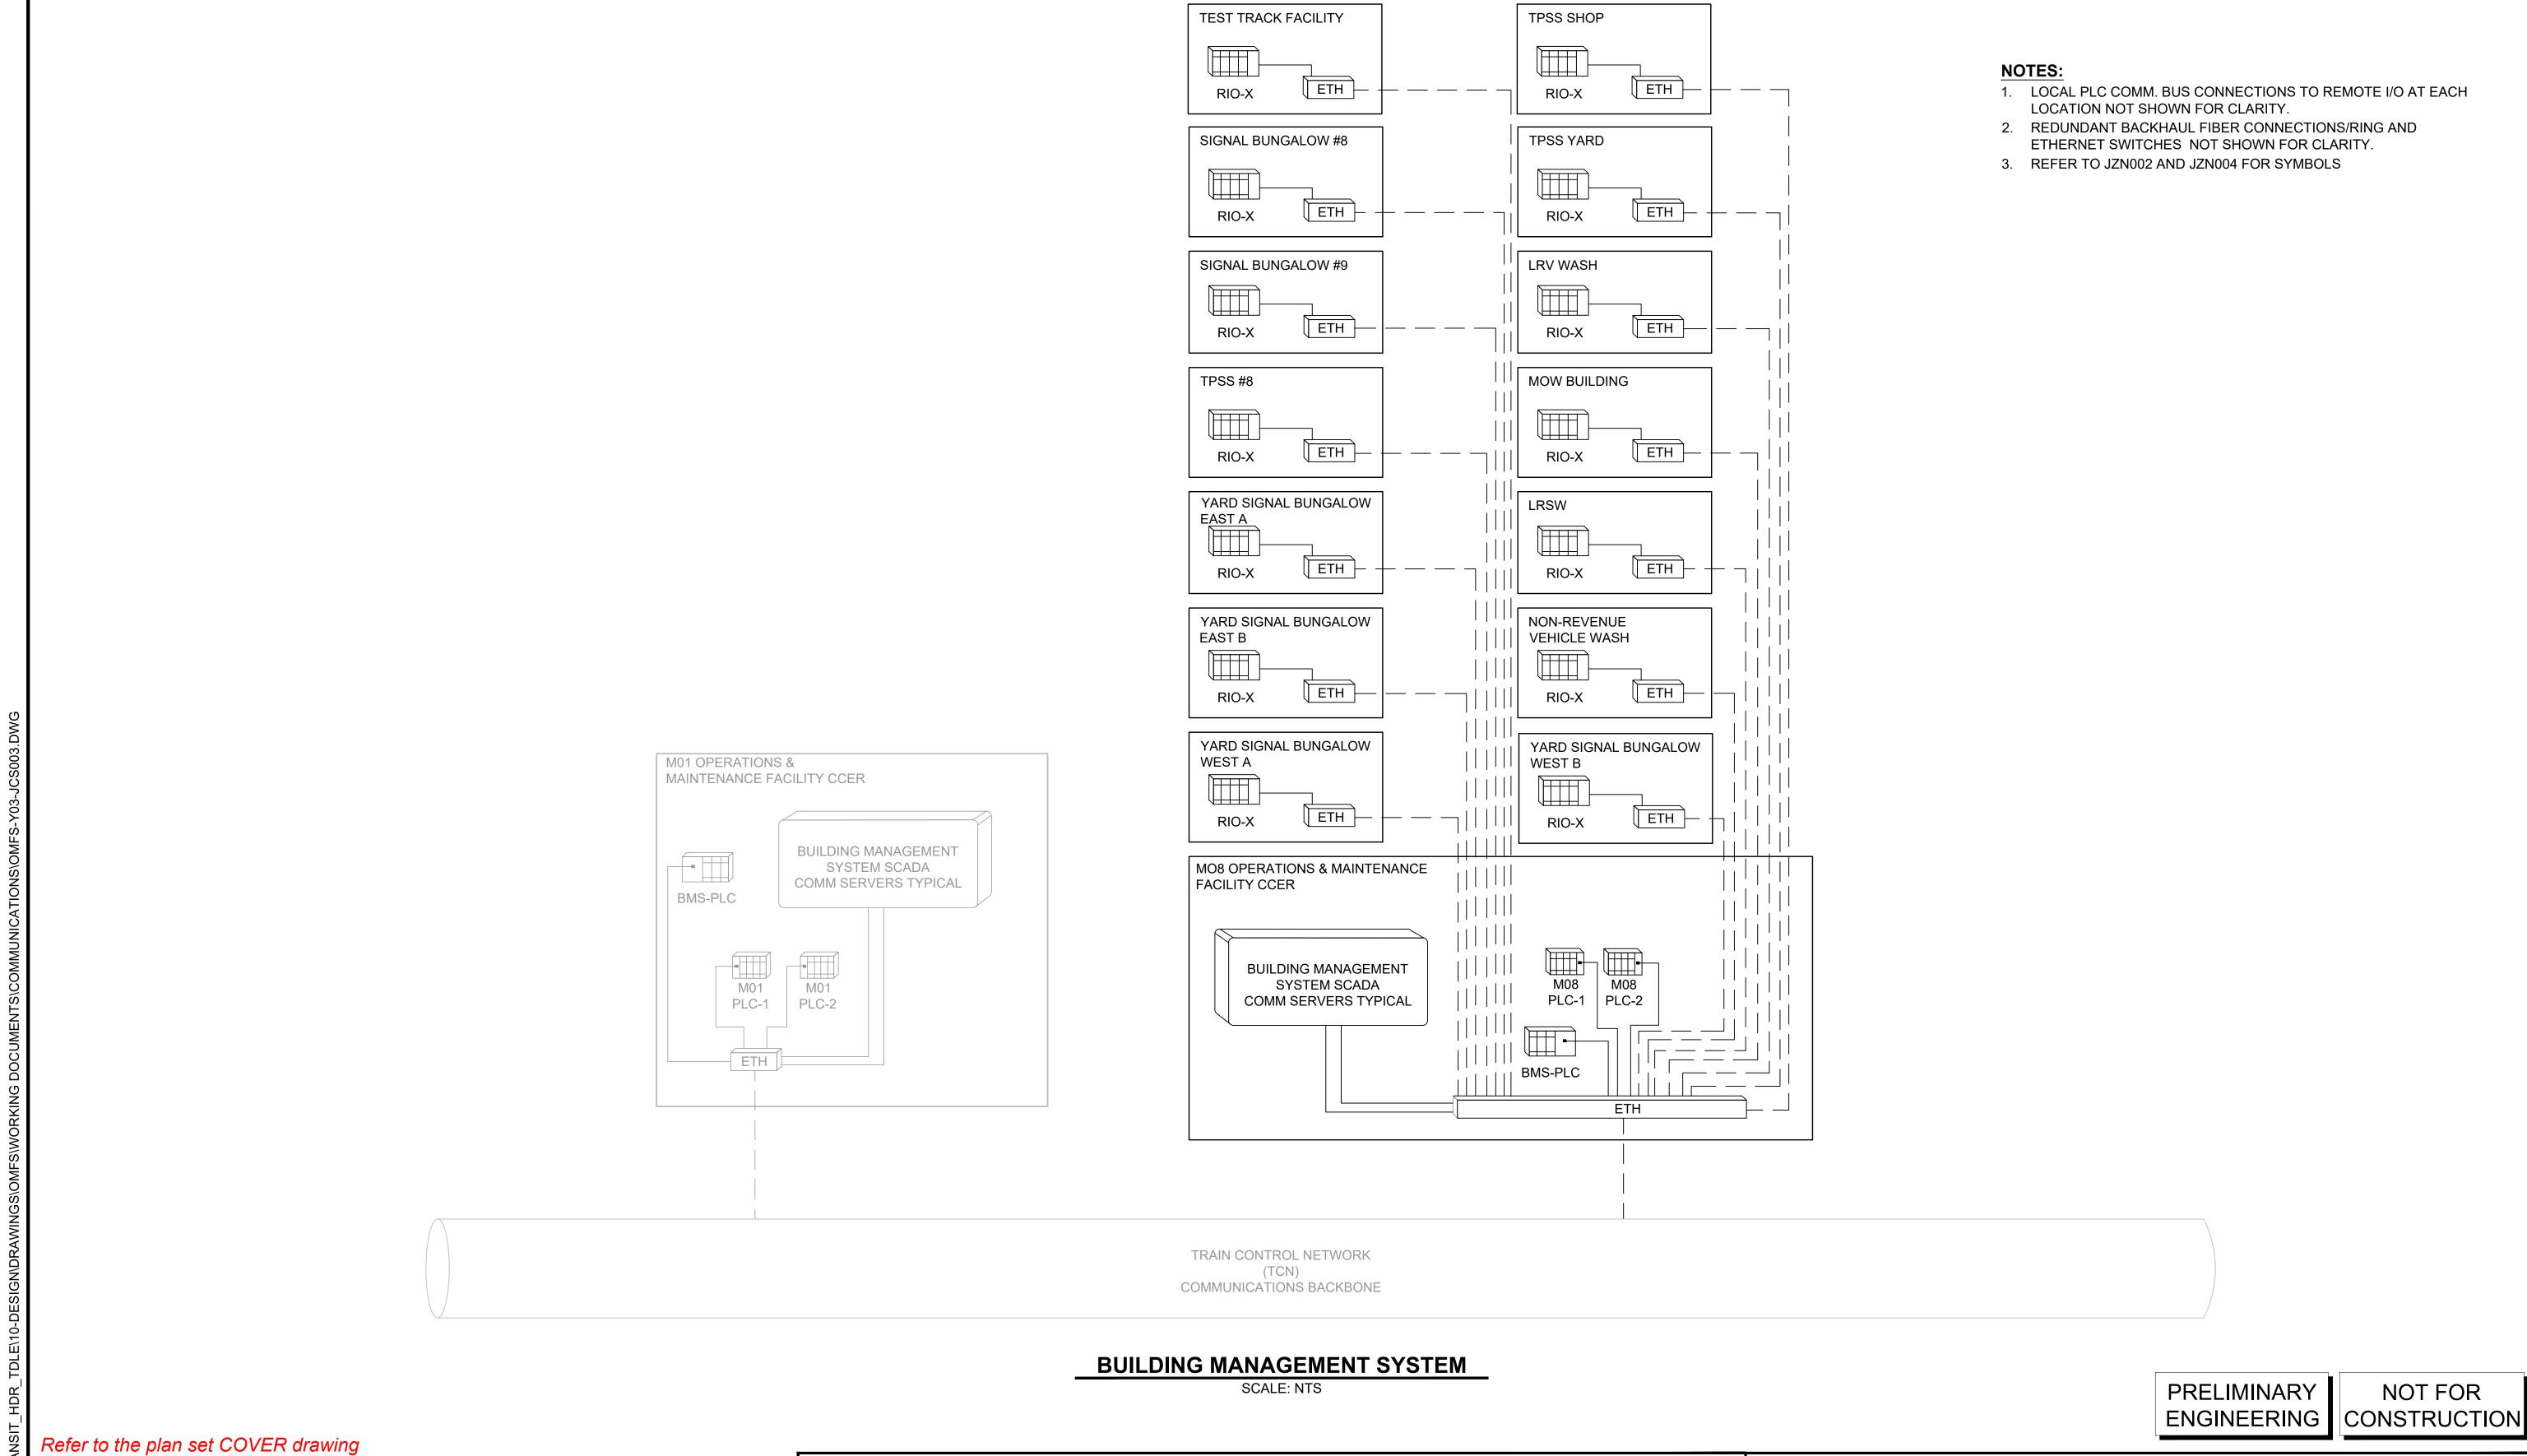

for disclaimers regarding this drawing.

REFERENCE CONCEPT DRAWINGS Z. ZHANG DRAWN BY: CHECKED BY: P. PERREAULT APPROVED BY J. SCHIMPF CHK APP REVISION

AHJ:

PABLO LOPEZ-HILFIKER

Burns TWO COMMERCE SQUARE, 2001 MARKET ST, SUITE 600 PHILADELPHIA, PA 19103

2/27/2024

REVIEWED BY:

5 SoundTransit

FILENAME: OMFS-Y03-JCS003 CONTRACT No.: AE0030-17


PACKAGE #


SOUND TRANSIT PRELIMINARY ENGINEERING PLANS **OPERATIONS & MAINTENANCE FACILITY SOUTH**


> COMMUNICATION SYSTEM SYSTEM WIDE OVERVIEW DIAGRAM **BUILDING MANAGEMENT SYSTEM**


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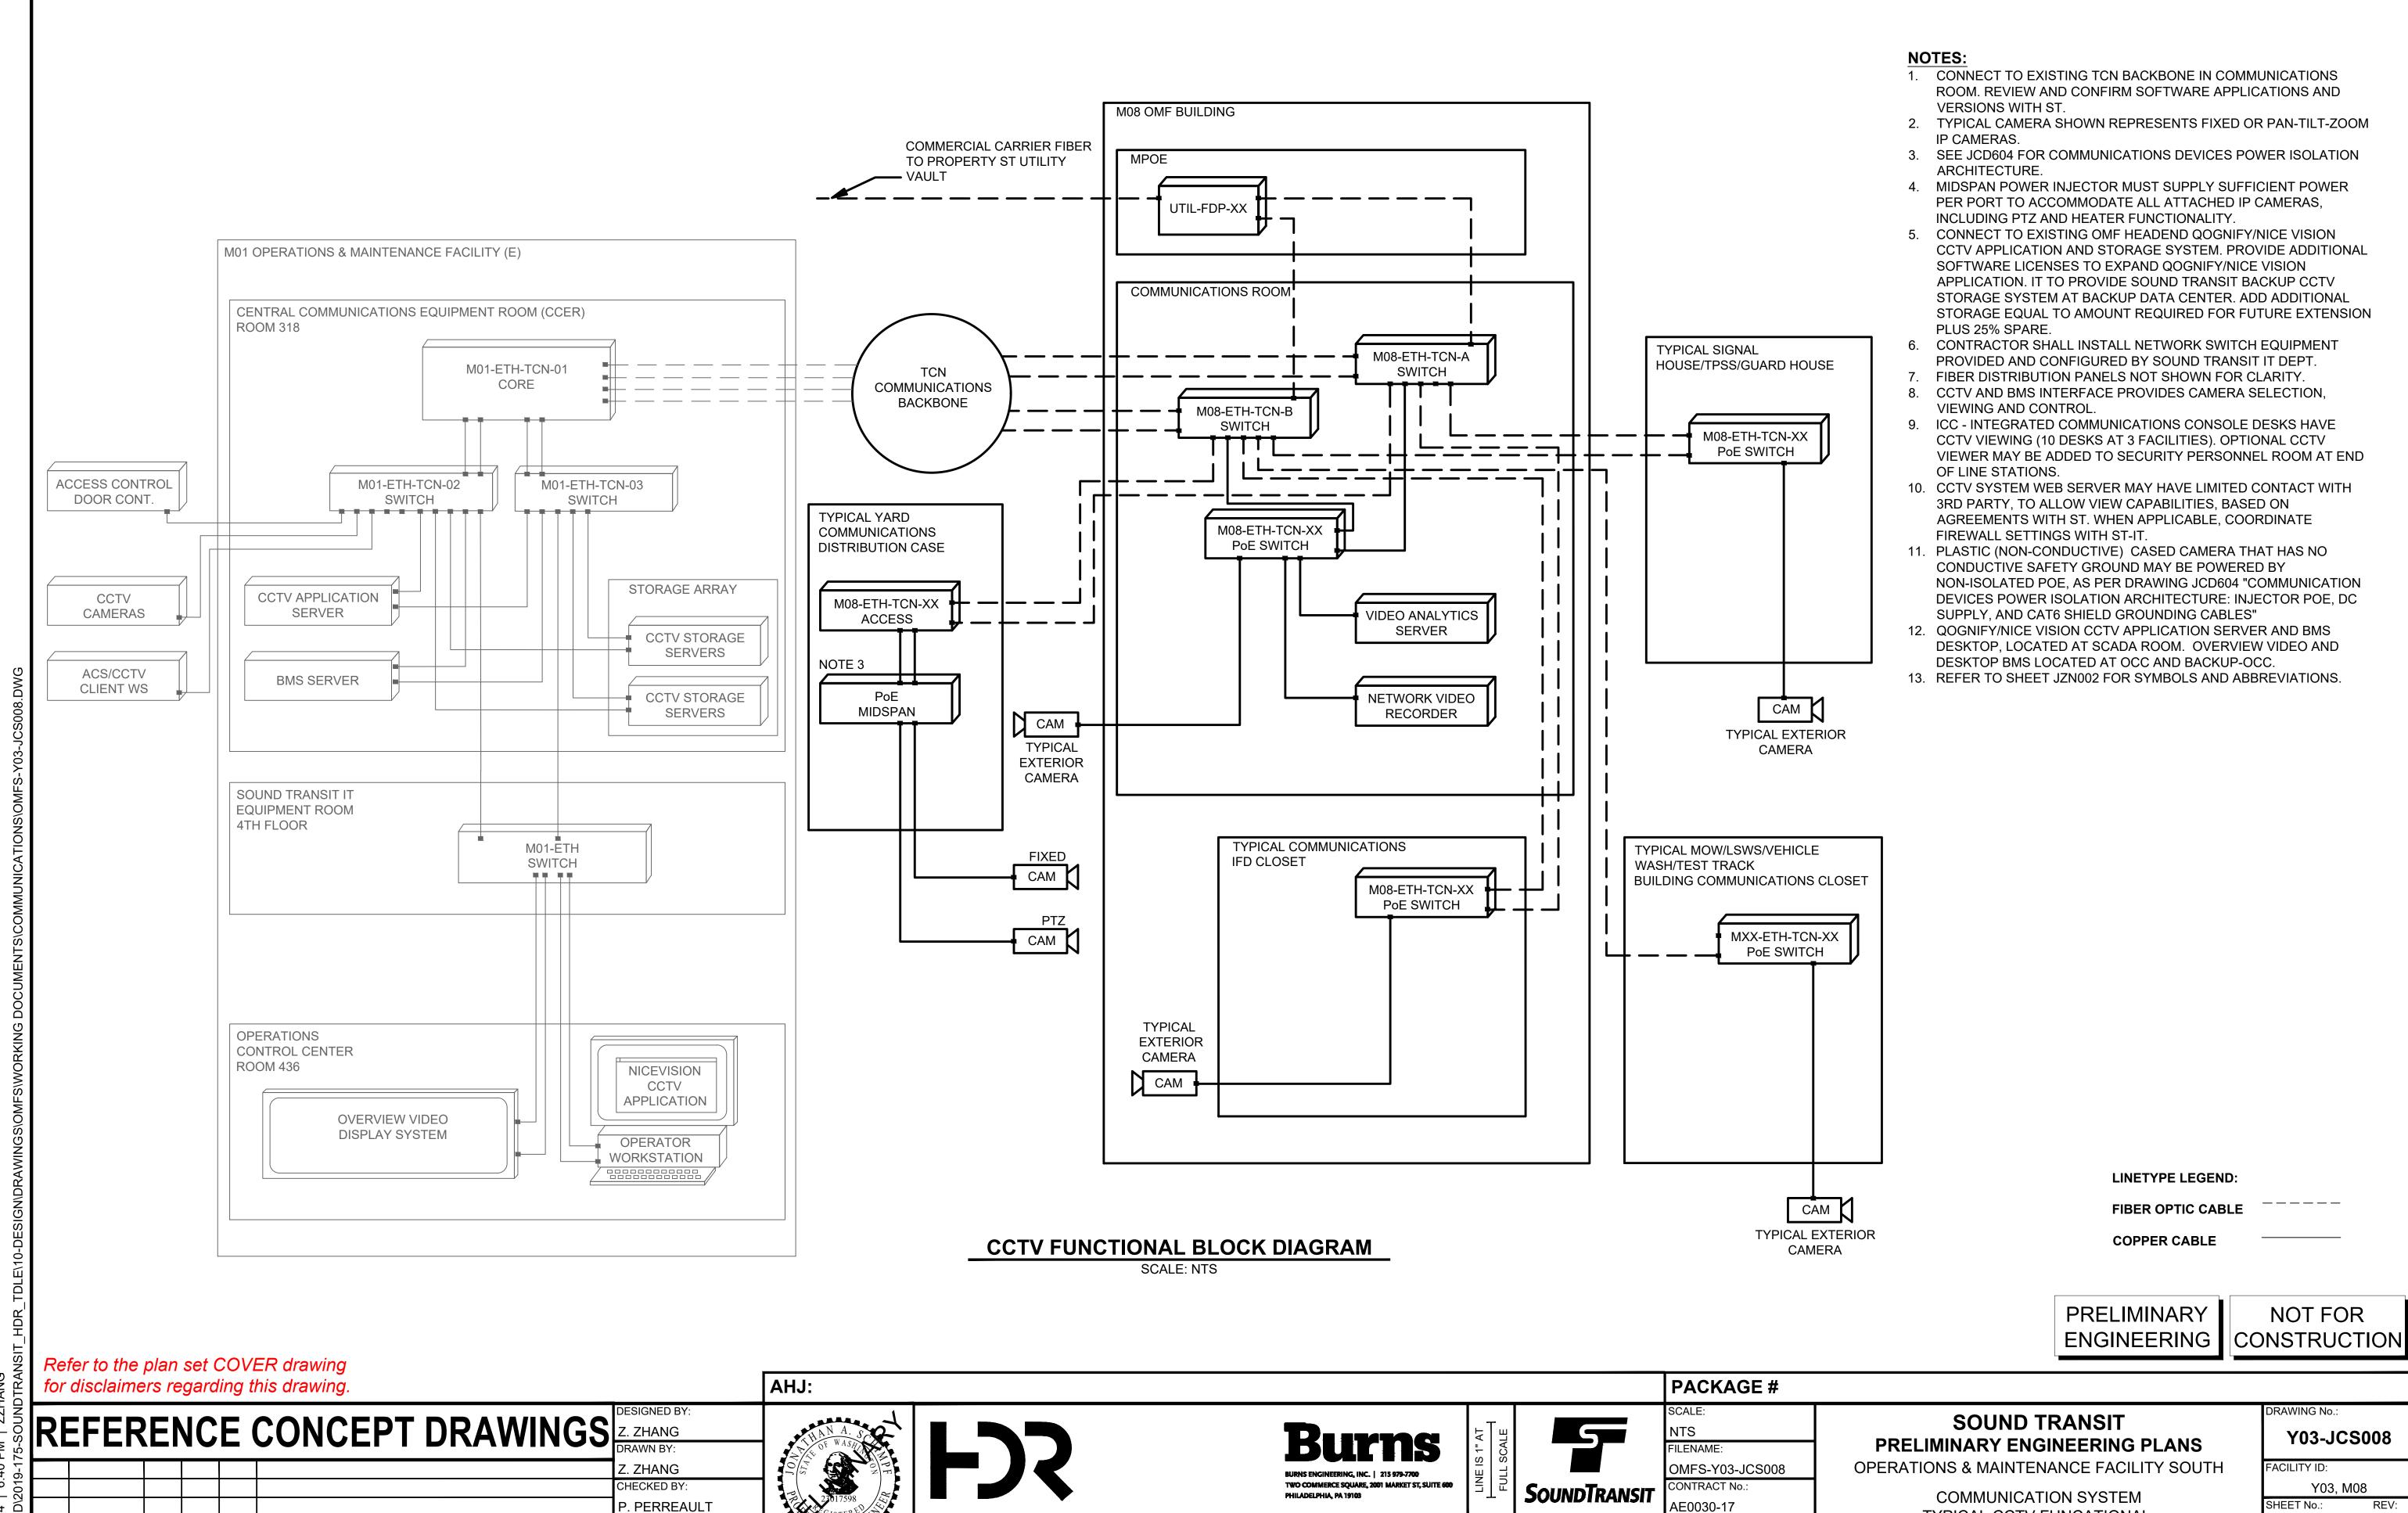
FACILITY ID: Y03, M08, S08 SHEET No.:



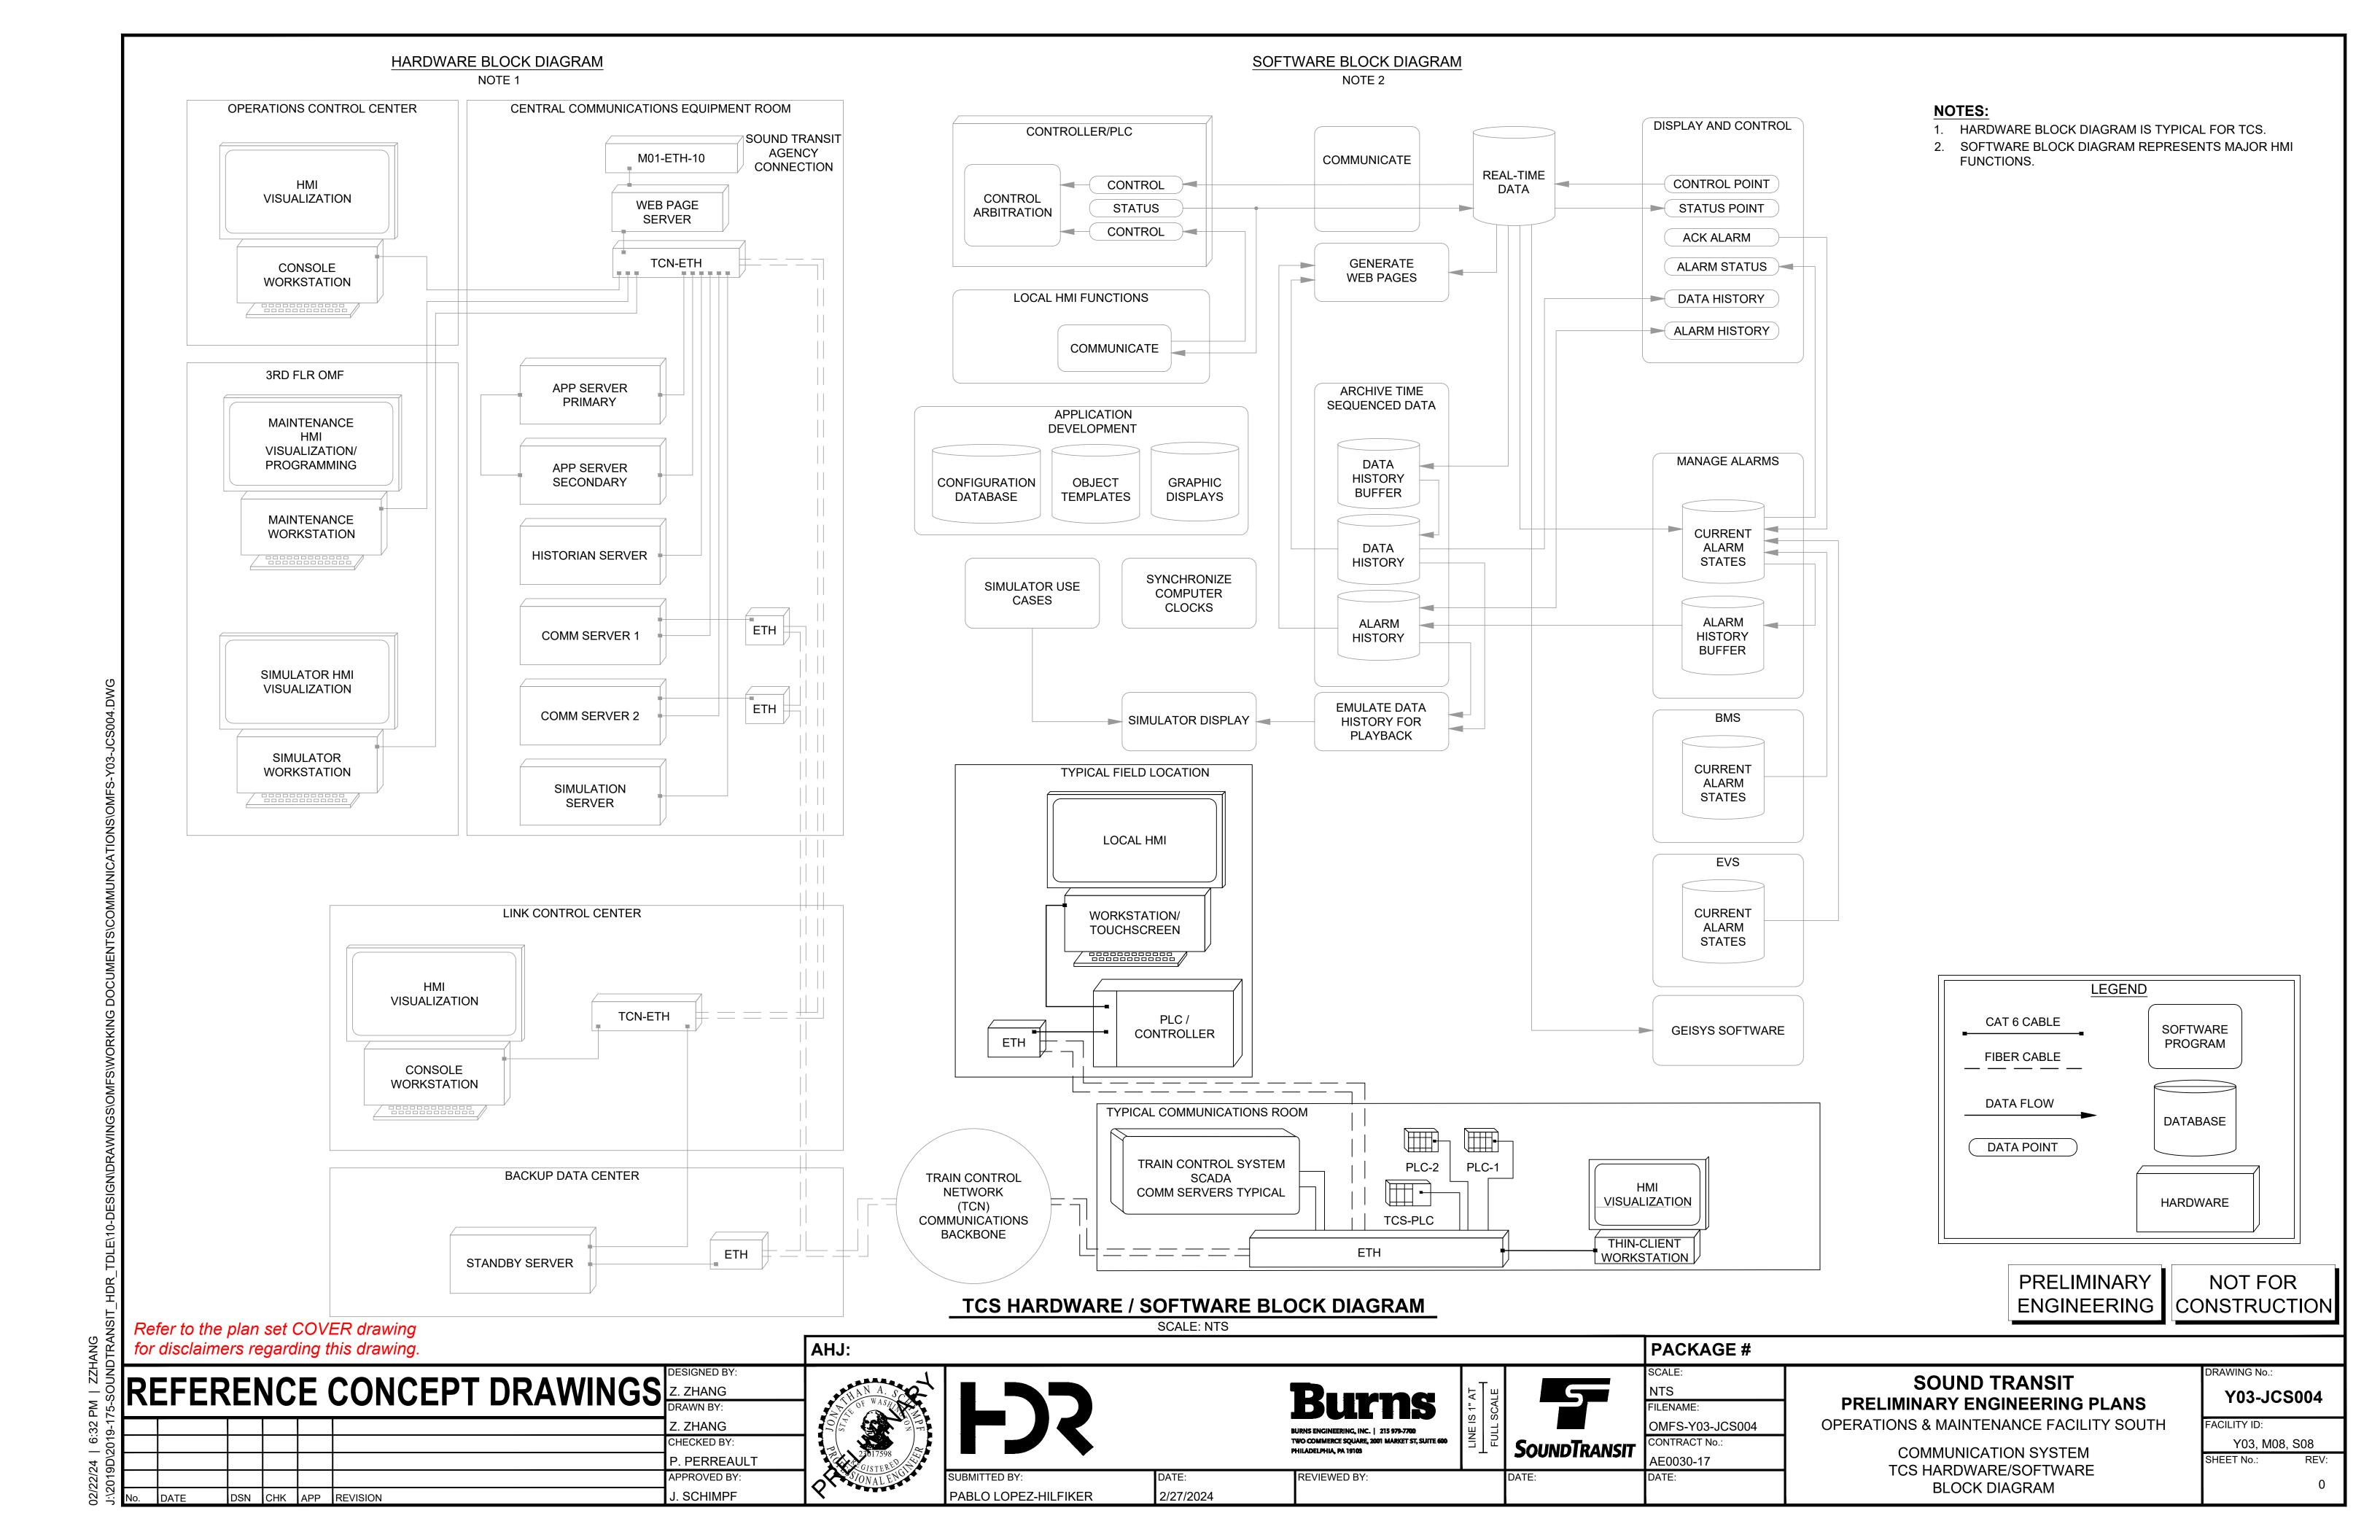

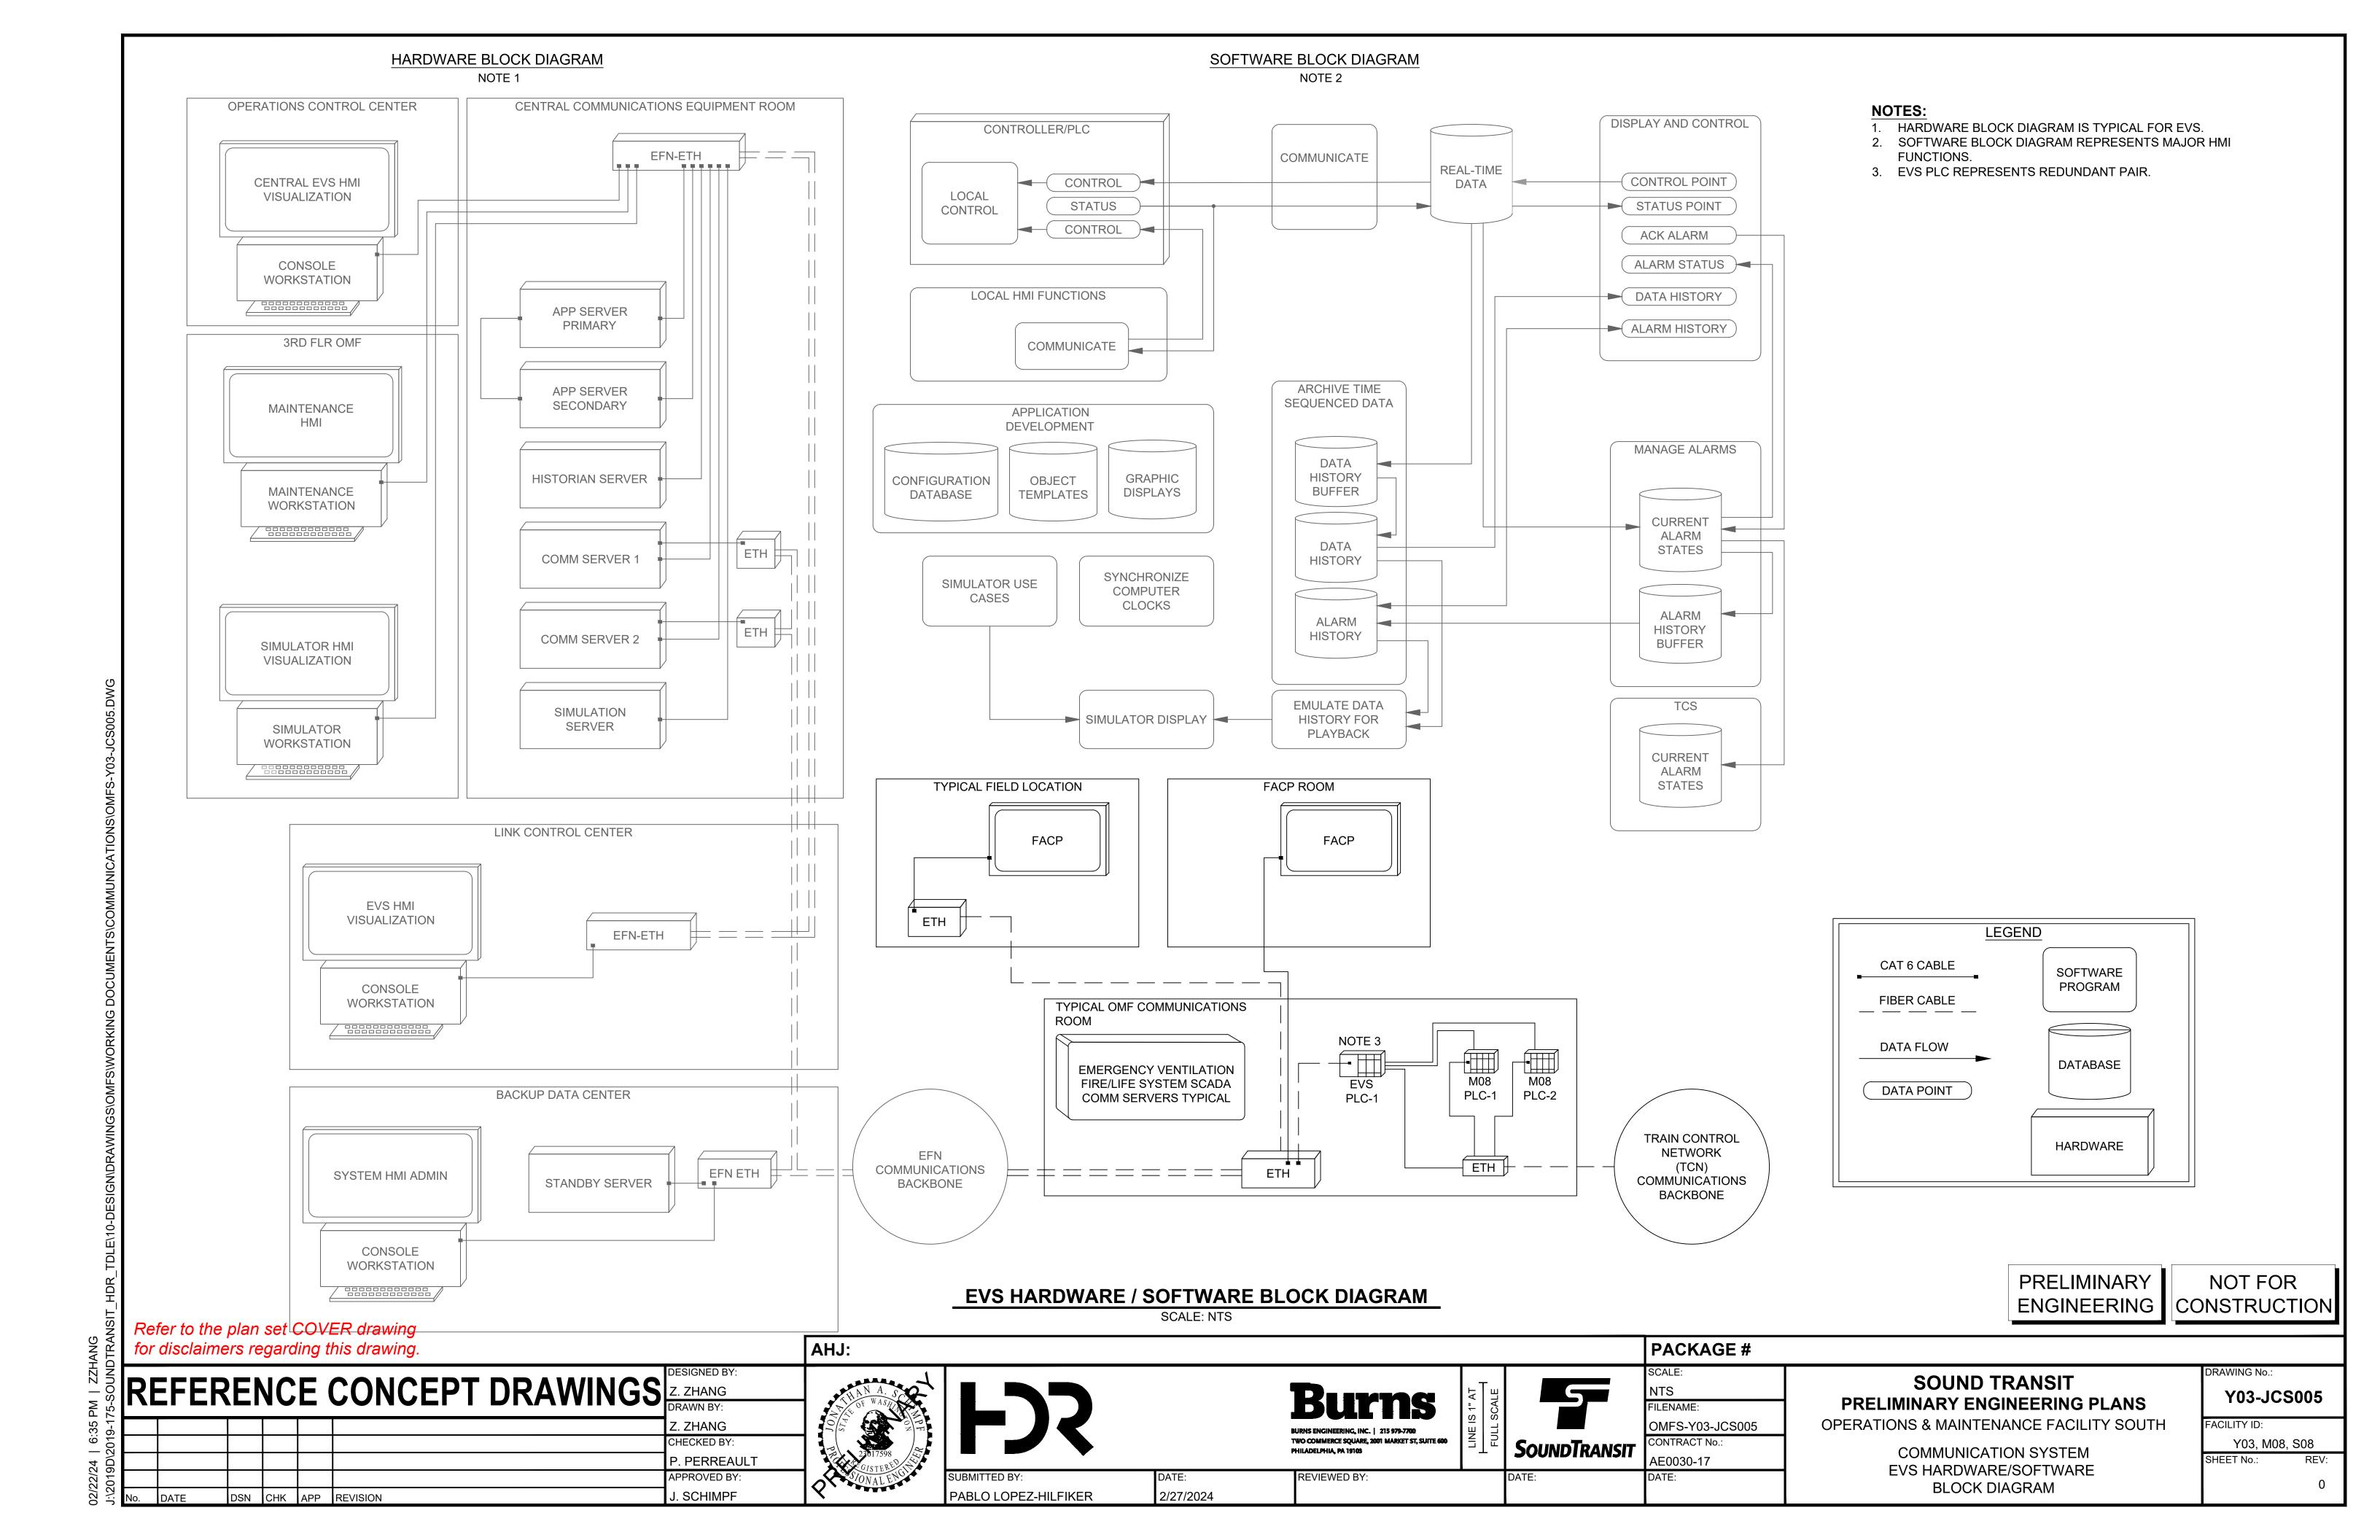

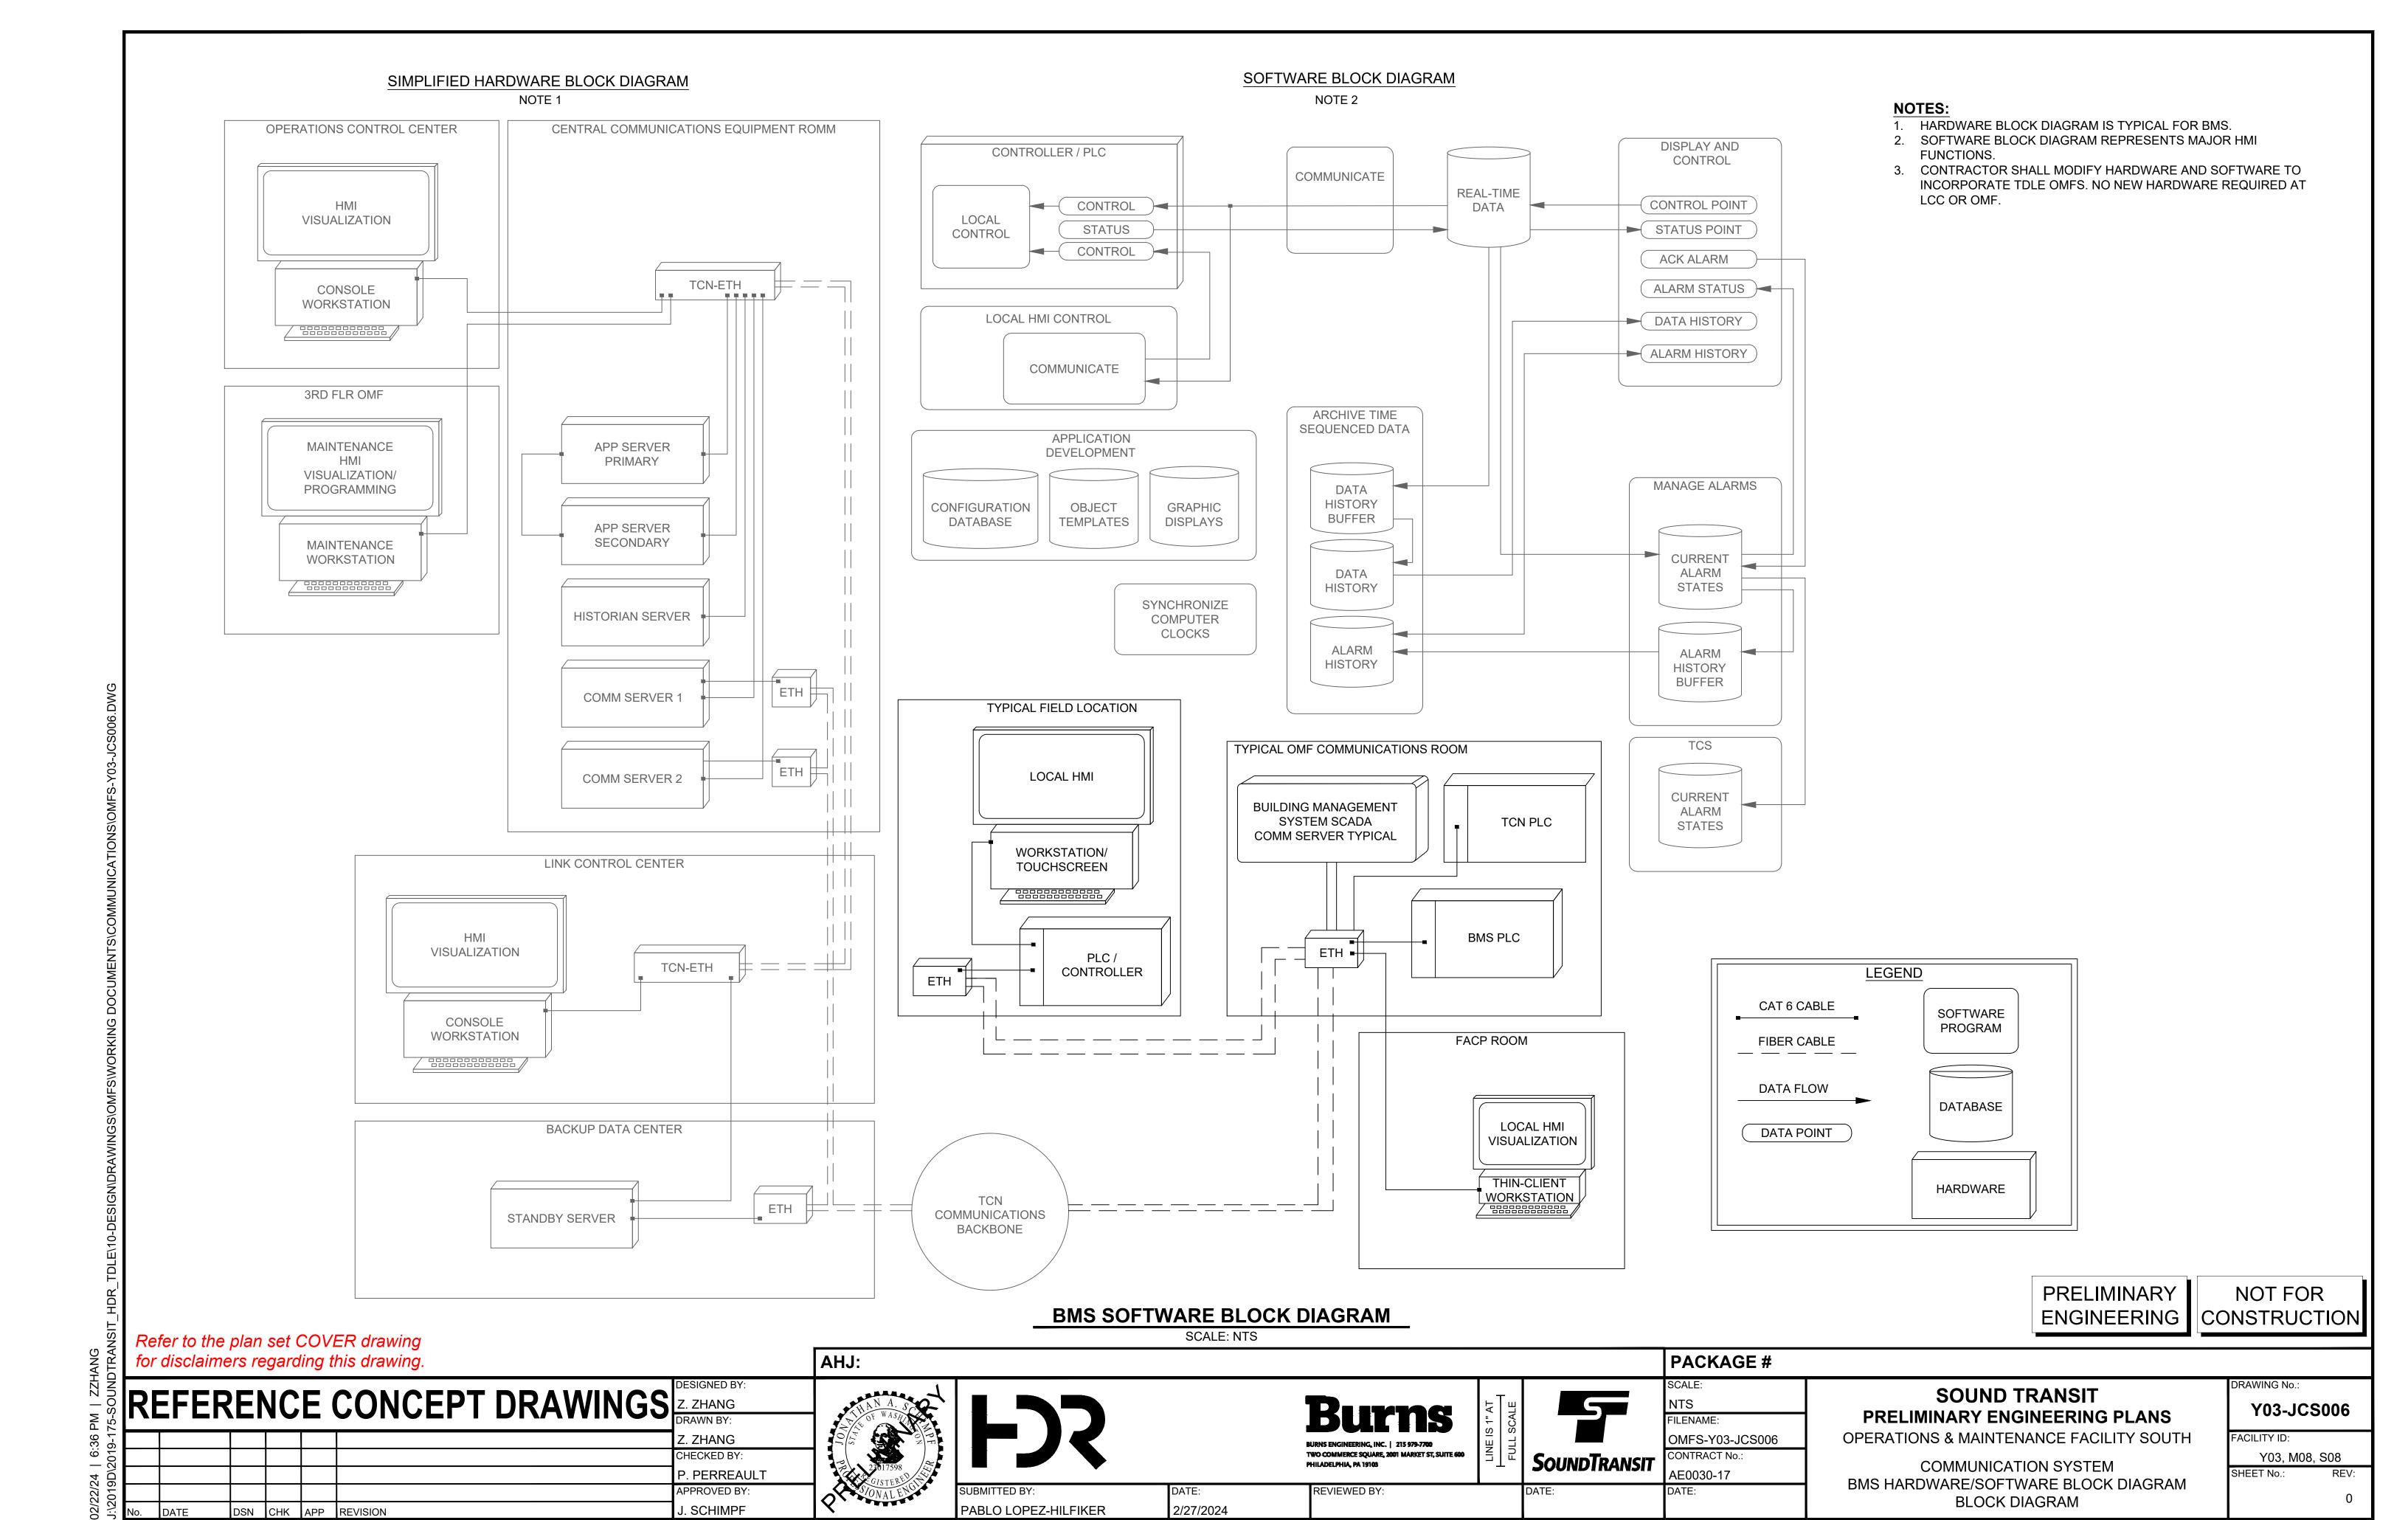

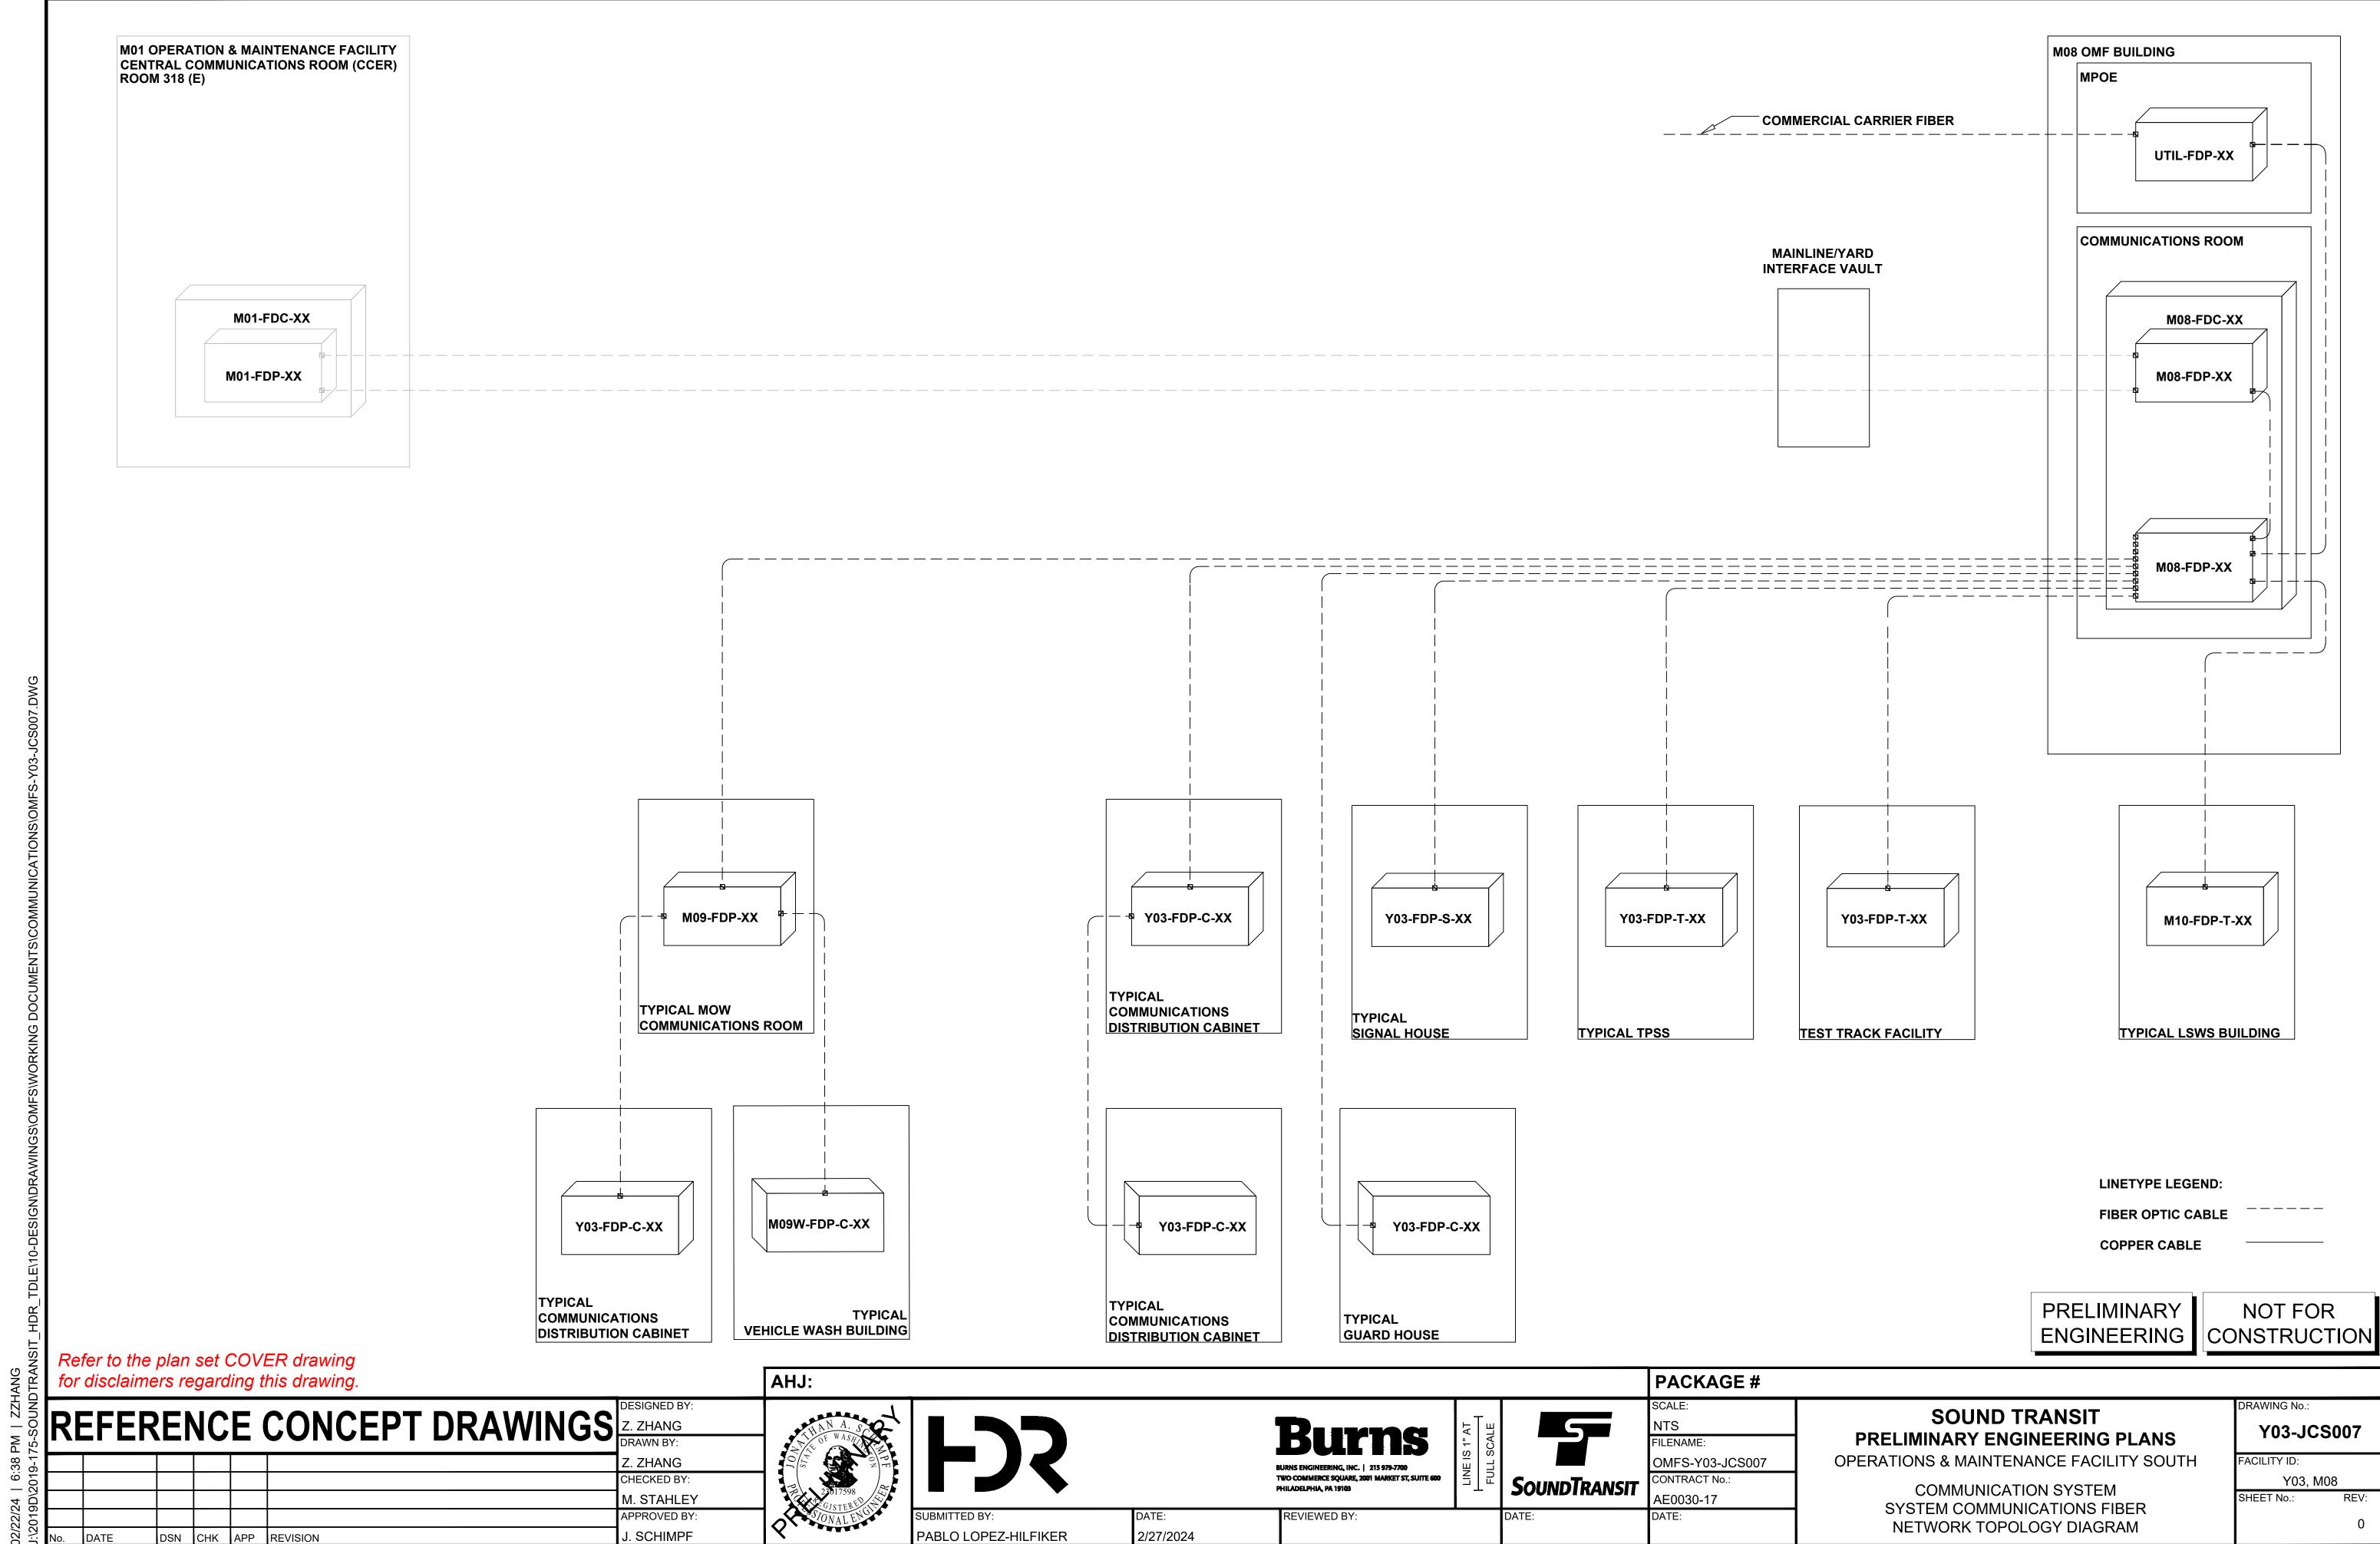

CHK APP REVISION

PABLO LOPEZ-HILFIKER

APPROVED BY


. SCHIMPF

2/27/2024

REVIEWED BY

AE0030-17

TYPICAL CCTV FUNCATIONAL **BLOCK DIAGRAM**

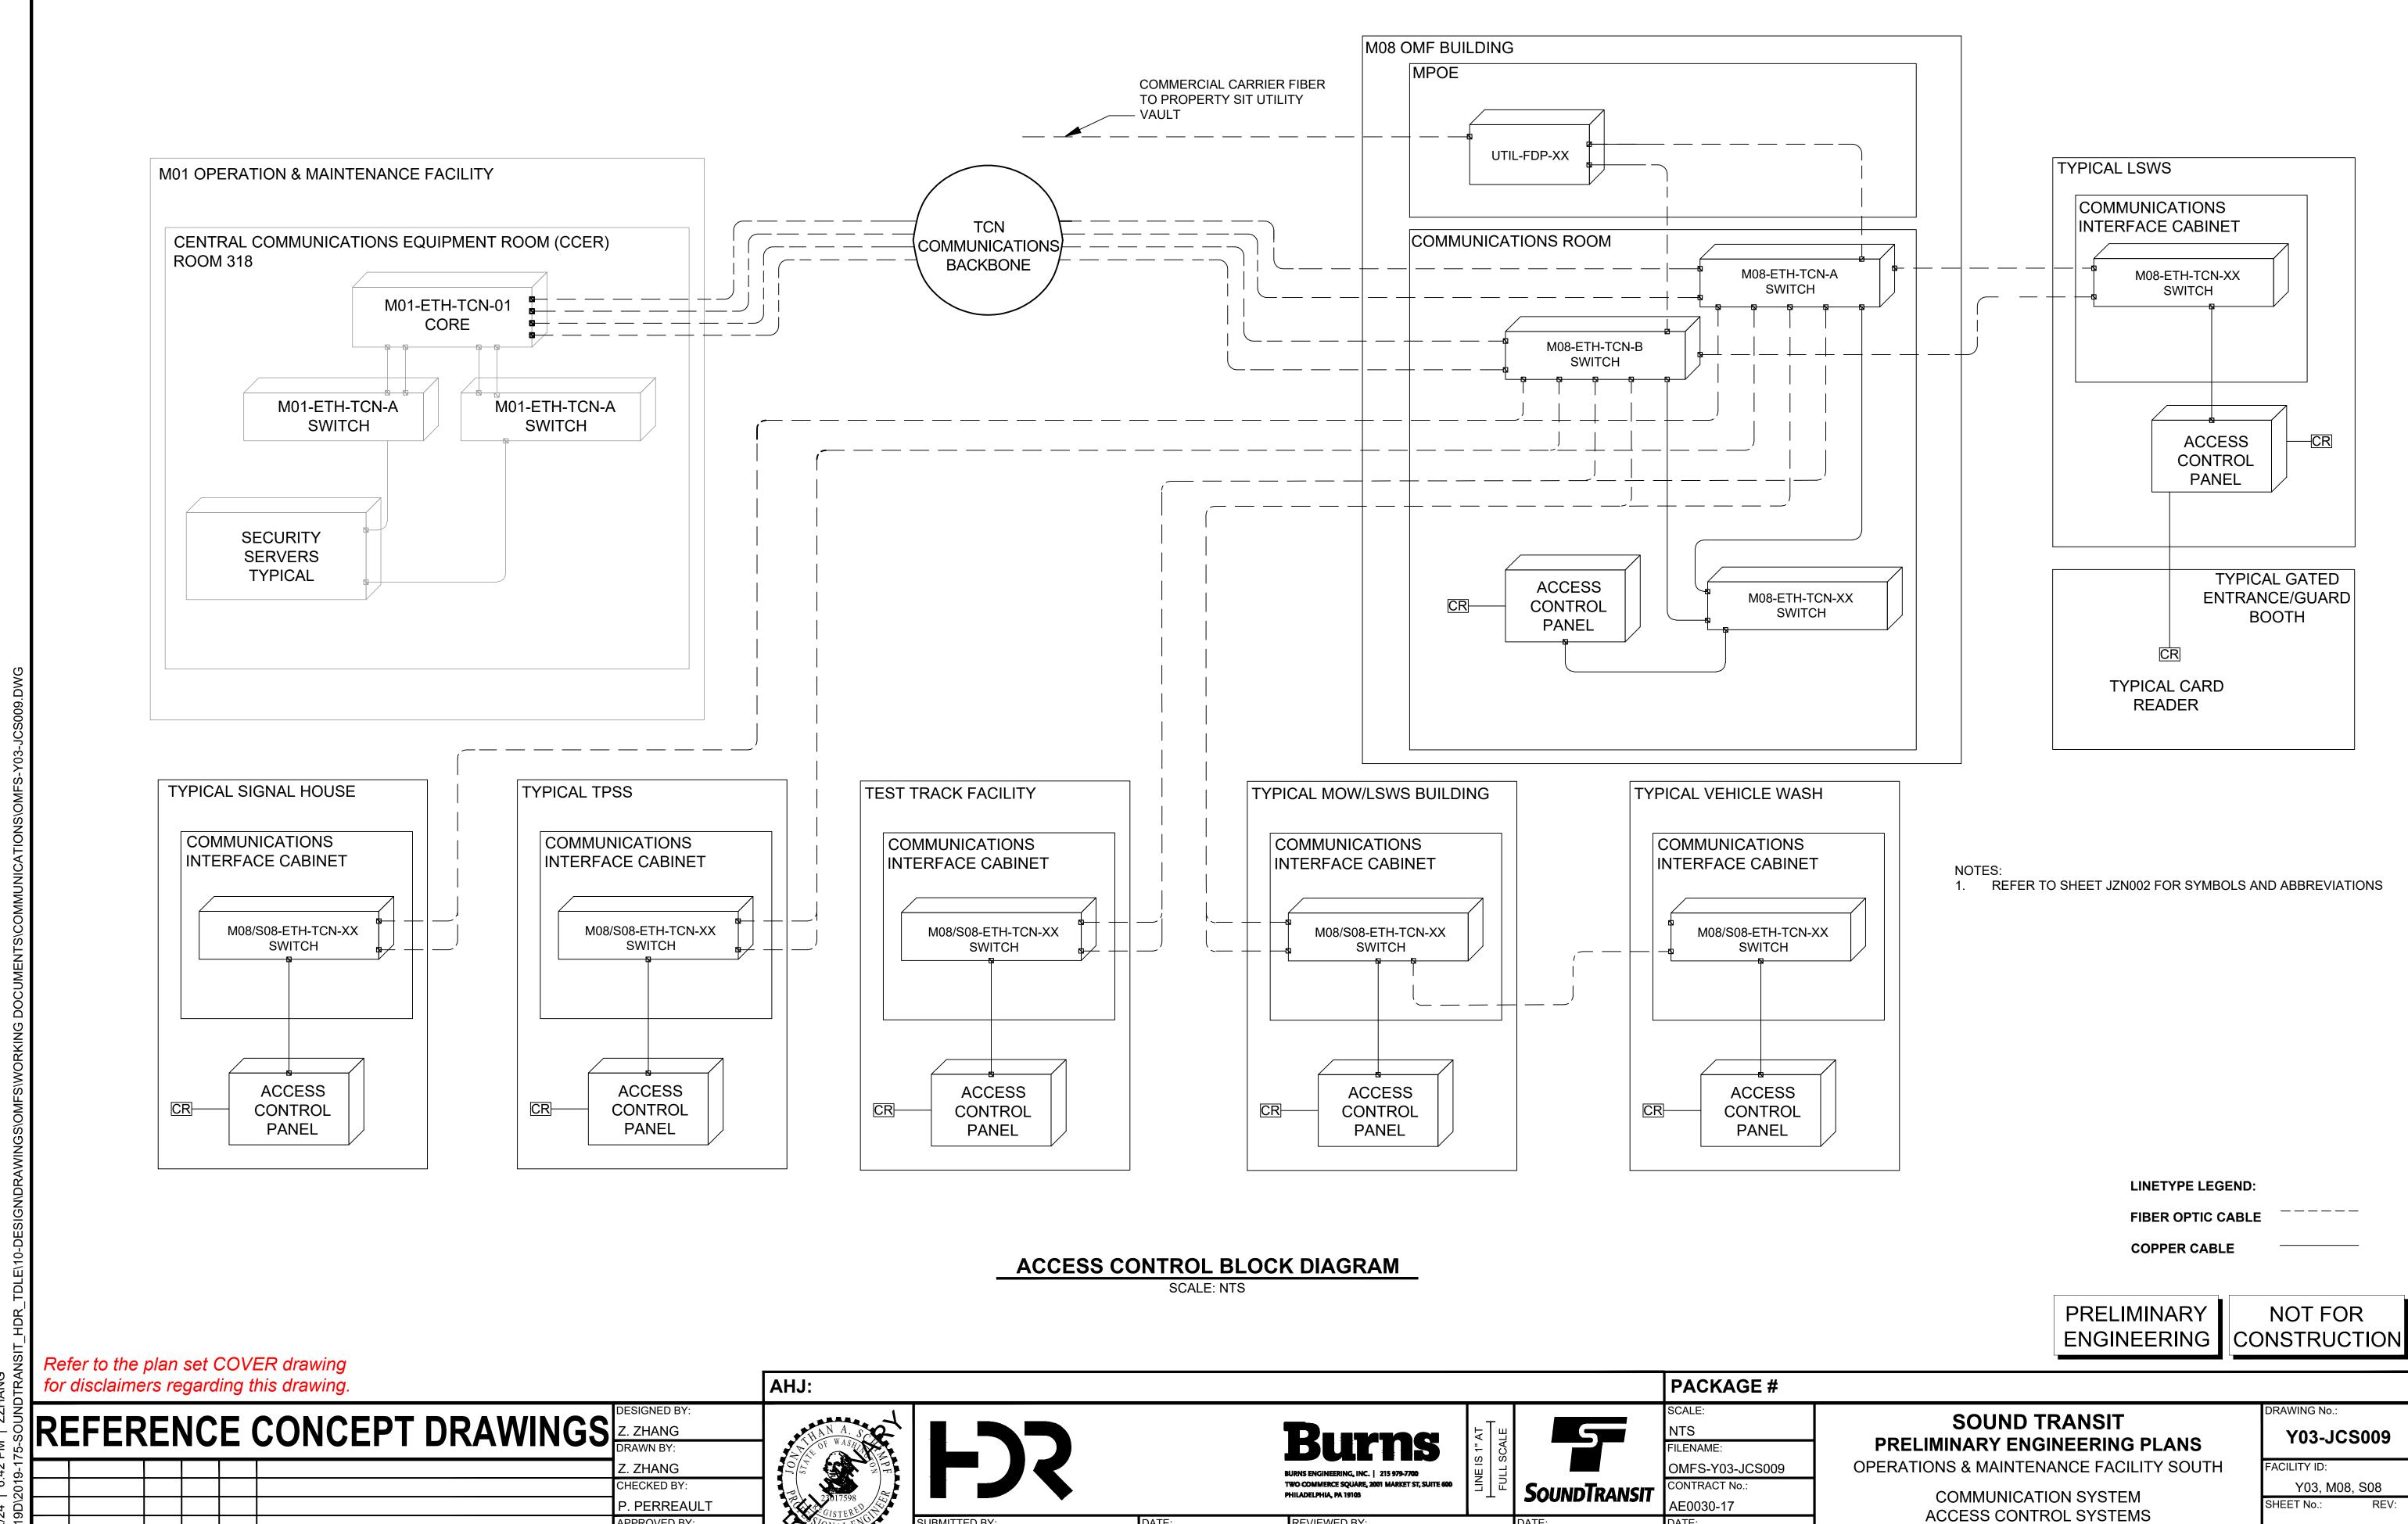

REVIEWED BY:


2/27/2024

PABLO LOPEZ-HILFIKER

CHK APP REVISION

APPROVED BY

J. SCHIMPF

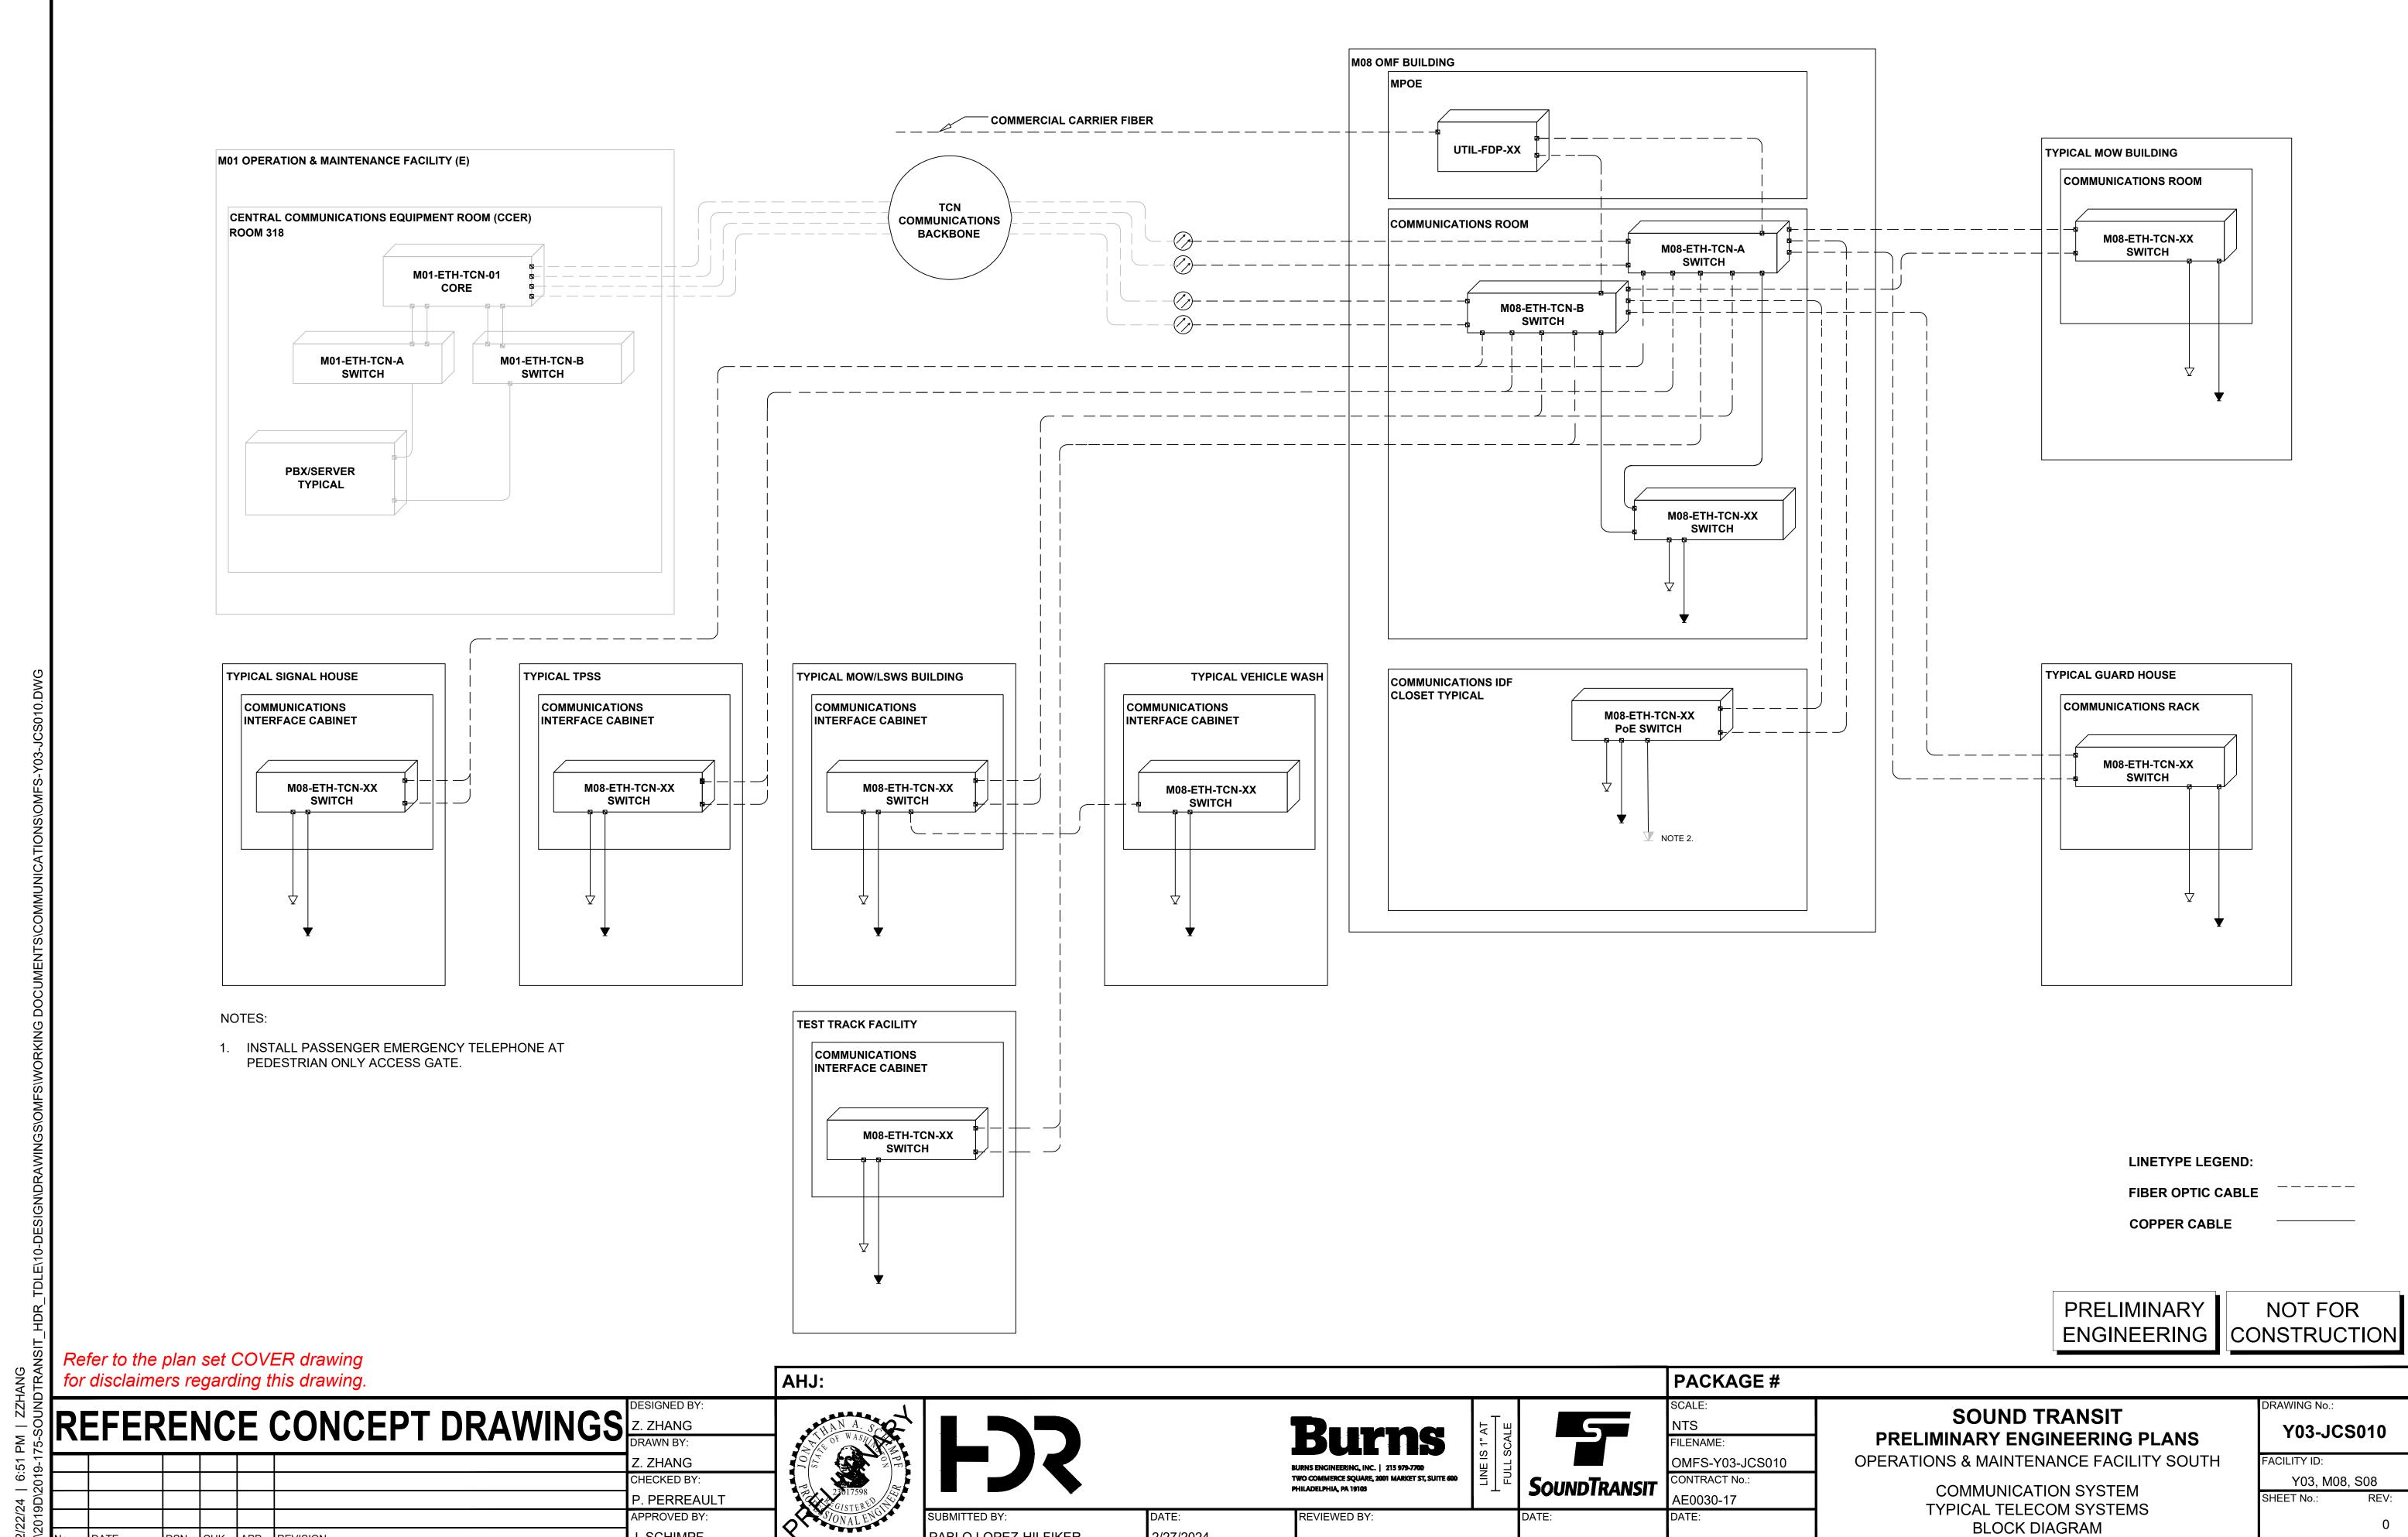


DSN CHK APP REVISION

J. SCHIMPF

PABLO LOPEZ-HILFIKER

2/27/2024

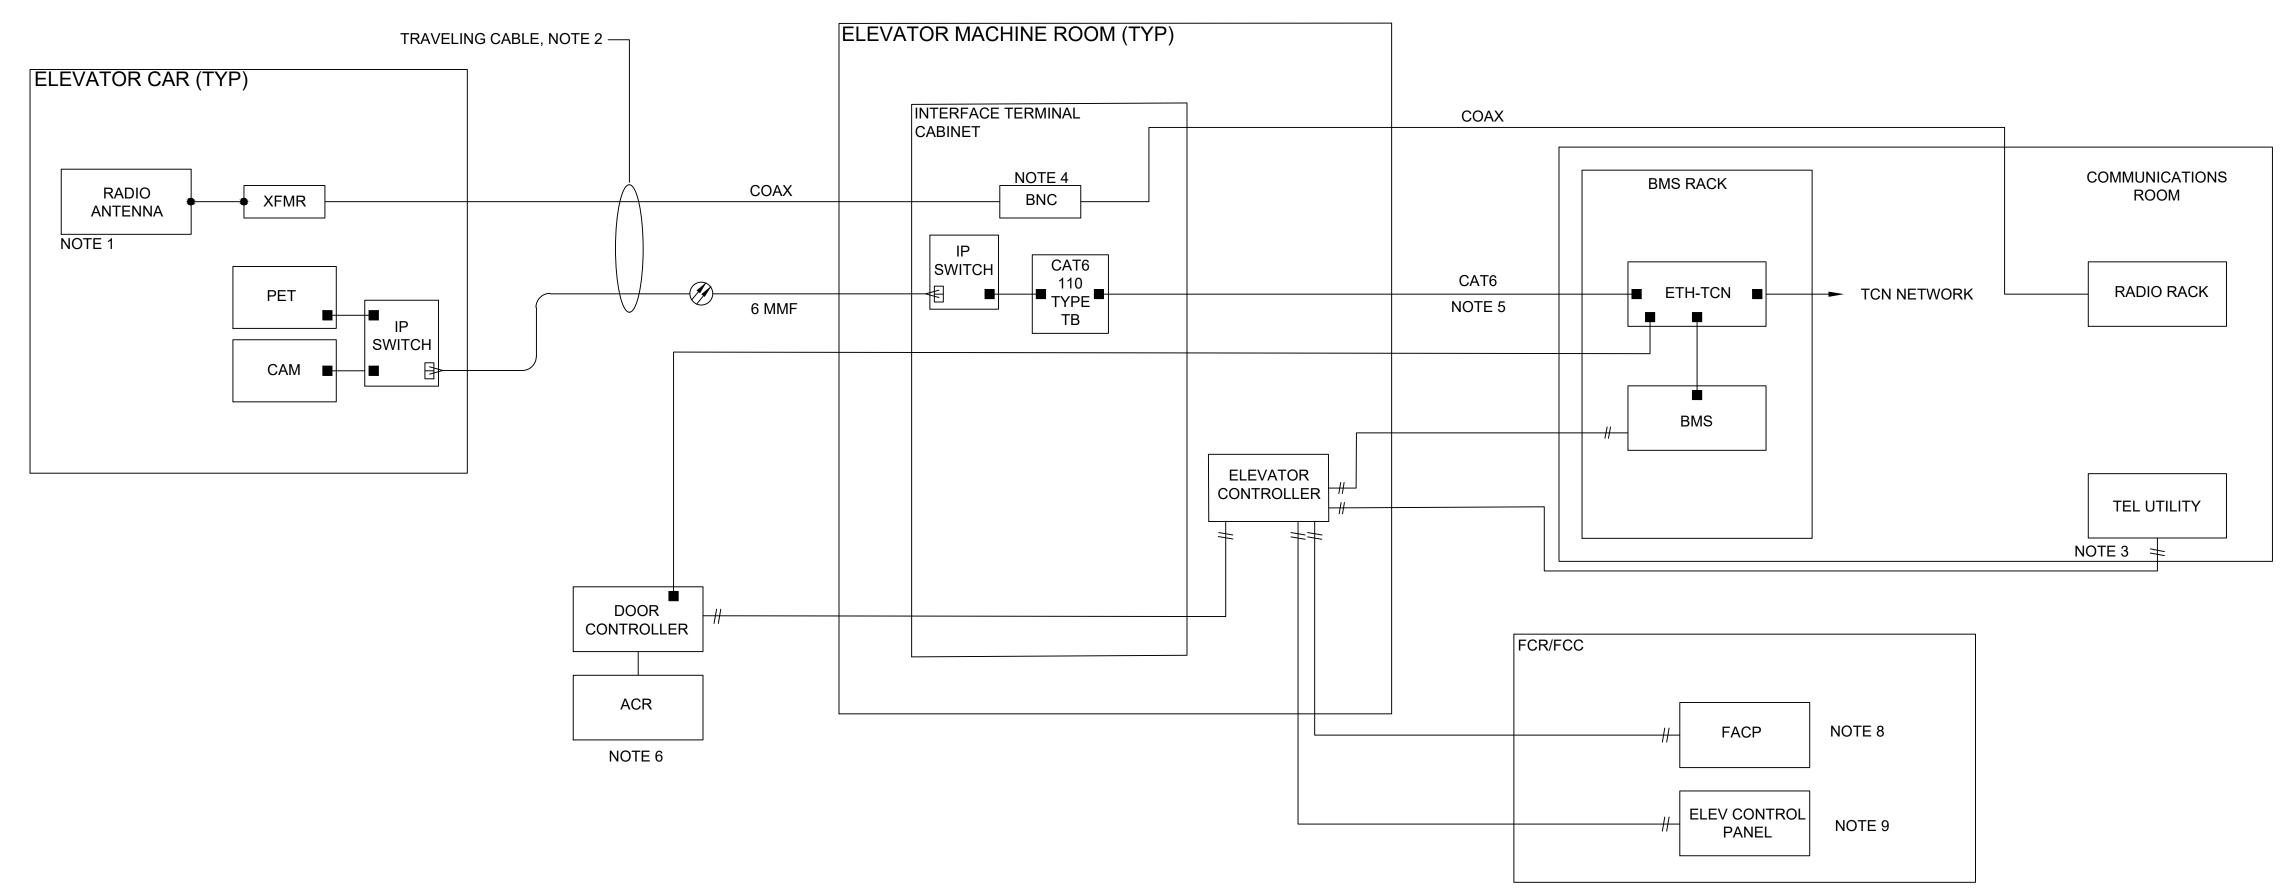

- 1. COORDINATE MOUNTING METHODS FOR ANTENNA WITH CIVIL
- 2. TERMINATE EACH CABLE ON A TERMINATION RATED FOR THE INTENDED USE.
- 3. DESIGN FOR ANY TEMPORARY REQUIREMENTS NEEDED FOR CONSTRUCTION PHASING USING A UTILITY CONNECTION AS NECESSARY. FINAL CONFIGURATION SHALL ALLOW THIRD PARTY MAINTENANCE MONITORING.
- 4. RADIO BNC TERMINATION.
- 5. CAT6 OR FIBER, AS REQUIRED BASED ON DISTANCE, FROM THE COMMUNICATIONS ROOM TO THE ELEVATOR MACHINE ROOM AND PROVIDE TRANSPORT VIA THE TCN TO ALL COMMUNICATION DEVICES SHOWN IN THE ELEVATOR.
- 6. ACCESS CONTROL CARD READER LOCATION(S) TO BE DETERMINED BASED ON STATION CONFIGURATION. ACCESS CONTROL CARD READER LOCATED AT EACH ENTRY TO ELEVATOR. READER SHALL ALLOW ENTRY TO CAB DURING NON-REVENUE HOURS. SHALL ALSO ALLOW FOR ACCESS TO SECURED FLOORS. ELEVATOR SHALL HAVE BMS REMOTE PERMISSION TO ACCESS ELEVATOR CAB AND SECURED
- 7. RECALL FUNCTIONALITY AS REQUIRED BY CODE. TYPICAL RECALL TRIGGER BY HEAT OR SMOKE IN ELEVATOR SHAFT, HEAT IN LOBBY OR SMOKE IN ELEVATOR MACH ROOM.
- AS REQUIRED BY AUTHORITY HAVING JURISDICTION (AHJ).
- 9. COORDINATE WITH ST, AHJ AND ARCHITECTURE TO IDENTIFY ADDITIONAL REQUIREMENTS SUCH AS A FIRE DEPARTMENT RADIO
- 10. REFER TO JZN002 AND JZN004 FOR SYMBOLS AND ABBREVIATIONS.

ELEVATOR INTERFACING BLOCK DIAGRAM

SCALE: NTS

PRELIMINARY ENGINEERING

NOT FOR CONSTRUCTION

RAWING No.:

Refer to the plan set COVER drawing for disclaimers regarding this drawing.

REFERENCE CONCEPT DRAWINGS Z. ZHANG DRAWN BY: CHECKED BY: P. PERREAUL⁻ APPROVED BY

PABLO LOPEZ-HILFIKER

AHJ:

J. SCHIMPF

Burns TWO COMMERCE SQUARE, 2001 MARKET ST, SUITE 600 PHILADELPHIA, PA 19103

2/27/2024

REVIEWED BY:

5 SoundTransit

FILENAME: OMFS-Y03-JCS011 CONTRACT No.: AE0030-17

PACKAGE #

SOUND TRANSIT PRELIMINARY ENGINEERING PLANS **OPERATIONS & MAINTENANCE FACILITY SOUTH**

> COMMUNICATION SYSTEM TYPICAL ELEVATOR INTERFACING **BLOCK DIAGRAM**

Y03-JCS011 FACILITY ID:

Y03, M08

- 1. PROVIDE CAT6 PATCH PANEL, CAT6 PATCH CORD INTERCONNECTION, FIBER DISTRIBUTION PANEL, AND FIBER
- 2. CONNECT TCN EXPANSION TO EXISTING TCN BACKBONE.
- 3. PROVIDE ACCESS SWITCHES SIZED TO ACCOMMODATE IP DEVICES. SWITCH CONFIGURATION PROVIDED BY SOUND TRANSIT IT DEPT.
- 4. FIBER PATCH PANELS NOT SHOWN FOR CLARITY.

TPSS TCS SCADA INTERFACE BLOCK DIAGRAM

SCALE: NTS

PRELIMINARY ENGINEERING

NOT FOR CONSTRUCTION

Refer to the plan set COVER drawing for disclaimers regarding this drawing.

REFERENCE CONCEPT DRAWINGS Z. ZHANG DRAWN BY: CHECKED BY: P. PERREAULT APPROVED BY J. SCHIMPF CHK APP REVISION

OPERATIONS & MAINTENANCE FACILITY

CENTRAL COMMUNICATIONS EQUIPMENT ROOM (CCER)

ROOM 318

PABLO LOPEZ-HILFIKER

AHJ:

Burns TWO COMMERCE SQUARE, 2001 MARKET ST, SUITE 600 PHILADELPHIA, PA 19103

2/27/2024

REVIEWED BY:

5 SoundTransit

FILENAME: OMFS-Y03-JCS012 CONTRACT No.: AE0030-17


PACKAGE #

SOUND TRANSIT PRELIMINARY ENGINEERING PLANS **OPERATIONS & MAINTENANCE FACILITY SOUTH**

COMMUNICATION SYSTEM TYPICAL TPSS TCS SCADA INTERFACE **BLOCK DIAGRAM**

RAWING No.: Y03-JCS012 FACILITY ID:

Y03, S08 SHEET No.:

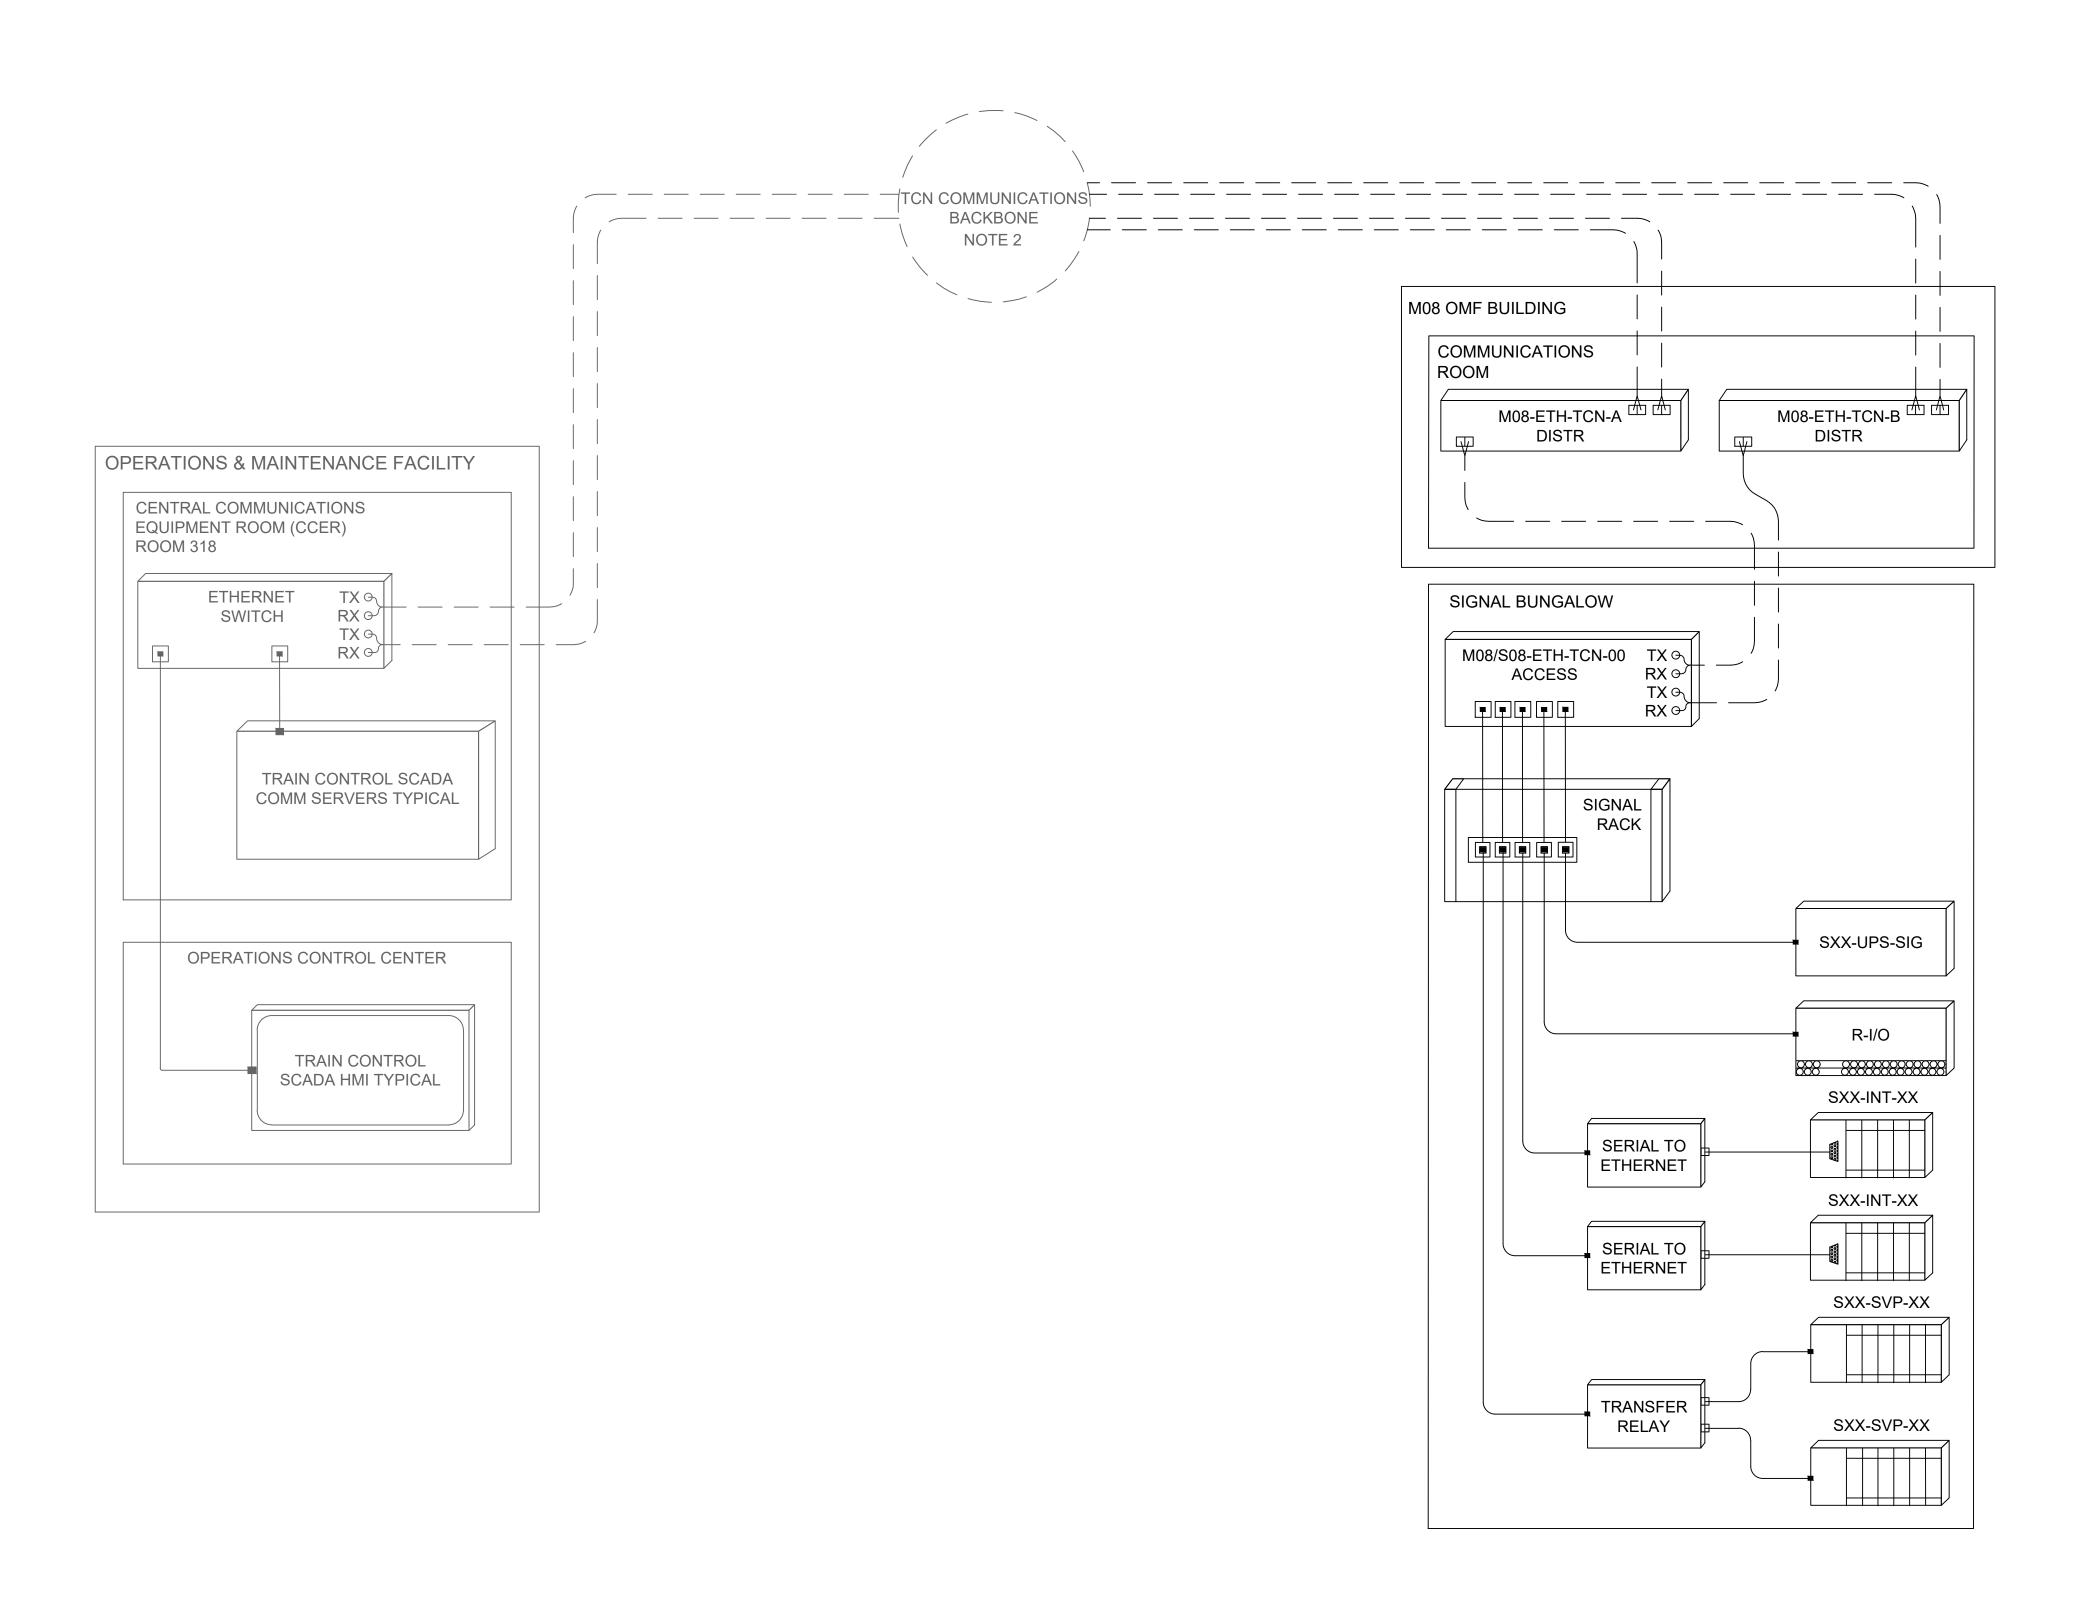

- 1. PROVIDE CAT6 PATCH PANEL, CAT6 PATCH CORD INTERCONNECTION, FIBER PATCH CORDS, AND FIBER PATCH
- 2. CONNECT TCN EXPANSION TO EXISTING TCN COMMUNICATION BACKBONE.
- 3. PROVIDE ACCESS SWITCHES SIZED TO ACCOMMODATE IP DEVICES. SWITCH CONFIGURATION PROVIDED BY SOUND TRANSIT
- 4. FIBER PATCH PANELS NOT SHOWN FOR CLARITY.

SIGNAL TCS SCADA INTERFACE BLOCK DIAGRAM

SCALE: NTS

PRELIMINARY ENGINEERING

NOT FOR CONSTRUCTION

Refer to the plan set COVER drawing for disclaimers regarding this drawing.

REFERENCE CONCEPT DRAWINGS Z. ZHANG DRAWN BY: CHECKED BY: P. PERREAULT APPROVED BY J. SCHIMPF CHK APP REVISION

PABLO LOPEZ-HILFIKER

AHJ:

Burns TWO COMMERCE SQUARE, 2001 MARKET ST, SUITE 600 PHILADELPHIA, PA 19103 **REVIEWED BY:**

2/27/2024

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FILENAME: OMFS-Y03-JCS013 CONTRACT No.: AE0030-17

PACKAGE #

SOUND TRANSIT PRELIMINARY ENGINEERING PLANS **OPERATIONS & MAINTENANCE FACILITY SOUTH**

COMMUNICATION SYSTEM TYPICAL SIGNAL TCS SCADA INTERFACE **BLOCK DIAGRAM**

RAWING No.: Y03-JCS013

FACILITY ID:

Y03, S08 SHEET No.:

- 1. FOR ALL COPPER BASED IP CONNECTIONS THE CONTRACTOR SHALL DESIGN THE CONDUIT RUNS SO NO CABLING PULLS FROM A DESTINATION TO A SOURCE WILL BE MORE THAN 250 FEET.
- 2. POW-C INDICATES POWER WILL TERMINATE ON A POWER PANEL ON THE COMMUNICATION UPS PANEL. ALL OTHER DEVICES ARE ON THE STATION POWER. RUN POWER CONDUIT TO THE APPLICABLE SOURCE.

DESTINATION

EMERGENCY TELEPHONE

PASSENGER EMERGENCY TELEPHONE

PBX TELEPHONE

RJ-45 DATA OUTLET

VARIABLE MESSAGE SIGN W/TWO CAMERAS

CAMERAS (NOT IN VARIABLE MESSAGE SIGN)

BMS INTERFACE TERMINAL CABINET

PUBLIC ADDRESS SPEAKER CIRCUITS

AMBIENT NOISE SENSING MICROPHONE

ACCESS CONTROL CARD DOOR CONTROLLER

GUIDEWAY INTRUSION DETECTION MONITOR

SECURITY GATE CONTROLS

TRIP PLANNERS

BICYCLE SHELTER CARD READER

BICYCLE LOCKER CARD READER

COMMUNICATION DISTRIBUTION CABINET

PARKING MANAGEMENT

RADIO ANTENNA/ DISTRIBUTION J-BOX

GUIDEWAY INTRUSION DETECTION MONITOR

SMART CARD READER

RACEWAY SIZE

POWER

NONE

NONE

NONE

NONE

1.5"

NONE

NONE

NONE

NONE

NONE

NONE

NONE

3"

1"

1"

DATA

1"

1"

1"

AS REQD

1"

1"


1"

1"

3"

4"


3/4"

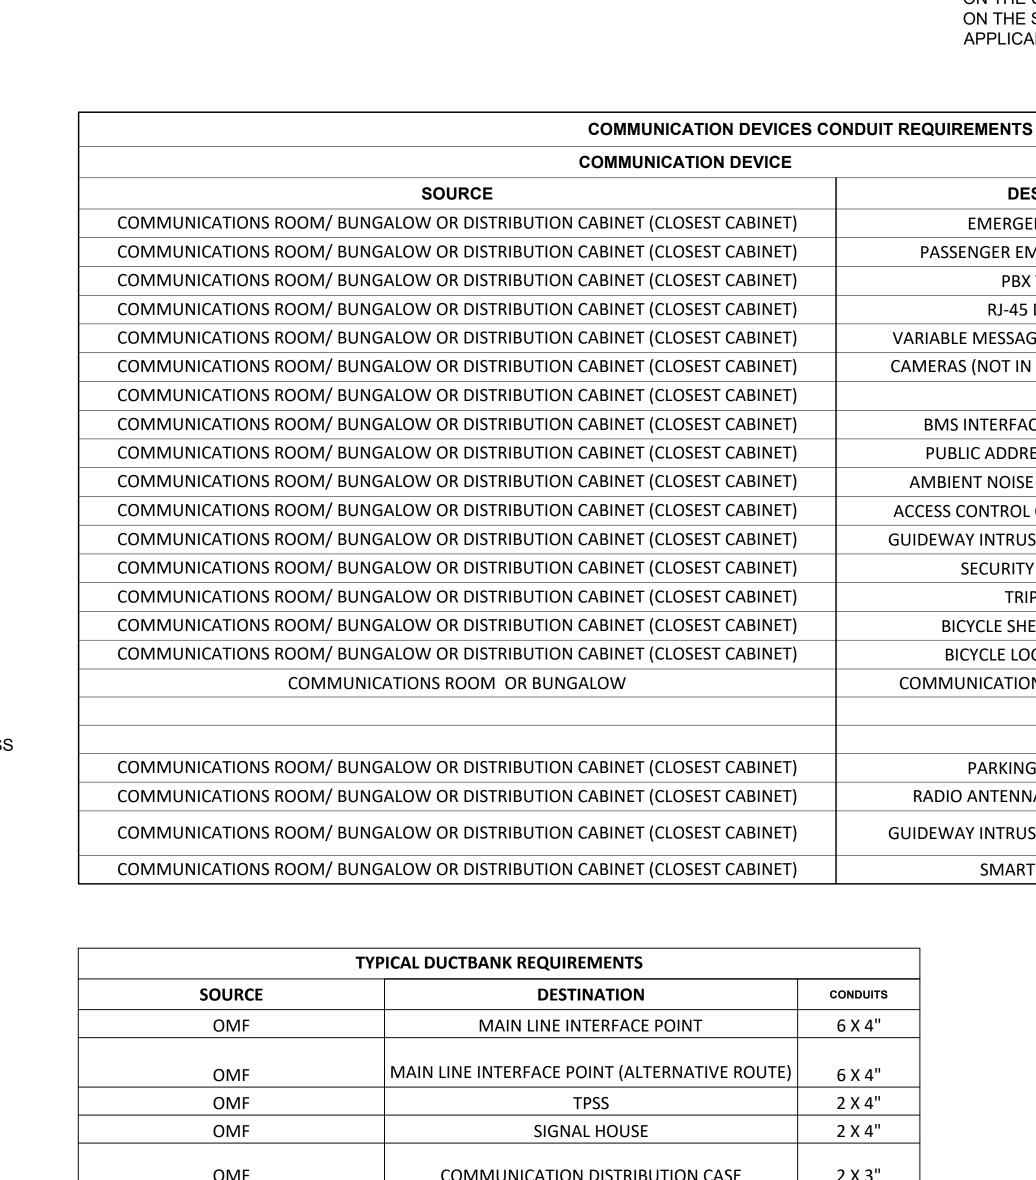

TYPICAL DUCTBANK REQUIREMENTS						
SOURCE	DESTINATION	CONDUITS				
OMF	MAIN LINE INTERFACE POINT	6 X 4"				
OMF	MAIN LINE INTERFACE POINT (ALTERNATIVE ROUTE)	6 X 4"				
OMF	TPSS	2 X 4"				
OMF	SIGNAL HOUSE	2 X 4"				
OMF	COMMUNICATION DISTRIBUTION CASE	2 X 3"				
OMF	GUARD HOUSE	2 X 4"				
OMF	UTILITY VAULT	2 X 4"				
OMF	MOW BUILDING	4 X 4"				
OMF	LSWS	2 X 4"				
OMF	LRV WASH BUILDING	2 X 4"				
OMF	UTILITY VAULT (SERVICE PROVIDER)	2 X 4"				
MOW	COMMUNICATION DISTRIBUTION CASE	2 X 4"				
TPSS	TPSS	2 X 4"				
TPSS	MAINLINE INTERFACE POINT	2 X 4"				
SIGNAL HOUSE	SIGNAL HOUSE	2 X 4"				
SIGNAL HOUSE	MAINLINE INTERFACE POINT	2 X 4"				

PRELIMINARY ENGINEERING

NOT FOR CONSTRUCTION

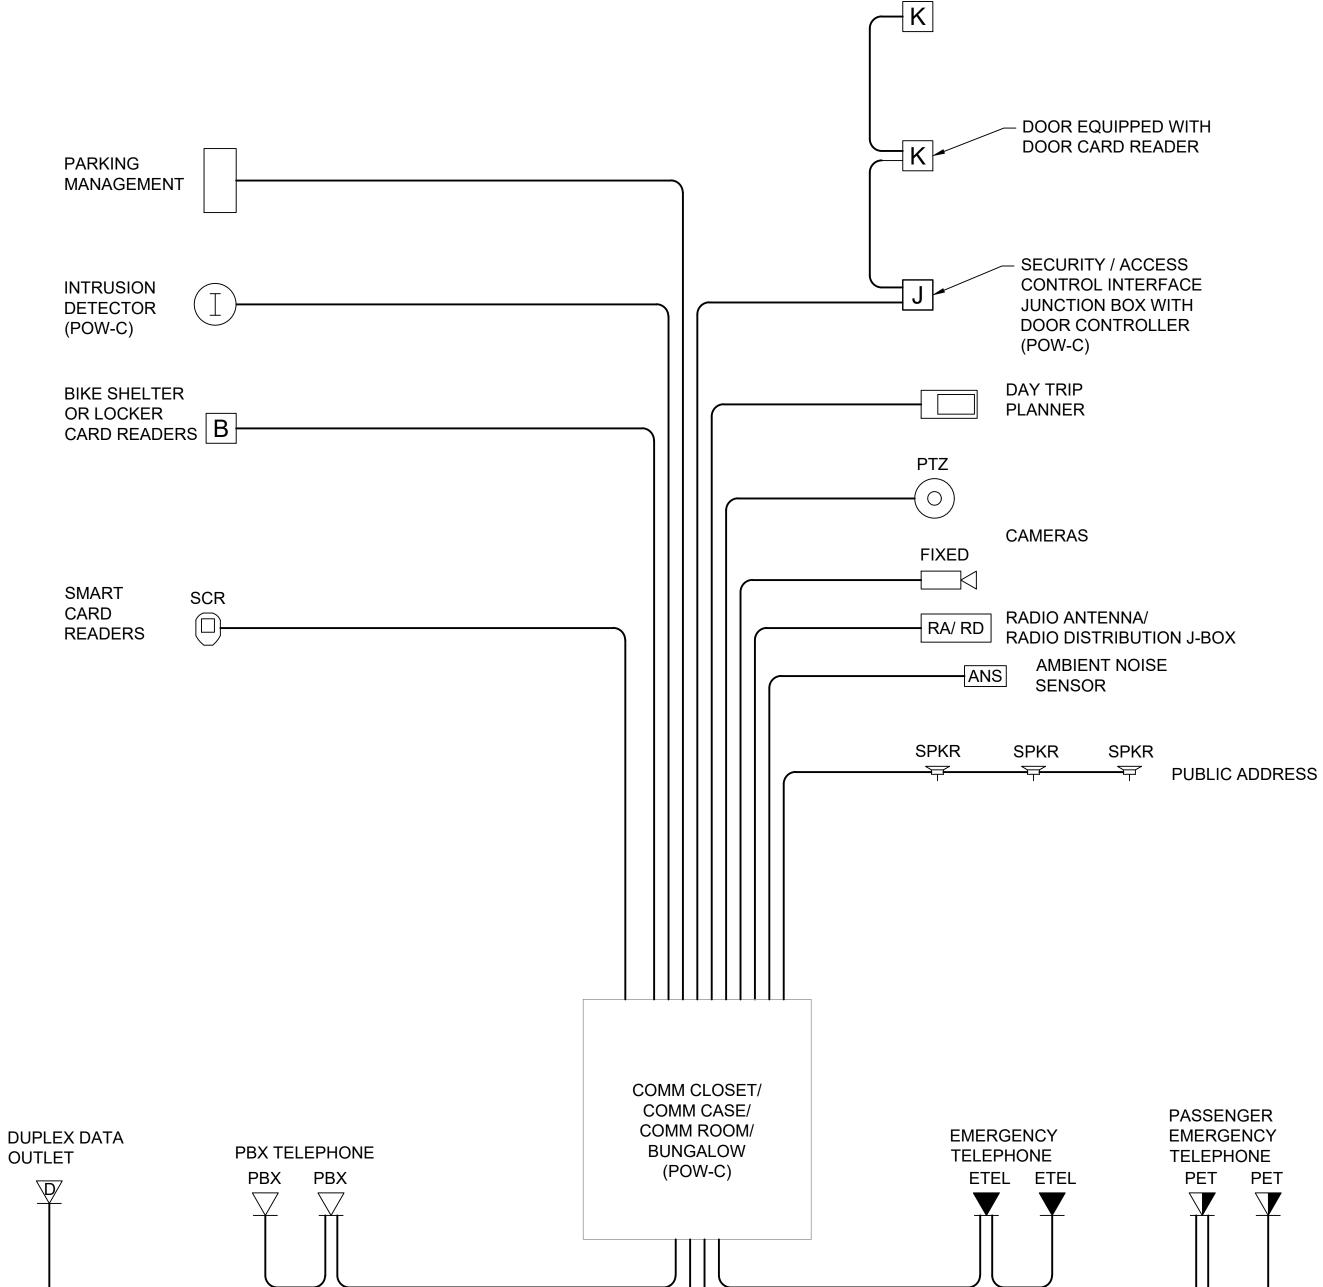

TYPICAL COMMUNICATIONS CONDUIT ROUTING

I. SCHIMPF

SCALE: NTS

AHJ:

	Refer to the plan set COVER drawing for disclaimers regarding this drawing.								
RE	FER	DESIGNED BY: Z. ZHANG DRAWN BY:							
						Z. ZHANG			
						CHECKED BY:			
						M. STAHLEY			
						APPROVED BY:			

DSN CHK APP REVISION

PABLO LOPEZ-HILFIKER

Burns TWO COMMERCE SQUARE, 2001 MARKET ST, SUITE 600 PHILADELPHIA, PA 19103

REVIEWED BY:

2/27/2024

SoundTransit

5 AE-0030-17

ILENAME: OMFS-Y03-JCD001 CONTRACT No.:

PACKAGE #

SOUND TRANSIT PRELIMINARY ENGINEERING PLANS **OPERATIONS & MAINTENANCE FACILITY SOUTH**

> COMMUNICATION SYSTEM TYPICAL COMMUNICATION DEVICES CONDUIT REQUIREMENTS

RAWING No.: Y03-JCD001 FACILITY ID:

Y03, M08, S08 SHEET No.

FIXED/PTZ CAMERA DOME PENDANT - POLE MOUNTED

SCALE: NTS

1. FOR IP VIDEO TRANSMISSION FROM DESIGNATED CAMERAS USE "WET LOCATIONS" RATED CAT6 SHIELDED CABLE SUITABLE FOR ETHERNET APPLICATIONS. SUCH AS BELDEN 1583A OR 7883A

FIXED/PTZ OUTDOOR CEILING PENDANT DOME

INSTALL CABLES IN

CONDUIT

SCALE: NTS

ALL CABLES TO BE INSTALLED FROM MOUNT IN FLEXIBLE CONDUIT TO 4X4 JUNCTION BOX. MOUNT JUNCTION BOX TO PARAPET NEAR CAMERA. CABLES SHALL CONTINUE UNBROKEN IN RIGID CONDUIT. IP TRANSMISSION, (A) TO CLOSEST OR IDENTIFIED VIDEO SURVEILLANCE EQUIPMENT RACK/CDC

J. SCHIMPF

FIXED/PTZ OUTDOOR PARAPET PENDANT DOME

ALL CABLES TO BE INSTALLED FROM MOUNT IN FLEXIBLE CONDUIT TO 4X4 JUNCTION BOX. MOUNT JUNCTION BOX TO PARAPET NEAR CAMERA. CABLES SHALL CONTINUE UNBROKEN IN RIGID CONDUIT

IP TRANSMISSION, (A) TO CLOSEST OR IDENTIFIED VIDEO SURVEILLANCE EQUIPMENT RACK/CDC

IP TRANSMISSION, (A) TO CLOSEST OR IDENTIFIED VIDEO SURVEILLANCE EQUIPMENT RACK/CDC

FIXED/PTZ OUTDOOR ROOF PENDANT DOME SCALE: NTS

Refer to the plan set COVER drawing for disclaimers regarding this drawing.

DSN CHK APP REVISION

REFERENCE CONCEPT DRAWINGS Z. ZHANG DRAWN BY: CHECKED BY: M. STAHLEY APPROVED BY

AHJ:

PABLO LOPEZ-HILFIKER

Burns TWO COMMERCE SQUARE, 2001 MARKET ST, SUITE 600 PHILADELPHIA, PA 19103 REVIEWED BY:

<u>_</u>5_

PACKAGE # FILENAME: OMFS-Y03-JCD002 CONTRACT No.: AE0030-17

SOUND TRANSIT PRELIMINARY ENGINEERING PLANS **OPERATIONS & MAINTENANCE FACILITY SOUTH**

COMMUNICATION SYSTEM

RAWING No.: Y03-JCD002

FACILITY ID:

NOT FOR

ENGINEERING | CONSTRUCTION

PRELIMINARY


2/27/2024


SOUNDTRANSIT


YARD CCTV SYSTEM DETAILS

Y03 SHEET No.:


FRONT VIEW

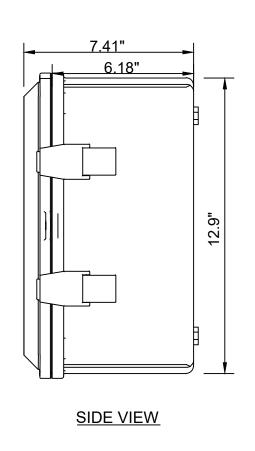


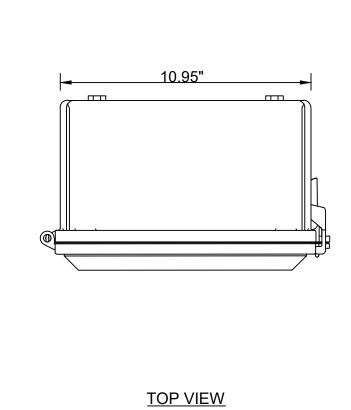

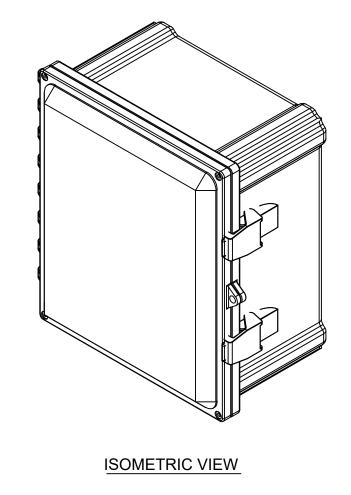

1. DIMENSIONS ARE EXTERNAL DIMENSIONS. USABLE INTERNAL DIMENSIONS ARE 12" X 10" X 6".

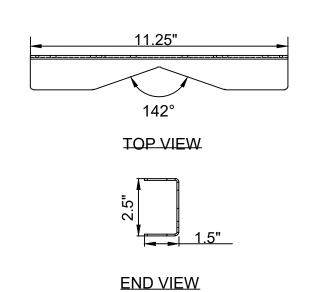

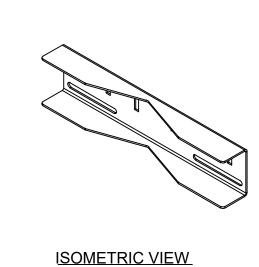

POLE/WALL MOUNTED WAP ENCLOSURE SCALE: 1/4" = 1"


-CEILING

WAP ENCLOSURE - WALL MOUNT DETAIL SCALE: NTS

AHJ:

WAP ENCLOSURE POLE MOUNT ADAPTER

SCALE:1/4" = 1"

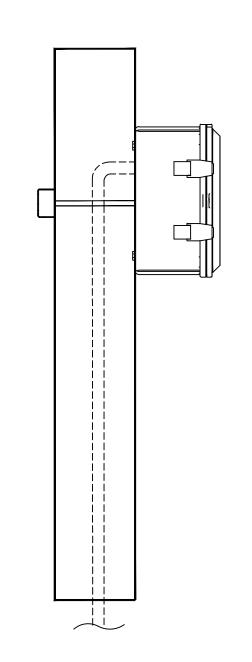

WALP ENCLOSURE - POLE MOUNT DETAIL

PRELIMINARY

NOT FOR ENGINEERING CONSTRUCTION

RAWING No.:

Refer to the plan set COVER drawing for disclaimers regarding this drawing.

REFERENCE CONCEPT DRAWINGS Z. ZHANG DRAWN BY: CHECKED BY: M. STAHLEY APPROVED BY J. SCHIMPF DSN CHK APP REVISION

PABLO LOPEZ-HILFIKER

Burns TWO COMMERCE SQUARE, 2001 MARKET ST, SUITE 600 PHILADELPHIA, PA 19103

REVIEWED BY:

2/27/2024

5 SoundTransit


PACKAGE # FILENAME: OMFS-Y03-JCD003 CONTRACT No.: AE0030-17


SOUND TRANSIT PRELIMINARY ENGINEERING PLANS **OPERATIONS & MAINTENANCE FACILITY SOUTH**

> COMMUNICATION SYSTEM WIRELESS ACCESS POINT **DETAILS**

Y03-JCD003 FACILITY ID: Y03

SHEET No.:

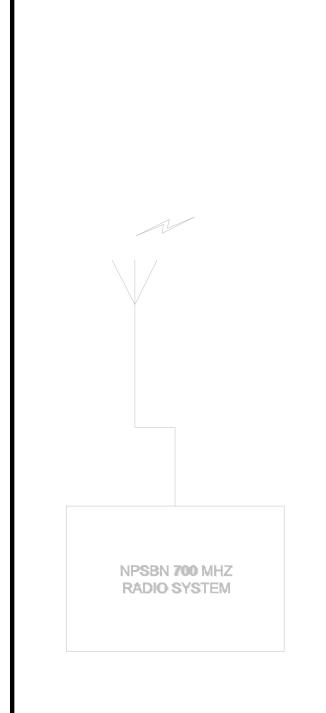

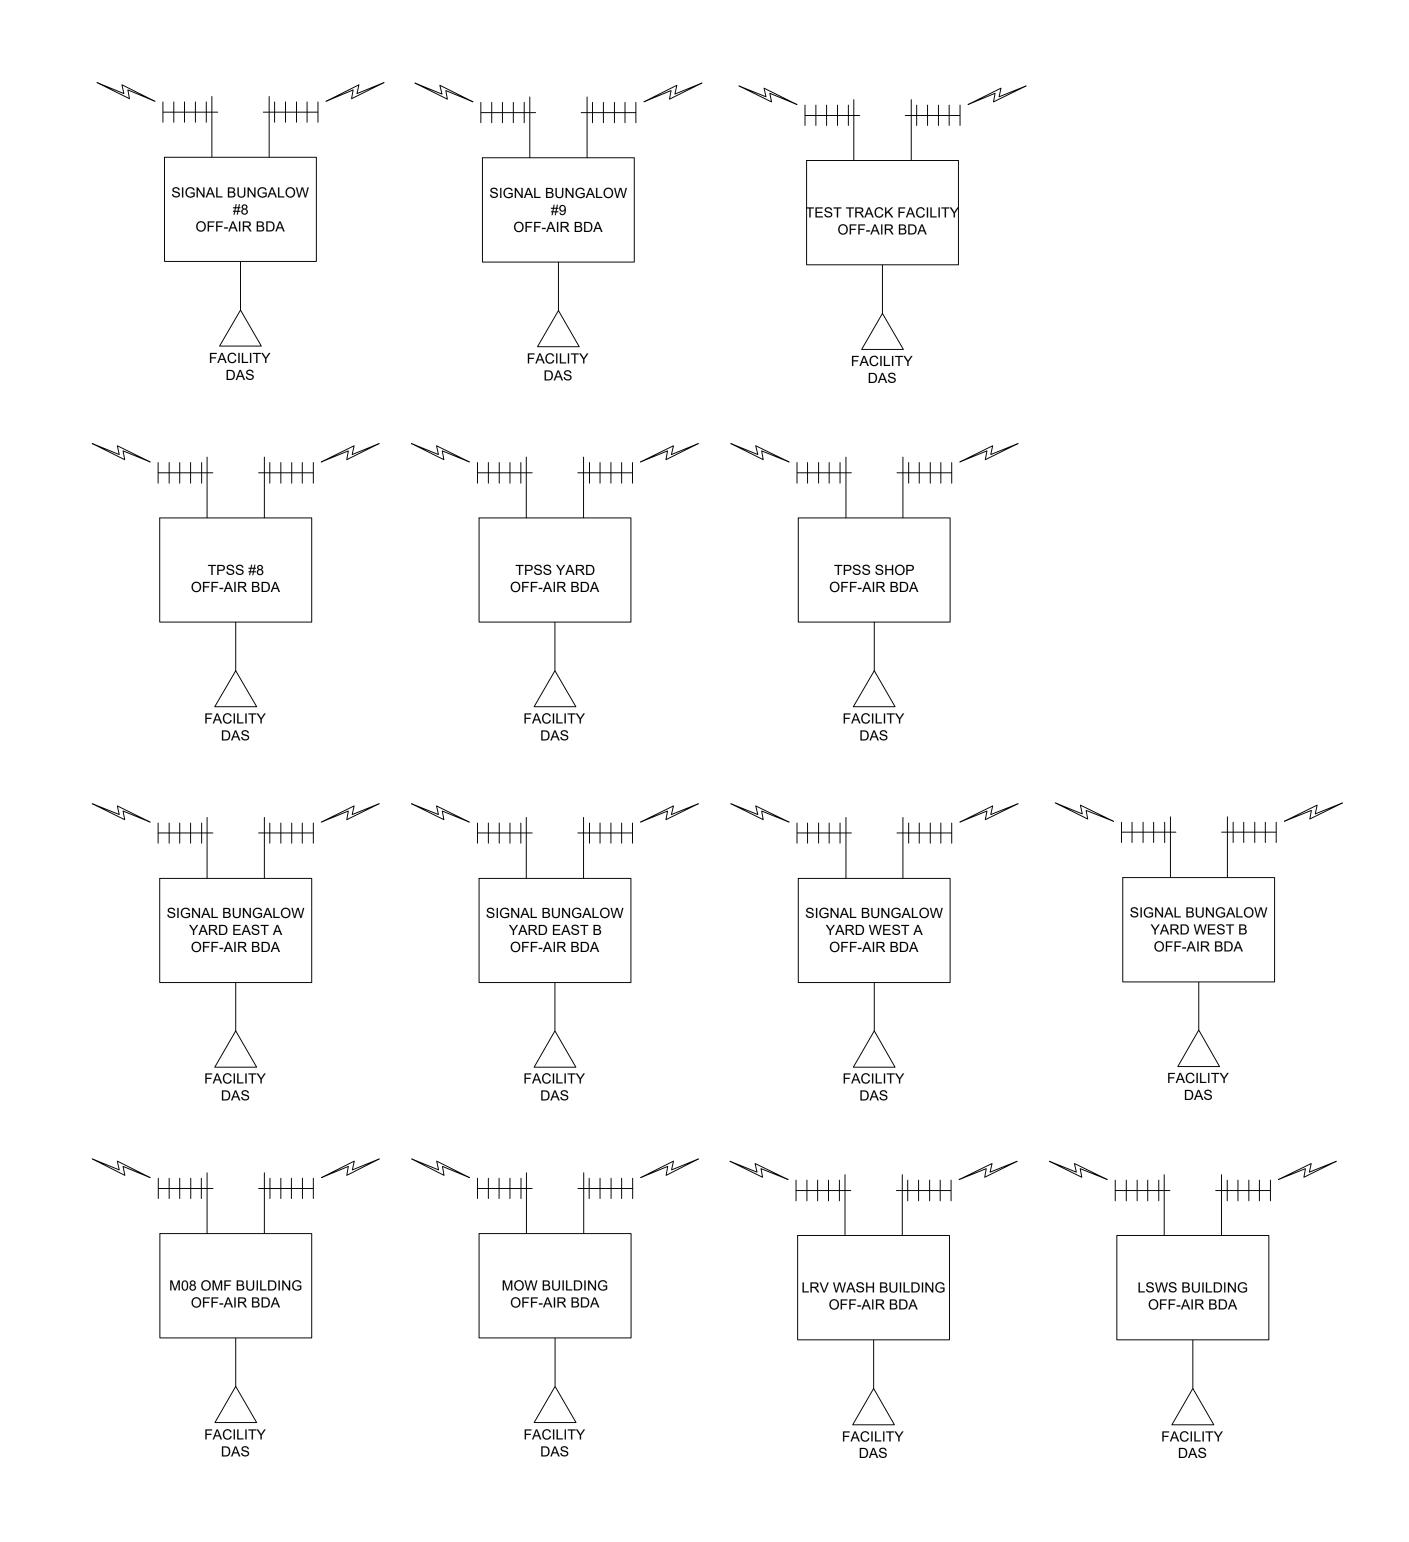

1. DAS - DISTRIBUTED ANTENNA SYSTEM

2. BDA - BI-DIRECTIONAL AMPLIFIER

3. KCVC - KING COUNTY VALLEY COMMUNICATIONS

4. NPSBN - NATIONWIDE PUBLIC SAFETY BROADBAND NETWORK

KCVC 800 MHZ RADIO SYSTEM

PRELIMINARY ENGINEERING

NOT FOR CONSTRUCTION

Refer to the plan set COVER drawing for disclaimers regarding this drawing.

REFERENCE CONCEPT DRAWINGS Z. ZHANG DRAWN BY: CHECKED BY: P. PERREAUL APPROVED BY J. SCHIMPF CHK APP REVISION

PABLO LOPEZ-HILFIKER

AHJ:

Burns TWO COMMERCE SQUARE, 2001 MARKET ST, SUITE 600 PHILADELPHIA, PA 19103

REVIEWED BY:

2/27/2024

5-SoundTransit

AE0030-17

PACKAGE # FILENAME: OMFS-Y03-JRS001 CONTRACT No.:

SOUND TRANSIT PRELIMINARY ENGINEERING PLANS **OPERATIONS & MAINTENANCE FACILITY SOUTH**


COMMUNICATION SYSTEM HIGH LEVEL RADIO SYSTEM RAWING No.: Y03-JRS001

FACILITY ID:

BLOCK DIAGRAM

Y03, M08, S08

- 1. INTERFACE DRAWINGS SHOW PHYSICAL EQUIPMENT AS TYPICALLY INTERFACED WITH THE BMS. THESE DRAWINGS PROVIDE A BASIS FOR THE CONTRACTOR'S DETAILED DESIGN AND INTEGRATION OF THE BMS WITH SYSTEMS AND EQUIPMENT. INTERFACE POINTS SHALL BE ADDED, SUBTRACTED AND INTERACTIONS MODIFIED IN ORDER TO PROVIDE THE REQUIRED END RESULT FUNCTIONALITY.
- 2. A TYPICAL COMM DISTRIBUTION CABINET IS DEPICTED INTERFACED TO TYPICAL EQUIPMENT, INTERFACE TERMINAL CABINETS AND CONTROL PANELS.
- 3. SEE SOUND TRANSIT "LIGHT RAIL EQUIPMENT AND FACILITIES NUMBERING PLAN" FOR EQUIPMENT AND POINT I.D. NAMING STANDARDS AND CONVENTIONS
- 4. CONTRACTOR SHALL PROVIDE ITC CABINET, TERMINAL BLOCKS, CONDUIT AND CABLING BETWEEN ITC CABINET AND CONTRACTOR PROVIDED FIELD EQUIPMENT.
- 5. DISCRETE I/O CONTRACTOR PROVIDED EQUIPMENT.

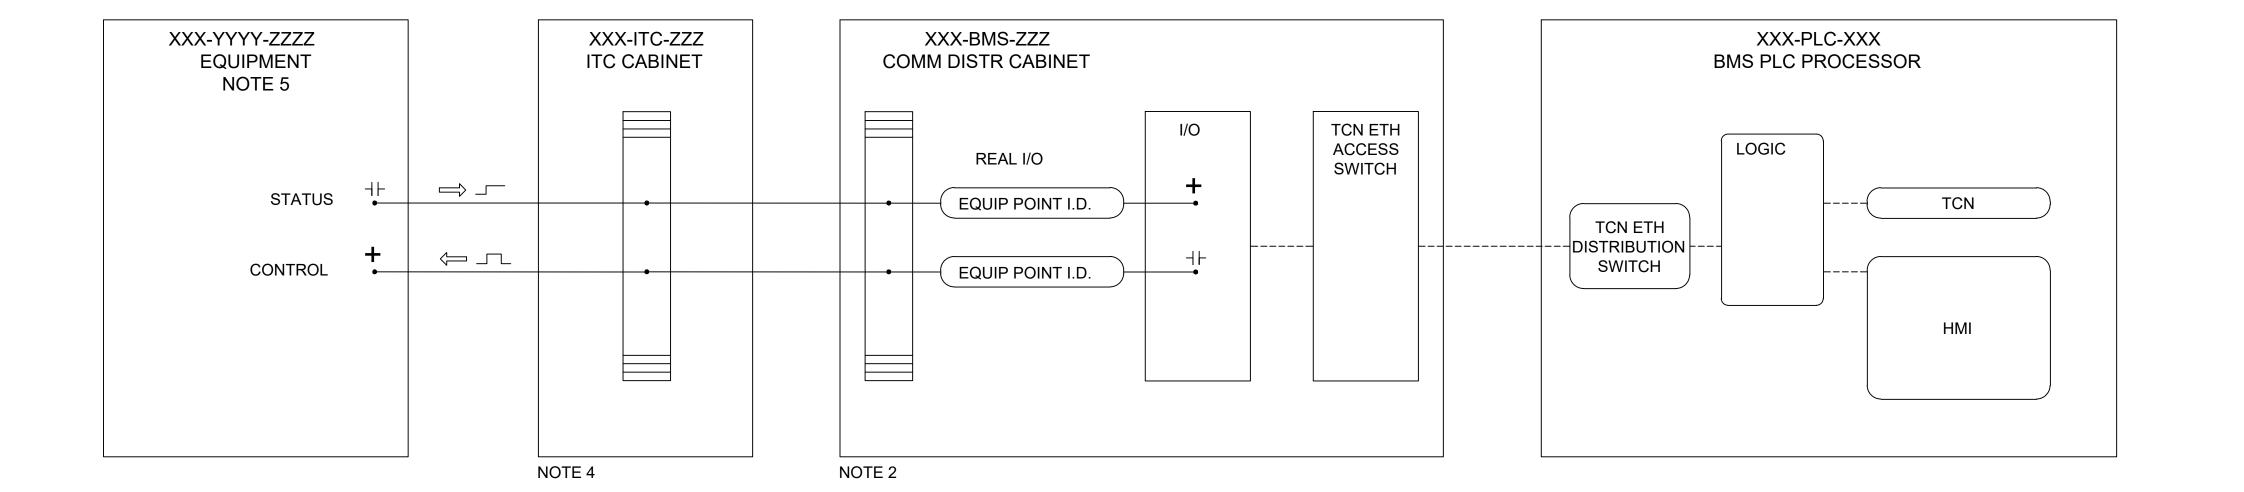

PRELIMINARY ENGINEERING

NOT FOR CONSTRUCTION

Refer to the plan set COVER drawing for disclaimers regarding this drawing.

REFERENCE CONCEPT DRAWINGS Z. ZHANG DRAWN BY: CHECKED BY: M. STAHLEY APPROVED BY J. SCHIMPF CHK APP REVISION

PABLO LOPEZ-HILFIKER

AHJ:

Burns TWO COMMERCE SQUARE, 2001 MARKET ST, SUITE 600 PHILADELPHIA, PA 19103

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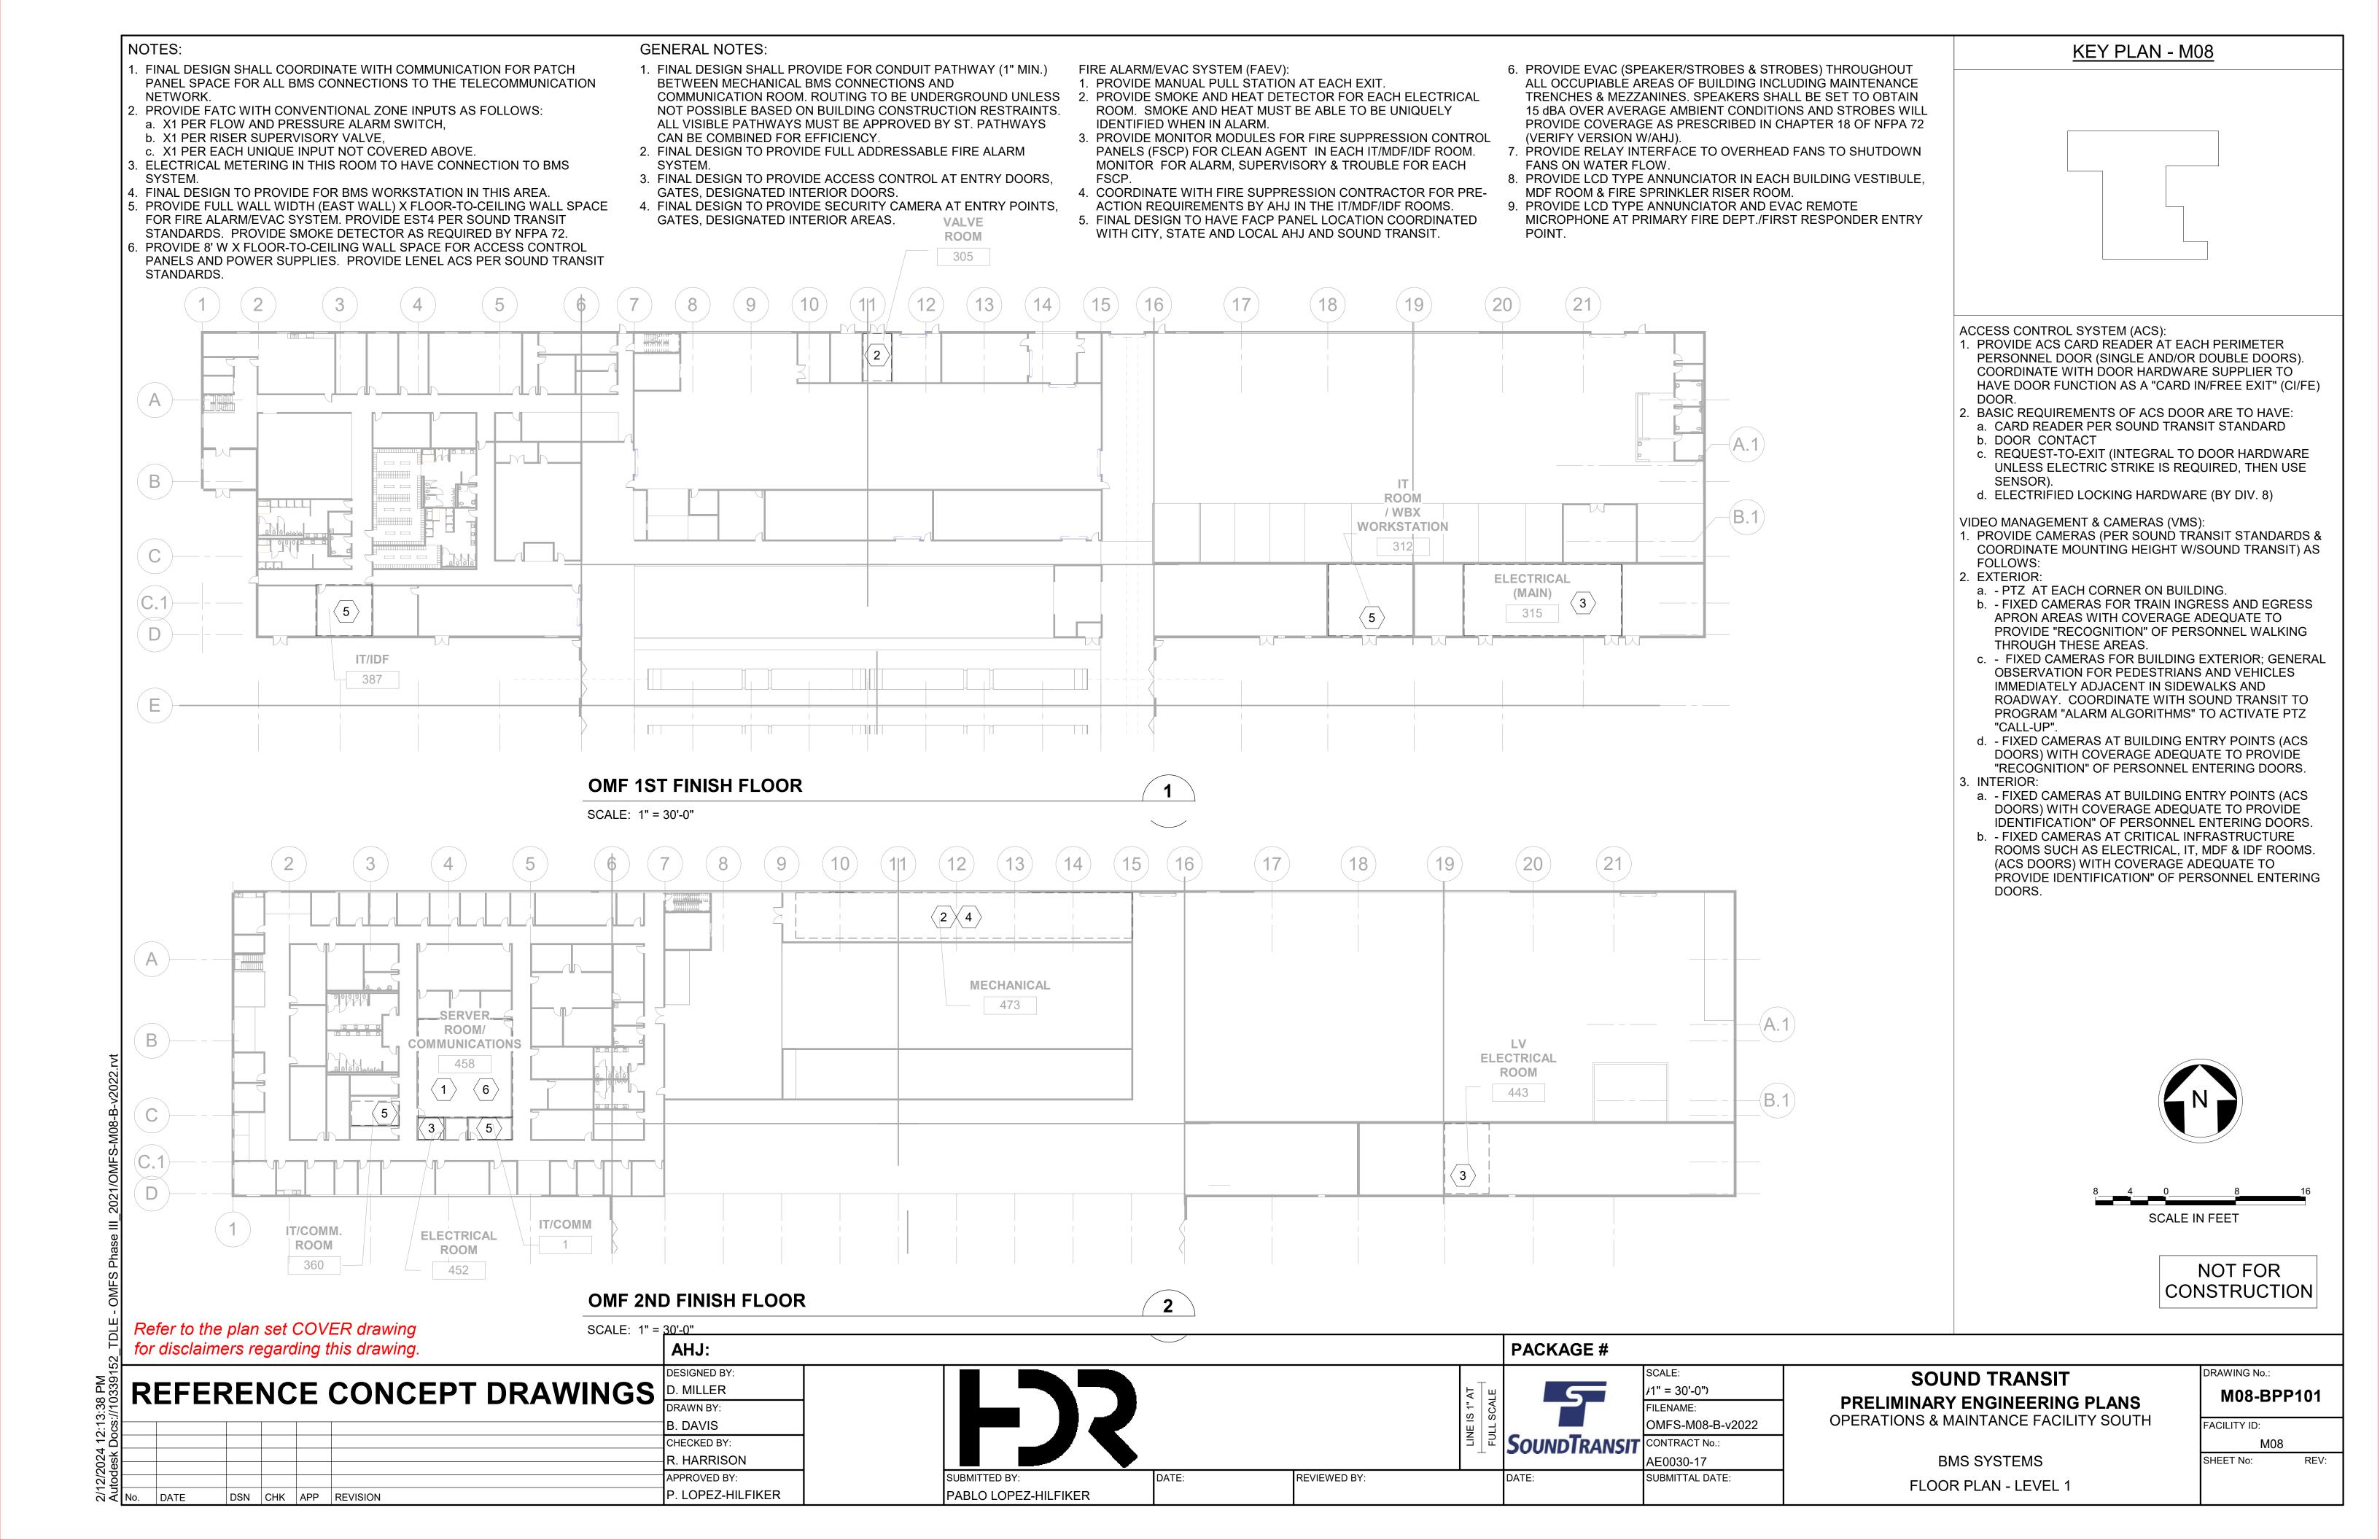
> COMMUNICATION SYSTEM **BUILDING MANAGEMENT SYSTEM** INTERFACE DIAGRAM


RAWING No.: Y03-JBS001

FACILITY ID:

SHEET No.:

Y03



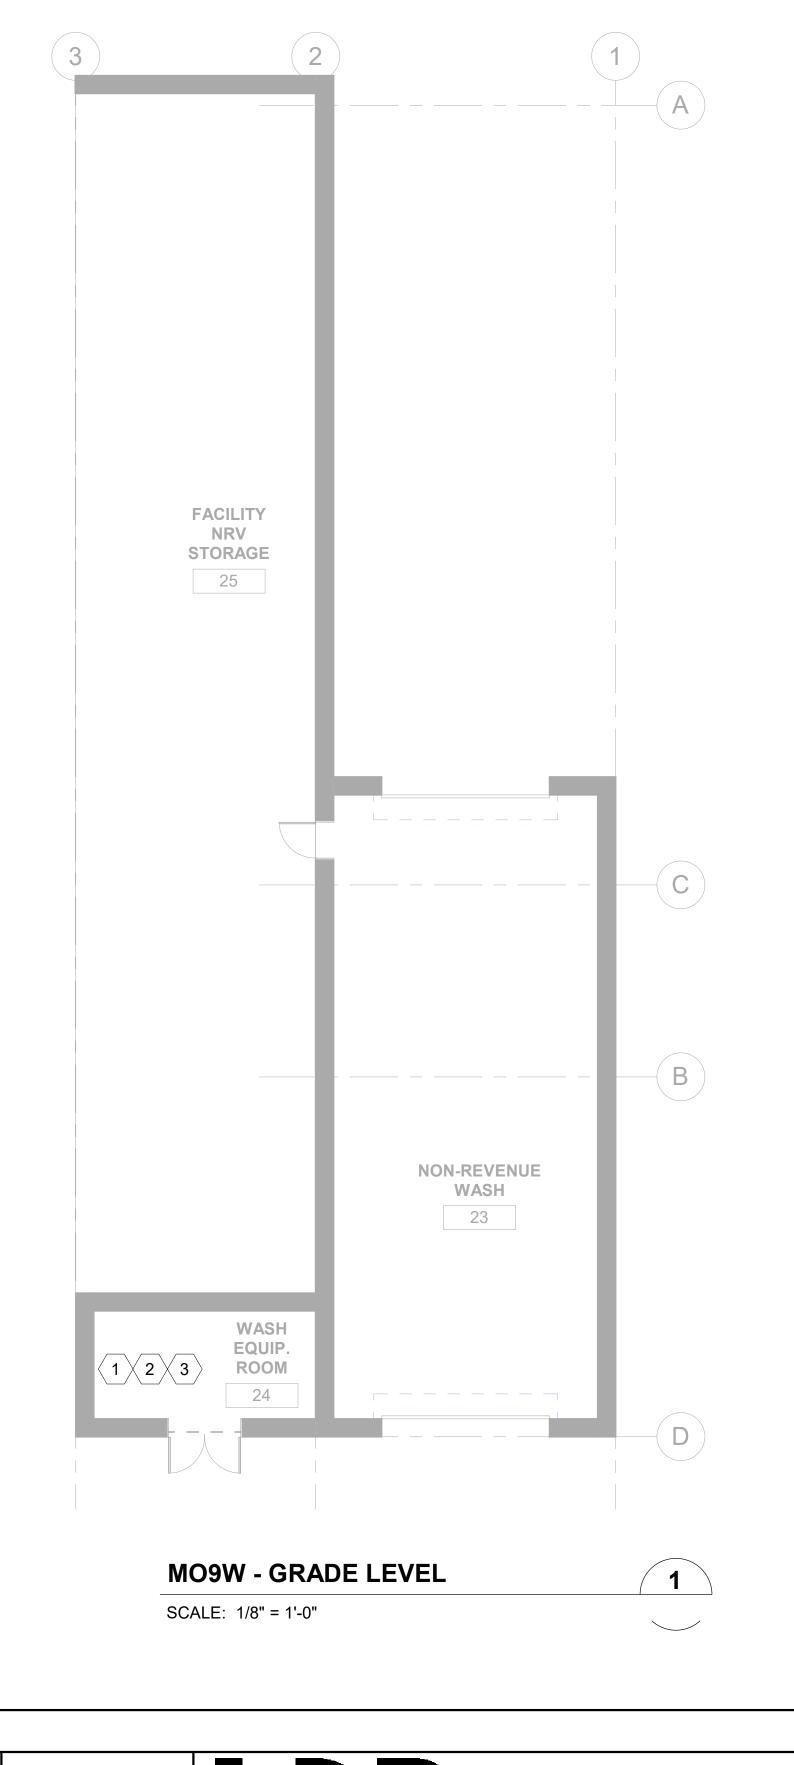

GENERAL NOTES:

- 1. FINAL DESIGN SHALL PROVIDE FOR CONDUIT PATHWAY (1" MIN.) BETWEEN MECHANICAL BMS CONNECTIONS AND COMMUNICATION ROOM. ROUTING TO BE UNDERGROUND UNLESS NOT POSSIBLE BASED ON BUILDING CONSTRUCTION RESTRAINTS. ALL VISIBLE PATHWAYS MUST BE APPROVED BY ST. PATHWAYS CAN BE COMBINED FOR EFFICIENCY.
- 2. FINAL DESIGN TO PROVIDE FULL ADDRESSABLE FIRE ALARM
- 3. FINAL DESIGN TO PROVIDE ACCESS CONTROL AT ENTRY DOORS, GATES, DESIGNATED INTERIOR DOORS.
- 4. FINAL DESIGN TO PROVIDE SECURITY CAMERA AT ENTRY POINTS, GATES, DESIGNATED INTERIOR AREAS.

FIRE ALARM/EVAC SYSTEM (FAEV):

- 1. PROVIDE MANUAL PULL STATION AT EACH EXIT.
- 2. PROVIDE SMOKE AND HEAT DETECTOR FOR EACH ELECTRICAL ROOM. SMOKE AND HEAT MUST BE ABLE TO BE UNIQUELY IDENTIFIED WHEN IN ALARM.
- 3. PROVIDE MONITOR MODULES FOR FIRE SUPPRESSION CONTROL PANELS (FSCP) FOR CLEAN AGENT IN EACH IT/MDF/IDF ROOM. MONITOR FOR ALARM, SUPERVISORY & TROUBLE FOR EACH
- 4. COORDINATE WITH FIRE SUPPRESSION CONTRACTOR FOR PRE-ACTION REQUIREMENTS BY AHJ IN THE IT/MDF/IDF ROOMS.
- 5. FINAL DESIGN TO HAVE FACP PANEL LOCATION COORDINATED WITH CITY, STATE AND LOCAL AHJ AND SOUND TRANSIT. 6. PROVIDE EVAC (SPEAKER/STROBES & STROBES) THROUGHOUT
- ALL OCCUPIABLE AREAS OF BUILDING INCLUDING MAINTENANCE TRENCHES & MEZZANINES. SPEAKERS SHALL BE SET TO OBTAIN 15 dBA OVER AVERAGE AMBIENT CONDITIONS AND STROBES WILL PROVIDE COVERAGE AS PRESCRIBED IN CHAPTER 18 OF NFPA 72 (VERIFY VERSION W/AHJ).
- 7. PROVIDE RELAY INTERFACE TO OVERHEAD FANS TO SHUTDOWN FANS ON WATER FLOW.
- 8. PROVIDE LCD TYPE ANNUNCIATOR IN EACH BUILDING VESTIBULE, MDF ROOM & FIRE SPRINKLER RISER ROOM.
- 9. PROVIDE LCD TYPE ANNUNCIATOR AND EVAC REMOTE MICROPHONE AT PRIMARY FIRE DEPT./FIRST RESPONDER ENTRY

ACCESS CONTROL SYSTEM (ACS):

- 1. PROVIDE ACS CARD READER AT EACH PERIMETER PERSONNEL DOOR (SINGLE AND/OR DOUBLE DOORS). COORDINATE WITH DOOR HARDWARE SUPPLIER TO HAVE DOOR FUNCTION AS A "CARD IN/FREE EXIT" (CI/FE) DOOR.
- 2. BASIC REQUIREMENTS OF ACS DOOR ARE TO HAVE:
- a. CARD READER PER SOUND TRANSIT STANDARD b. DOOR CONTACT
- c. REQUEST-TO-EXIT (INTEGRAL TO DOOR HARDWARE UNLESS
- ELECTRIC STRIKE IS REQUIRED, THEN USE SENSOR).
- d. ELECTRIFIED LOCKING HARDWARE (BY DIV. 8)


VIDEO MANAGEMENT & CAMERAS (VMS):

- 1. PROVIDE CAMERAS (PER SOUND TRANSIT STANDARDS & COORDINATE MOUNTING HEIGHT W/SOUND TRANSIT) AS FOLLOWS:
- 2. EXTERIOR:
- a. PTZ AT EACH CORNER ON BUILDING.
- b. FIXED CAMERAS FOR TRAIN INGRESS AND EGRESS APRON AREAS WITH COVERAGE ADEQUATE TO PROVIDE "RECOGNITION" OF PERSONNEL WALKING THROUGH THESE AREAS.
- c. FIXED CAMERAS FOR BUILDING EXTERIOR; GENERAL OBSERVATION FOR PEDESTRIANS AND VEHICLES IMMEDIATELY ADJACENT IN SIDEWALKS AND ROADWAY. COORDINATE WITH SOUND TRANSIT TO PROGRAM "ALARM ALGORITHMS" TO ACTIVATE PTZ "CALL-UP".
- d. FIXED CAMERAS AT BUILDING ENTRY POINTS (ACS DOORS) WITH COVERAGE ADEQUATE TO PROVIDE "RECOGNITION" OF PERSONNEL ENTERING DOORS.

3. INTERIOR:


- a. FIXED CAMERAS AT BUILDING ENTRY POINTS (ACS DOORS) WITH COVERAGE ADEQUATE TO PROVIDE IDENTIFICATION" OF PERSONNEL ENTERING DOORS.
- b. FIXED CAMERAS AT CRITICAL INFRASTRUCTURE ROOMS SUCH AS ELECTRICAL, IT, MDF & IDF ROOMS. (ACS DOORS) WITH COVERAGE ADEQUATE TO PROVIDE IDENTIFICATION" OF PERSONNEL ENTERING DOORS

KEY PLAN - M09W

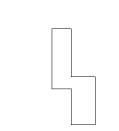

NOTES:

- 1. FINAL DESIGN SHALL COORDINATE WITH COMMUNICATION FOR PATCH PANEL SPACE FOR ALL BMS CONNECTIONS TO THE TELECOMMUNICATION NETWORK.
- 2. PROVIDE FATC WITH CONVENTIONAL ZONE INPUTS AS FOLLOWS:
 - a. X1 PER FLOW AND PRESSURE ALARM SWITCH,
- b. X1 PER RISER SUPERVISORY VALVE.
- c. X1 PER EACH UNIQUE INPUT NOT COVERED ABOVE.
- 3. ELECTRICAL METERING IN THIS ROOM TO HAVE CONNECTION TO BMS SYSTEM.

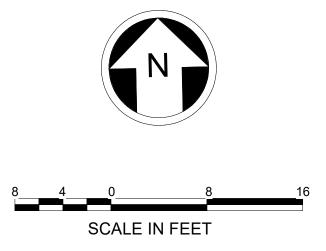

NOT FOR CONSTRUCTION

Refer to the plan set COVER drawing for disclaimers regarding this drawing.

AHJ: **DESIGNED BY** REFERENCE CONCEPT DRAWINGS D.MILLER DRAWN BY: B.DAVIS CHECKED BY: R.HARRISON APPROVED BY: P. LOPEZ-HILFIKER DSN CHK APP REVISION

DATE:

PABLO LOPEZ-HILFIKER

REVIEWED BY:

SoundTransit

PACKAGE #

*I*1/8" = 1'-0" FILENAME: OMFS-M09W-B-v2022 CONTRACT No.: AE0030-17

SUBMITTAL DATE:

SOUND TRANSIT PRELIMINARY ENGINEERING PLANS **OPERATIONS & MAINTANCE FACILITY SOUTH**

FACILITY ID:

BMS SYSTEMS FLOOR PLAN - LEVEL 1 DRAWING No.: M09W-BPP101

M09W SHEET No:

